City of Saginaw



Meeting and/or Executive Session Agenda

Tuesday, October 15, 2024, 6:00 PM 333 West McLeroy Boulevard Saginaw, Texas 76179

In accordance with Section 551.043 of the Texas Government Code, this agenda has been posted at Saginaw City Hall, and distributed to the appropriate news media within the required time frame. All meetings of the Saginaw City Council are open to the public. Public participation and written comments are invited on all open session business items.

The Mayor and City Council request that all cell phones and pagers be turned off or set to vibrate. Members of the audience are requested to step outside to respond to a page or to conduct a phone conversation. The City Hall is wheelchair accessible and special parking is available on the east side of the building. If special accommodations are required please contact the City Secretary a minimum of 72 hours in advance at 817-232-4640.

1. Call To Order

- 1A. Call To Order -- Todd Flippo, Mayor
- 1B. Pledges--Pledge of Allegiance to the United States; Pledge of Allegiance to the State of Texas--"Honor the Texas Flag; I pledge allegiance to thee, Texas, one State under God, one and indivisible"
- 1C. Invocation--Pastor Ronnie Mills, Saginaw Family Bible Church
- 1D. Audience Participation--Anyone wishing to speak during the discussion of an item listed on the agenda must complete an audience participation form. These forms are located by the Police Chief. After completing the form, give it to the City Secretary. She will give it to the Mayor. The Mayor will call on you when that item is discussed. You will have three (3) minutes to make your comments.

2. Consent Agenda

All items listed are part of the Consent Agenda. Public hearing and review are held collectively unless opposition is presented, in which case the contested item will be heard separately.

- 2A. Action regarding Minutes, October 1, 2024--Janice England, City Secretary
- 2B. Action Regarding Approval of Amendment No. 1 to the Interlocal Agreement with Tarrant County for Old Decatur Road North Roadway Improvements. -- Lee Howell, Asst. City Manager
- 2C. Action Regarding Dedication of Utility Easements by Separate Instrument to Juan Armendaris Survey Abstract No. 59, City of Saginaw, Tarrant County--Lee Howell, Asst. City Manager
- 2D. Action Regarding the Purchase of a Mower for the Drainage Department--Randy Newsom, Director of Public Works
- 2E. Action Regarding the Softball Complex Fence Repairs--Randy Newsom, Director of Public Works
- 2F. Action Regarding the Purchase of a New Gymnasium Floor for the Recreation Center--Keith Rinehart, Director of Community & Economic Development
- 2G. Action Regarding the Purchase of a Storage Building to Provide Equipment Storage for the Recreation Center--Keith Rinehart, Director of Community & Economic Development

3. Proclamations-Presentations

3A. Employee Recognitions/Presentations--Gabe Reaume, City Manager

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- 3B. Community Presentation--Family, Career and Community Leaders of America (FCCLA)--Maggie Henderson, Region II Vice President of Texas State Association of FCCLA
- 3C. Presentation of the 212 Program--Jarred Coursey, Assistant Director of Public Works
- 3D. Presentation Regarding the Remodeling of the John Ed Keeter Library--Jarred Coursey, Asst. Public Works Director

4. Business

4A. Consideration and Action regarding City Council Meeting scheduled for November 5, 2024, Election Day--Janice England, City Secretary

5. Executive Session

The City Council may take action on any Executive Session item posted.

5A. 551.071. Texas Government Code. Consultation with Attorney. The City Council may convene in executive session to conduct a private consultation with its attorney on any legally posted item, when the City Council seeks the advice of its attorney about pending or contemplated litigation, a settlement offer, or on a matter in which the duty of the attorney to the governmental body under the Texas Disciplinary Rules of Professional Conduct of the State Bar of Texas clearly conflicts with the provisions of Chapter 551, including the following items:

5B. Any Posted Item

6. Adjournment

6A. Adjournment--Todd Flippo, Mayor

Date Posted: October 10, 2024



Prepared By: Janice England

A. Action regarding Minutes, October 1, 2024--Janice England, City Secretary

Meeting	Agenda Group			
Tuesday, October 15, 2024, 6:00 PM	Consent Agenda Item: 2A.			
Reference File				
Community Goals				

BACKGROUND/DISCUSSION:

The minutes of the City Council Meeting held on October 1, 2024 are presented for consideration.

FINANCIAL IMPACT:

N/A

RECOMMENDATION:

Staff recommends approval.

Attachments

Draft Minutes--October 1 2024.pdf

** The following document is a draft of the minutes and the not the official approved minutes **

City of Saginaw

Minutes for the City Council

Held on October 1, 2024

333 West McLeroy Boulevard, Saginaw, Texas 76179

Present at the Meeting:

- Todd Flippo, Mayor
- Paul Felegy, Mayor Pro-Tem, Place 1
- Nick Lawson, Place 2
- Valerie Junkersfeld, Place 3
- Brack St. Clair, Place 4
- Cindy Bighorse, Place 5
- Mary Copeland, Place 6
- Bryn Meredith, City Attorney
- Gabe Reaume, City Manager
- Lee Howell, Asst. City Manager
- Kim Quin, Finance Director
- Elizabeth Thorp, Finance Manager
- Janice England, City Secretary
- Russell Ragsdale, Police Chief
- Corey Burnett, Police Lieutenant
- Doug Spears, Fire Chief
- Randy Newsom, Director of Public Works
- Keith Rinehart, Director of Community & Economic Development
- Melanie McManus, Director of Human Resources
- Ellen Ritchie, Library Director
- Pedro Zambrano, Communications Manager

Absent from the Meeting:

Trenton Tidwwell, P.E., City Engineer

Visitors at the Meeting:

- Judy Deller
- Michael Hill
- Fred Besco
- Glenn Reeves

- Jeree Reames
- David Reames
- Dale Reed
- Pastor Mark Towns
- Ronnie Horton
- Matt Regan
- John Gant
- Duane Mann
- Kristi Dean
- Jana Marsh
- Cpl. Rodriguez
- Sgt. Gonzalez
- Cpl. Osteen
- Mattie Osteen
- Ofcr. Soriano
- Ofcr. Renner
- Ofcr. Barber

1. Call To Order

1A. Call To Order--Todd Flippo, Mayor

Mayor Flippo called the meeting to order at 6:00 p.m.

- 1B. Pledges--Pledge of Allegiance to the United States; Pledge of Allegiance to the State of Texas--"Honor the Texas Flag; I pledge allegiance to thee, Texas, one State under God, one and indivisible"
- 1C. Invocation--Dr. Mark Towns, First Baptist Church
- Dr. Mark Towns gave the invocation.
- 1D. Audience Participation--Anyone wishing to speak during the discussion of an item listed on the agenda must complete an audience participation form. These forms are located by the Police Chief. After completing the form, give it to the City Secretary. She will give it to the Mayor. The Mayor will call on you when that item is discussed. You will have three (3) minutes to make your comments.

2. Consent Agenda

Motion was made by Councilmember Junkersfeld with a second by Mayor Pro-Tem Felegy to approve the Consent Agenda as presented. 7-0-0-0

2A. Action regarding Minutes, September 17, 2024--Janice England, City Secretary

2B. Action regarding Minutes, September 23, 2024--Joint Workshop--City Council & Advisory Recreation & Parks Board--Janice England, City Secretary

2C. Action regarding Ordinance No. 2024-23, Industrial Waste Ordinance Amendment--Matt Regan, Environmental/Drainage Manager

The Fort Worth City Council amended their Pretreatment Program with approval from the Texas Commission on Environmental Quality (TCEQ). Each Fort Worth Wholesale Customer City is required to modify their ordinance to meet the obligations of the Pretreatment Program by October 31, 2024. Newly adopted changes in the ordinance require industrial customers found to have wastewater containing PFAS (Per- and Poly-Fluoroalkyl Substances) compounds above the background level of 25 ng/L (established from the collection system monitoring) to implement a PFAS Management Plan for Significant Industrial Users (SIUs) for identifying and eliminating sources of these substances within one year of PFAS detection and notification. Proposed Ordinance No. 2024-23 addresses the required amendments. It has been reviewed by the City Attorney.

2D. Action regarding the 2024 Holiday Event Drone Show -- Pedro Zambrano, Communications Manager

The Advisory Recreation & Parks Board unanimously voted to recommend the use of \$24,000 from the Parks Donation Fund for a drone show by FlyLight Drones, LLC after the parade and tree lighting ceremony. The show will include a brand new design lasting ten to twelve minutes with a total of 250 drones. This is the same cost as the 2023 show.

2E. Action regarding amendment to STW, Inc/OpenGov Software Agreement--Kim Quin, Finance Director

The City has used financial management software provided by STW, Inc. (purchased by OpenGov) for many years. The latest agreement approved by the City Council on November 5, 2019 was for the period of 10/01/2019 through 9/30/2024. We have been notified that the current software is being phased out. The City will have to convert to the cloud based OpenGov software or change software vendors. The proposed amendment extends the current software agreement by one year to allow staff to evaluate and plan for conversion to a new software system. The cost is \$18,033.75 and is included in the Fiscal Year 2024/2025 budget.

3. Proclamations-Presentations

3A. Employee Recognitions/Presentations- Gabe Reaume, City Manager

Police Chief Ragsdale recognized Corporal Will Osteen who was promoted to his position earlier this year. A ceremonial badge pinning by Mattie Osteen, Corporal Osteen's wife, followed.

Police Lieutenant Burnett recognized the many volunteers from the Community Emergency Response Team (CERT), and the Citizen's Police Academy Alumni Association (CPAAA) as well as Police Department employees that assisted with the July 4th event. He expressed his appreciation for their assistance. He presented Certifications of Appreciation to the volunteers and Certificates of Commendation to the employees.

3B. Proclamation--Saginaw Day of Prayer, October 18, 2024--Todd Flippo, Mayor Councilmember Junkersfeld read a proclamation declaring Friday, October 18, 2024 to be "Saginaw Day of Prayer".

4. Business

4A. Discussion of Debt Capacity--Kim Quin, Finance Director

Finance Director Quin gave a presentation on the City's debt capacity as well as the effect of any additional debt issued before 2034 on the tax rate. Future bond elections as well as other considerations regarding future debt issuance and factors that would affect the tax rate were discussed.

4B. Consideration and Action regarding Chapter 380 Economic Development Agreement with Fuel City Saginaw, LLC--Randy Newsom, Director of Public Works, & Keith Rinehart, Director of Community & Economic Development

Director of Public Works Newsom explained that the proposed Chapter 380 Economic Development Agreement is with Fuel City Saginaw, LLC. The agreement will incentivize Fuel City to maximize their sales tax receipts, which they believe will increase as a direct result of the future improvement of the intersection of Blue Mound Road and Industrial Blvd. Fuel City Saginaw, LLC hired a third party consultant and project manager to secure Texas Department of Transportation funding to make this project happen. The agreement will rebate 1% of sales tax collections back to Fuel City Saginaw, LLC each year for five years, up to a not-to-exceed amount of \$250,000 until 2029. The sales tax collections for 2024 will serve as a base year, so Fuel City Saginaw, LLC must bring in receipts higher than 2024 in order to receive any reimbursement.

Motion was made by Councilmember Lawson with a second by Councilmember Junkersfeld to approve the Chapter 380 Economic Development Agreement with Fuel City Saginaw, LLC as

presented. Motion carried unanimously. 7-0-0-0

4C. Consideration and Action regarding the addition of a Public Comment Item to Future City Council Agendas--Bryn Meredith, City Attorney

The addition of a public comment item to future City Council agendas was discussed. City Attorney Meredith explained the various options to consider. Following discussion, the consensus of the City Council was to appoint a Sub Committee of three Councilmembers to review the options and make a recommendation to the City Council at a future meeting. Any Councilmembers interested in serving on the Sub Committee were asked to contact the Mayor.

4D. Discussion/Presentation of City Manager End of Fiscal Year Performance Review from 9/17/2024 City Council Meeting--Gabe Reaume, City Manager

City Manager Reaume reviewed the feedback from his recent End of Fiscal Year Performance Review. He added that he wanted staff to be aware of the comments.

5. Executive Session

Mayor Flippo declared the meeting recessed into Executive Session at 7:13 p.m.

5A. 551.071. Texas Government Code. Consultation with Attorney. The City Council may convene in executive session to conduct a private consultation with its attorney on any legally posted item, when the City Council seeks the advice of its attorney about pending or contemplated litigation, a settlement offer, or on a matter in which the duty of the attorney to the governmental body under the Texas Disciplinary Rules of Professional Conduct of the State Bar of Texas clearly conflicts with the provisions of Chapter 551, including the following items:

5B. Any Posted Item

5C. 551.074 Texas Government Code. Personnel Matters. The City Council may convene in executive session to deliberate the appointment, employment, evaluation, reassignment, duties, discipline, or dismissal of a public officer or employee; or to hear a complaint or charge against an offer or employee, including deliberation regarding the following officers or employees:

5D. 2023/2024 City Manager End of Fiscal Year Performance Review

Mayor Flippo declared the meeting back in Regular Session at 7:52 p.m.

6. Adjournment

6A. Adjournment--Todd Flippo, Mayor

Motion was made by Councilmember St. Clair with a second by Councilmember Felegy to adjourn the meeting. Motion carried unanimously. 7-0-0-0

Mayor Flippo declared the October 1, 2024 City Council Meeting adjourned at 7:53 p.m.



Prepared By: Janice England

B. Action Regarding Approval of Amendment No. 1 to the Interlocal Agreement with Tarrant County for Old Decatur Road North Roadway Improvements. -- Lee Howell, Asst. City Manager

Meeting	Agenda Group		
Tuesday, October 15, 2024, 6:00 PM	Consent Agenda Item: 2B.		
Reference File			
Community Goals			

BACKGROUND/DISCUSSION:

The City and Tarrant County previously entered into an Interlocal Agreement for financial support of up to \$300,000.00 for the cooperative funding of improvements to Old Decatur Road. The City requested consideration of additional funding. Precinct 4 Commissioner Ramirez agreed to provide additional assistance of \$150,000.00 through the Tarrant County 2006 Transportation Bond Program. This would bring the Tarrant County contribution for this ILA to a "not to exceed" total of \$450,000.00 on a reimbursement basis of actual eligible project costs. Approval of this item would also extend the term of the ILA to September 30, 2025. (See attached original executed ILA for reference.)

The City of Fort Worth has been contacted to participate in this project and a response is pending.

FINANCIAL IMPACT:

Funds provided from this ILA are included in the Saginaw FY 2024-2025 adopted budget, Capital Projects Fund (line item 06-1502-45-00). Also included in the budget for Old Decatur improvements are funds previously obtained by reimbursement from Tarrant County on Knowles Phase 1. Additional funding would be provided through an anticipated bond sale in 2025 Capital Projects Fund (06-1502-25-00). Total expenditures needed on this project for FY 24-25 are estimated at \$2,613,625.00.

RECOMMENDATION:

Staff recommends approval.

Attachments

2006 TBP ILA Amedment No. 1_Old Decatur North (150k from Pct 4 Disc added) FINAL.pdf Old-Decatur-Rd-North-Improvements-Funding-ILA-FINAL-120622.pdf

STATE OF TEXAS	§	
	§	Amendment No. 1 to the Interlocal Agreement
	§	for Old Decatur Road North Roadway Improvements
COUNTY OF TARRANT	§	

BACKGROUND

Tarrant County ("COUNTY") and the City of Saginaw ("CITY") entered into an Interlocal Agreement approved by Tarrant County Commissioners Court Order No. 139866, for financial support of up to \$300,000.00, for the cooperative funding of improvements to Old Decatur Road from Bailey Boswell Road to south of the Saginaw/Saginaw city limit line ("Project") as described in the 2006 Tarrant County Bond Program.

The city has requested to amend the Interlocal Agreement (ILA) with additional funding assistance of \$150,000.00 and to extend the term of the project. The Precinct 4 Commissioner has agreed to provide the additional funding through the 2006 TBP, Pct 4 Discretionary funds, and to extend the agreement Term as shown in Article III.

Therefore, the COUNTY and CITY agree to the following revisions. Paragraphs III, IV, and V from the original Interlocal Agreement are repealed and replaced with the following language:

III. TERM

This ILA shall become effective upon the approval of both parties and shall terminate on September 30, 2025, unless terminated as described in Section XII in the original ILA or extended in writing and approved by both parties.

IV. FISCAL FUNDING ACKNOWLEDGEMENT

Tarrant County bond funds will be encumbered on a fiscal year basis in accordance with the Certification of Available Funds shown herein. In the event no funds or insufficient funds are appropriated and budgeted or are otherwise unavailable by any means whatsoever in any fiscal period for payments due under this ILA Amendment, then the affected party will immediately notify the other party of such occurrence and this Amendment may be terminated on the last day of the fiscal period for which appropriations were received without penalty or expense to the affected party of any kind whatsoever, except to the portions of annual payments herein agreed upon for which funds shall have been appropriated.

V. REIMBURSEMENT PROCESS

The COUNTY agrees to reimburse the CITY for the actual eligible PROJECT costs in an amount not to exceed \$450,000.00. Any reimbursement request from the CITY should include: 1) a copy

of the invoice or billing for design services, right-of-way acquisition purchase, and construction; and 2) a copy of the check, a certification letter, or other documentation to verify the CITY's proof of payment. The final reimbursement payment to the CITY will be contingent upon the City Manager or Mayor providing written notification to the COUNTY that the project is complete along with identification of final project costs. COUNTY bond funds for the Project are allocated as follows:

County Payment by Phase*

 Design:
 \$0.00

 ROW Acquisition:
 \$0.00

 Construction:
 \$450,000.00

 TOTAL:
 \$450,000.00

TBP Funding Category: 2006, Pct 4 Discretionary

* Reimbursement payments will be issued by the COUNTY for eligible expenses incurred during the Fiscal Year for which bond funds are certified by the Tarrant County Auditor.

The CITY understands that the CITY will be responsible for cost overruns and any other expenses incurred by the CITY in performing the services described herein. The CITY agrees that the COUNTY retains control over when reimbursement payments will be disbursed to the CITY.

In addition to the foregoing replacement language, Attachment A is removed and deleted from the original Interlocal Agreement in full. All other paragraphs, terms and language outside of paragraphs III, IV, and V as well as Attachment A remain unchanged and in effect.

APPROVED on this day the	_ day of	, 2024, by Tarrant County.
	Comm	nissioners Court Order No.
TARRANT COUNTY, TEXAS		CITY OF SAGINAW
Tim O'Hare, County Judge		Todd Flippo, Mayor
Manny Ramirez, Commissioner, Precin	nct 4	

APPROVED AS TO FORM:	
Criminal District Attorney's Office*	City Attorney
	City Secretary (If applicable)
* By law, the Criminal District Attorney's Office mathis document as to form from our client's legal per Instead, those parties should seek contract review fr	spective. Other parties may not rely on this approval.
CERTIFICATION OF AVAILABLE FUN	NDS IN THE AMOUNT OF:
\$ as follows:	
Fiscal year ending September 30, 2025:	\$150,000.00, 2006 TBP Precinct 4 Discretionary
Auditor's Office	

STATE OF TEXAS § Funding Interlocal Agreement

for Old Decatur Road North Roadway Improvements

COUNTY OF TARRANT § (Construction Phase)

This Funding Interlocal Agreement (ILA) is entered into between Tarrant County, Texas, hereinafter referred to as COUNTY, and the City of Saginaw, hereinafter referred to as CITY, and collectively referred to as the "parties", for the purpose of providing financial support of up to \$300,000.00 in Precinct 4 discretionary funds through the 2006 Tarrant County Transportation Bond Program (TBP) to a needed transportation project which both parties find serves a public purpose and promotes the public welfare of the citizens of Tarrant County.

The COUNTY and the CITY make the following findings of fact:

- 1. This Funding ILA is made pursuant to Chapter 791 of the Texas Government Code;
- 2. To the extent necessary the parties will use current revenues to pay obligations in this Funding ILA;
- 3. The project benefits the public in that it is a needed transportation project;
- 4. The COUNTY and the CITY each has the legal authority to perform its obligations in this Funding ILA;
- 5. The division of costs provided in this Funding ILA constitute adequate consideration to each party; and
- 6. Both parties acknowledge they are each a "governmental entity" and not a "business entity" as those terms are defined in Texas Government Code Section 2252.908, and therefore, no disclosure of interested parties is required.

I. PROJECT DESCRIPTION

This project, hereinafter referred to as the "Project", will consist of the reconstruction of Old Decatur Road from asphalt to concrete and widened to five lanes at the intersection with West Bailey Boswell Road and then transitioning to three lanes for approximately 1,400 linear feet to just south of the Saginaw/Fort Worth city limit line. Other improvements will include internal storm drain and major culvert crossings, water line relocations, sanitary sewer adjustments, illumination, pavement markings and signage, and traffic signal modifications.

II. SCOPE OF SERVICES PROVIDED BY CITY

The services to be provided by the CITY shall include, but are not limited to, the following:

- A. All total project costs, including all construction, right of way acquisition, utility relocation, engineering, planning, surveying, and governmental approval costs (collectively referred to as "Costs");
- B. Construction agreement administration, site review, permitting, and inspection;
- C. Interagency cooperation;
- D. A detailed schedule of the project shall be provided to the COUNTY; and
- E. The CITY will notify the COUNTY of completion of the Project.

III. TERM

This Funding ILA shall become effective upon the approval of both parties and shall expire on September 30, 2024 unless terminated as described in Section XIII in this Funding ILA or extended in writing and approved by both parties.

IV. FISCAL FUNDING ACKNOWLEDGEMENT

In the event no funds or insufficient funds are appropriated and budgeted or are otherwise unavailable by any means whatsoever in any fiscal period for payments under this Funding ILA, then the affected party will immediately notify the other party of such occurrence and this Funding ILA shall be terminated on the last day of the fiscal period for which appropriations were received without penalty or expense to the affected party of any kind whatsoever, except to the portions of payments herein agreed upon for which funds shall have been appropriated.

V. COST

The COUNTY agrees to reimburse the CITY for eligible construction expenses required for the Project in an amount not to exceed \$300,000.00 in accordance with the reimbursement payment schedule in Attachment A. Any reimbursement request from the CITY should include: 1) a copy of the contractor's invoice; 2) a copy of the contractor's progress report or the latest project schedule; and 3) a copy of the check, certification letter, or other documentation to verify the CITY's proof of payment to the contractor.

The CITY understands that the CITY will be responsible for cost overruns of the Project and for other expenses incurred by the CITY in performing the services under this Funding ILA.

VI. AGENCY-INDEPENDENT CONTRACTOR

Neither the COUNTY nor any employee thereof is an agent of the CITY, and neither the CITY

nor any employee thereof is an agent of the COUNTY. This Funding ILA does not and shall not be construed to entitle either party or any of their respective employees, if applicable, to any benefit, privilege or other amenities of employment by the other party.

The COUNTY will have no right to control the manner or means of construction of the Project.

VII. ASSIGNMENT

Neither party may assign, in whole nor in part, any interest it may have in this Funding ILA without the prior written consent of the other party.

VIII. THIRD-PARTY BENEFICIARY EXCLUDED

No person other than a party to this Funding ILA may bring a cause of action pursuant to this Funding ILA as a third-party beneficiary. This Funding ILA may not be interpreted to waive the sovereign or governmental immunity of any party to this Funding ILA to the extent such party may have immunity under Texas law.

IX. AUDIT OF RECORDS

The CITY's records regarding this Project shall be subject to audit by the COUNTY during the term of this Funding ILA and for two years after the completion of the Project.

X. ENTIRE AGREEMENT

This Funding ILA represents the entire understanding of and between the parties and superseded all prior representations. This Funding ILA may not be varied orally but must be amended by written document of subsequent date duly executed by these parties.

XI. <u>VENUE</u>

This Funding ILA shall be governed by the laws of the State of Texas and venue for any action under this Funding ILA shall be in the district courts of Tarrant County, Texas.

XII. SCHEDULING

The CITY agrees that the COUNTY retains control over the reimbursement payment schedule in Attachment A. The COUNTY agrees to notify the CITY of any changes to the reimbursement payment schedule 30 days in advance. Such notification will be in the form of

written correspondence delivered by regular mail.

XIII. **TERMINATION**

Until funded by the COUNTY as described in Section V, this Funding ILA may be terminated by either party by providing written notice to the other party at least thirty (30) days prior to the intended date of termination. Any notice or other writing required by this Funding ILA shall be deemed given when personally delivered or mailed by certified or registered mail to the following officials:

COUNTY:

County Administrator Tarrant County 100 E. Weatherford Street, Suite 404 Fort Worth, Texas 76196

CITY: City Manager City of Saginaw 333 West McLeroy Boulevard Saginaw, Texas 76179

XIV. **SOVEREIGN POWERS**

The COUNTY and the CITY agree and understand neither party waives nor surrenders any of its governmental powers by execution of this Funding ILA.

APPROVED on this day the day of December, 2022, by Tarrant County.

Commissioners Court Order No. 39866

TARRANT COUNTY, TEXAS

CITY OF SAGINAW

Todd Flippo, Mayor

J.D. Johnson, Commissioner, Precinct 4

APPROVED AS TO FORM:

Criminal District Attorney's Office*

Bryn Meridith, City Attorney

CERTIFICATION OF AVAILABLE FUNDS IN THE AMOUNT OF

Pener Tidwell

\$____300,000__ as follows:

Fiscal year ending September 30, 2023 - \$ 225,000.00 Fiscal year ending September 30, 2024 - \$ 75,000.00 \$ 300,000.00**

Auditor's Office

^{*} By law, the Criminal District Attorney's Office may only approve contracts for its clients. We reviewed this document as to form from our client's legal perspective. Other parties may not rely on this approval. Instead those parties should seek contract review from independent counsel.

^{**} Funds will be provided by Precinct 4 discretionary funds from the 2006 Transportation Bond Program

ATTACHMENT A

Project Information

City: City of Saginaw

Project Name: Old Decatur Road North Roadway Improvements

Project Schedule

4	Start Date	Duration (mo.)	End Date
Design:	-	· -	-
ROW Acquisition:	-	-	-
Construction:	Jan-2023	12	Dec-2023

Reimbursement Payment by Phase

Design: \$0.00

ROW Acquisition: \$0.00

Construction: \$\\\ 300,000.00\\\
TOTAL: \$\\\ 300,000.00^*\\

* Funded with Precinct 4 discretionary funds from the 2006 Transportation Bond Program

Reimbursement Payment Schedule by Calendar Quarter (SUBJECT TO CHANGE)

	1st Quarter	2nd Quarter	3rd Quarter	4th Quarter
2021	\$0	\$0	\$0	\$0
2022	\$0	\$0	\$0	\$0
2023	\$75,000.00	\$75,000.00	\$75,000.00	\$75,000.00
2024	\$0	\$0 ·	\$0	\$0



Prepared By: Janice England

C. Action Regarding Dedication of Utility Easements by Separate Instrument to Juan Armendaris Survey Abstract No. 59, City of Saginaw, Tarrant County--Lee Howell, Asst. City Manager

Meeting	Agenda Group		
Tuesday, October 15, 2024, 6:00 PM	Consent Agenda Item: 2C.		
Reference File			
Community Goals			

BACKGROUND/DISCUSSION:

Approval of this item dedicates utility easements to Oncor and Atmos to construct electricity and natural gas connections to supply the new Saginaw Public Library and Senior Center. Attached are two separate instruments prepared by Kimley Horn detailing legal descriptions and locations by metes and bounds.

FINANCIAL IMPACT:

N/A

RECOMMENDATION:

N/A

Attachments

<u>Saginaw McLeroy Library Gas Esmt 20241003.pdf</u> <u>Saginaw McLeroy Library Util Esmt 20241003.pdf</u>

LEGAL DESCRIPTION

BEING a 0.0533 acre (2,320 square foot) tract of land situated in the Juan Armendaris Survey, Abstract No. 59, City of Saginaw, Tarrant County, Texas, and being a portion of Lot 1, Block 1, Starnes Addition, an addition to the City of Saginaw according to the plat recorded in Instrument No. D224005793, Official Public Records, Tarrant County, Texas, and being more particularly described as follows:

COMMENCING at an aluminum disk found for the southwest corner of said Lot 1, and being in the north right-of-way line of McLeroy Boulevard, a variable width right-of-way, from which a 1/2-inch iron rod found for the southwest corner of Lot 2, Block 1, Session's Addition, an addition to the City of Saginaw according to the plat recorded in Cabinet F, Slide 445, Plat Records, Tarrant County, Texas, and being in the intersection of the said north right-of-way line and the east right-of-way line of Western Avenue, a 50-foot right-of-way, bears South 89°02'33" West, a distance of 113.73 feet;

THENCE North 71°04'26" East, along the said north right-of-way line, a distance of 57.63 feet to the **POINT OF BEGINNING**:

THENCE North 01°46'25" East, departing the said north right-of-way line, a distance of 233.67 feet to a point for corner;

THENCE North 88°56'16" East, a distance of 10.01 feet to a point for corner;

THENCE South 01°46'25" West, a distance of 230.39 feet to a point for corner in the said north right-of-way line, from which a 2-inch bolt found for reference bears North 71°04'26" East, a distance of 291.62 feet;

THENCE South 71°04'26" West, along the said north right-of-way line, a distance of 10.69 feet to the **POINT OF BEGINNING** and containing 2,320 square feet or 0.0533 acres of land, more or less.

NOTES

Bearing system based on the Texas Coordinate System of 1983 (2011 adjustment), North Central Zone (4202). A survey plat of even survey date herewith accompanies this metes and bounds description.

The undersigned, Registered Professional Land Surveyor, hereby certifies that the foregoing description accurately sets out the metes and bounds of the easement tract.

ÍJOSHUA D. WARGO REGISTERED PROFESSIONAL LAND SURVEYOR NO. 6391

801 CHERRY STREET, UNIT 11 SUITE 1300 FORT WORTH, TEXAS 76102

PH. 817-335-6511

josh.wargo@kimley-horn.com

JOSHUA D. WARGO

GAS EASEMENT
JUAN ARMENDARIS SURVEY
ABSTRACT No. 59
CITY OF SAGINAW
TARRANT COUNTY, TEXAS


Kimley Horn

801 Cherry Street, Unit 11, # 1300
Fort Worth Texas 76102
FIRM # 10194040
FIRM # 10194040

Fort Worth, Texas 76102 FIRM # 1019404

10/3/2024

Project No. Sheet No. 061003162 1 OF 2

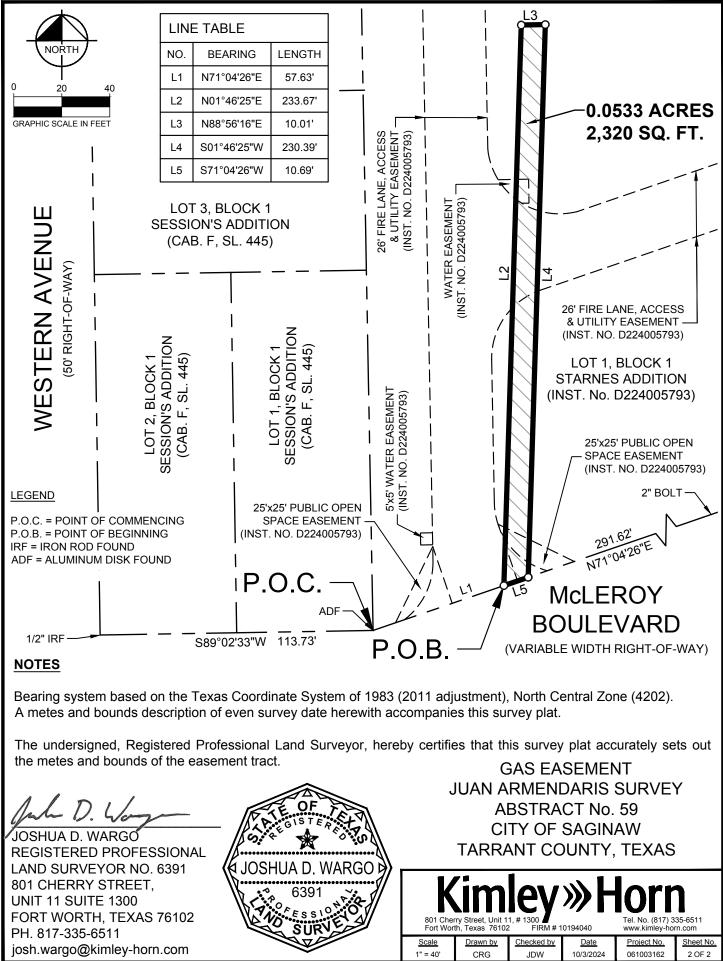

LEGAL DESCRIPTION

BEING a 0.2201 acre (9,587 square foot) tract of land situated in the Juan Armendaris Survey, Abstract No. 59, City of Saginaw, Tarrant County, Texas, and being a portion of Lot 1, Block 1, Starnes Addition, an addition to the City of Saginaw according to the plat recorded in Instrument No. D224005793, Official Public Records, Tarrant County, Texas, and being more particularly described as follows:

BEGINNING at an aluminum disk found for the southwest corner of said Lot 1, and being in the north right-of-way line of McLeroy Boulevard, a variable width right-of-way, from which a 1/2-inch iron rod found for the southwest corner of Lot 2, Block 1, Session's Addition, an addition to the City of Saginaw according to the plat recorded in Cabinet F, Slide 445. Plat Records, Tarrant County, Texas, and being in the intersection of the said north right-of-way line and the east right-of-way line of Western Avenue, a 50-foot right-of-way, bears South 89°02'33" West, a distance of 113.73 feet:

THENCE North 01°03'44" West, departing the said north right-of-way line and along the west line of said Lot 1, a distance of 357.51 feet to a point for corner;

THENCE North 88°56'16" East, departing the said west line, a distance of 72.00 feet to a point for corner;

THENCE South 01°03'44" East, a distance of 9.48 feet to a point for corner;

THENCE South 88°56'16" West, a distance of 21.50 feet to a point for corner, being the beginning of a tangent curve to the left with a radius of 25.00 feet, a central angle of 90°00'00", and a chord bearing and distance of South 43°56'16" West, 35.36 feet;

THENCE in a southwesterly direction, with said tangent curve to the left, an arc distance of 39.27 feet to a point for

THENCE South 01°03'44" East, a distance of 314.82 feet to a point for corner in the said north right-of-way, from which a 2-inch bolt found for reference bears North 71°04'26" East, a distance of 333.15 feet;

THENCE South 71°04'26" West, along the said north right-of-way line, a distance of 26,79 feet to the POINT OF **BEGINNING** and containing 9,587 square feet or 0.2201 acres of land, more or less.

NOTES

Bearing system based on the Texas Coordinate System of 1983 (2011 adjustment), North Central Zone (4202). A survey plat of even survey date herewith accompanies this metes and bounds description.

The undersigned, Registered Professional Land Surveyor, hereby certifies that the foregoing description accurately sets out the metes and bounds of the easement tract.


REGISTERED PROFESSIONAL

LAND SURVEYOR NO. 6391 801 CHERRY STREET. **UNIT 11 SUITE 1300**

FORT WORTH, TEXAS 76102

PH. 817-335-6511


josh.wargo@kimley-horn.com

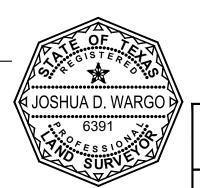

UTILITY EASEMENT JUAN ARMENDARIS SURVEY ABSTRACT No. 59 CITY OF SAGINAW TARRANT COUNTY, TEXAS

10/3/2024

061003162

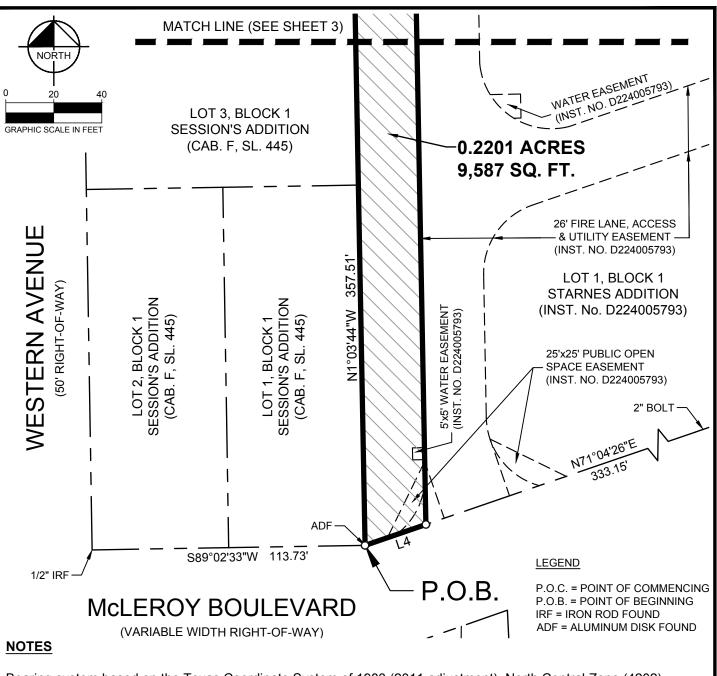


Bearing system based on the Texas Coordinate System of 1983 (2011 adjustment), North Central Zone (4202). A metes and bounds description of even survey date herewith accompanies this survey plat.

The undersigned, Registered Professional Land Surveyor, hereby certifies that this survey plat accurately sets out the metes and bounds of the easement tract.

JOSHUA D. WARGO
REGISTERED PROFESSIONAL
LAND SURVEYOR NO. 6391
801 CHERRY STREET.

UNIT 11 SUITE 1300 FORT WORTH, TEXAS 76102

PH. 817-335-6511 josh.wargo@kimley-horn.com

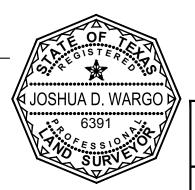


UTILITY EASEMENT
JUAN ARMENDARIS SURVEY
ABSTRACT No. 59
CITY OF SAGINAW
TARRANT COUNTY, TEXAS

Kimley » Horn 801 Cherry Street, Unit 11 # 1300 Tel. No. (817) 335-65

Fort Worth, Texas 76102 FIRM # 1019404

<u>Date</u> <u>Project</u> 10/3/2024 06100

Project No. Sheet No. 061003162 2 OF 3

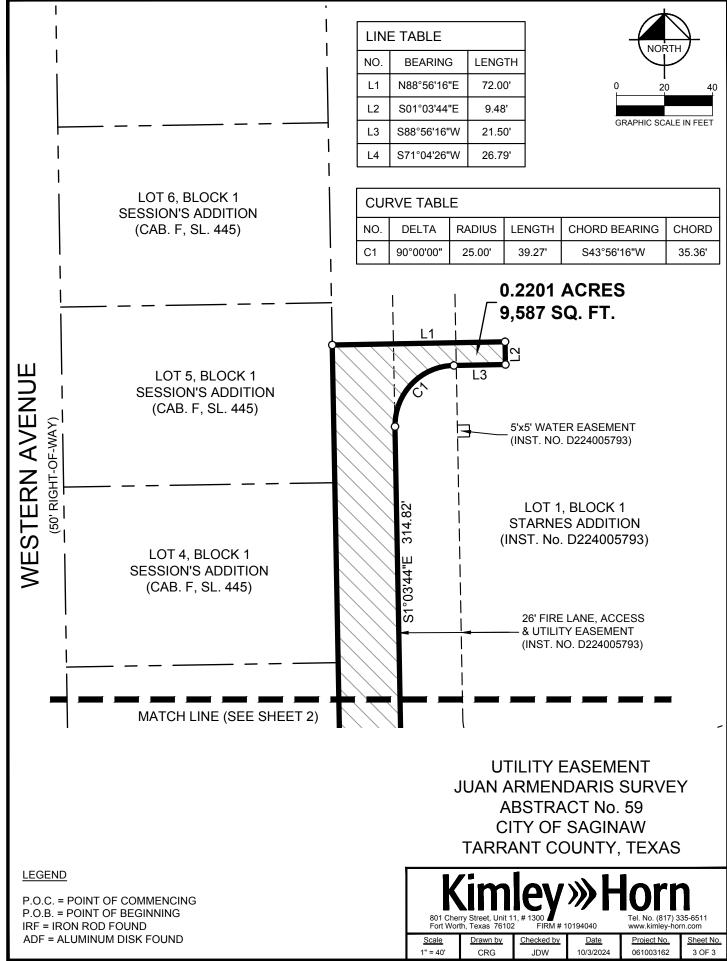



Prepared By: Janice England

D. Action Regarding the Purchase of a Mower for the Drainage Department--Randy Newsom, Director of Public Works

Meeting	Agenda Group			
Tuesday, October 15, 2024, 6:00 PM	Consent Agenda Item: 2D.			
Reference File				
Community Goals				

BACKGROUND/DISCUSSION:

The 2024-25 Drainage Department Budget included budgeted funds in the amount of \$75,000 for the purchase of a Remote-Operated Robotic Mower. This mower will allow the Drainage Department staff the ability to better maintain all of the floodplain areas that they have to mow. Some of these areas take weeks and sometimes months before they dry out enough to mow.

We received a bid from Kinloch Equipment utilizing their BuyBoard Contract #706-23 in the amount of \$70,412.50.

FINANCIAL IMPACT:

The total financial impact will be \$70,412.50.

Funds in the amount of \$75,000 were budgeted for purchase of this mower in account 14-7000-00-00. The actual cost of the mower being \$70,412.50 will result in a cost savings of \$4,587.50.

RECOMMENDATION:

Staff recommends approval for the purchase of the Remote-Operated Robotic Mower from Kinloch Equipment in the amount of \$70,412.50.

Attachments

Purchase of a Mower Memo.pdf

Consideration and Action regarding purchase of a Remote Operated Robotic Mower for the Drainage Department.

BACKGROUND/DISCUSSION:

The 2024-25 Drainage Department Budget included budgeted funds in the amount of \$75,000 for the purchase of a Remote-Operated Robotic Mower. This mower will allow the Drainage Department staff the ability to better maintain all of the floodplain areas that they have to mow. Some of these areas take weeks and sometimes months before they dry out enough to mow.

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RECOMMENDATION:

Staff recommends approval for the purchase of the Remote-Operated Robotic Mower from Kinloch Equipment in the amount of \$70,412.50.



www.kinlochequip.com

Ph. 713-473-6213 Fax: 713-473-7858 By: Trenton Crump Cell: 817-880-3209

Email: trenton.crump@kinlochequip.com

R-60 City of Saginaw

3320 Pasadena Blvd, Pasadena, TX 77503



QUOTATION

R-60 10/1/2024

Tracked 60" Rotary Mower, 38.5hp Kawasaki EFI Engine, 50° Max Slope

REMOTE-OPERATED ROBOTIC MOWER	PRICE	Qty	Extended
R-60	66950.00	1	\$ 66,950.00

OPTIONS FOR CONSIDERATION

Light Kit Installed	747.50	1	\$ 747.50
4500 LB Winch Kit Installed	1115.00	1	\$ 1,115.00

FREIGHT		1600.00	1	\$ 1,600.00
	55.111	NII / Mass		



SUBTOTAL \$ 70,412.50 70,412.50

14-7000-20-00 Mast Regin

PROPOSAL NOTES:

- 1. Prices quoted herein are firm until 11.1.24.
- 2. Prices quoted herein are from BuyBoard Contract # 706-23.
- 3. Payment terms are net due upon delivery.



Prepared By: Kim Quin

E. Action Regarding the Softball Complex Fence Repairs--Randy Newsom, Director of Public Works

Meeting	Agenda Group	
Tuesday, October 15, 2024, 6:00 PM	Consent Agenda Item: 2E.	
Reference File		
Community Goals		

BACKGROUND/DISCUSSION:

The 2024-25 Parks Department Budget included budgeted funds in the amount of \$54,000 for the repair work to the Softball Complex fence. Included in the repair work was the addition of wind slats added to the outfield fence.

We received a bid from Ware Fencing utilizing their TIPS Contract #23010402 in the amount of \$53,474.00.

FINANCIAL IMPACT:

The total financial impact will be \$53,475.00.

Funds in the amount of \$54,000 were budgeted for fence repair work in account# 01-7000-07-00. Staff recommends using the balance (\$37,928.33) of the American Rescue Plan Act for partial funding for this project resulting in a savings to the General Fund.

RECOMMENDATION:

Staff recommends approval for the fence repair work to be awarded to Ware Fencing in the amount of \$53,475.00.

Attachments

Softball Complex Fence Repairs Memo.pdf

Consideration and Action regarding the repairs to the Softball Complex fence.

BACKGROUND/DISCUSSION:

The 2024-25 Parks Department Budget included budgeted funds in the amount of \$54,000 for the repair work to the Softball Complex fence. Included in the repair work was the addition of wind slats added to the outfield fence.

We received a bid from Ware Fencing utilizing their TIPS Contract #23010402 in the amount of \$53,474.00.

FINANCIAL IMPACT:

The total financial impact will be \$53,475.00.

Funds in the amount of \$54,000 were budgeted for fence repair work in account #01-7000-07-00. The actual cost of the repair work is \$53,475.00 and will result in a cost savings of \$525.00.

RECOMMENDATION:

Staff recommends approval for the fence repair work to be awarded to Ware Fencing in the amount of \$53,475.00.

ESTIMATE

Ware Fencing, LLC P.O. Box 1171 Crowley, TX 76036 (817) 948-4503



Randy Newsom 400 S. Saginaw Blvd., TIPS CONTRACT 23010402 Saginaw, TX 76179

Estimate #	6059	
Date	10/7/2024	

Item	Description	Qty	Amount
Services.	WILLOW CREEK SOFRBALL FIELD	1.00	\$0.00
Services.	CONCRETE 12"X12" FOOTER This footer will go under the backstop fence. Footer will have #3 steel added for strength. This footer will be strong enough to add a block wall on later.	1.00	\$2,200.00
Services.	2-13X25 CONCRETE PADS FOR SPECTATOR SEATING Pads will be approximately 13ft x 25ft and will be 4" thick. Concrete will have #3 steel rebar on 18" centers. Concrete will have a 2% slope away from the field so water will drain away from the field. Concrete will have a broom finish.	1.00	\$11,400.00
Services.	APPROXIMATELY 200 FT OF 4FT FENCING We will remove approximately 200 feet of existing 4ft tall chain link fence. We will install new fence using 2 3/8" posts with 1 5/8" top rail. New chain link will be 4ft tall 9ga galvanized. We will use steel ties to attach fabric to posts.	200.00	\$6,400.00
Services.	APPROXIMATELY 200 FT OF 6FT FENCING We will remove approximately 200 feet of existing 6ft tall chain link fence. We will install new fence using the existing 2 3/8" posts with new 1 5/8" top rail. New chain link will be 6ft tall 9ga galvanized. We will use steel ties to attach fabric to posts. This fence will have a new bottom rail added.	200.00	\$8,400.00
Services.	APPROXIMATELY 70 FT OF 12FT FENCING We will remove approximately 70 feet of existing 12ft tall chain link fence. We will install new fence using the existing posts. New chain link will be 12ft tall 9ga galvanized. We will use steel ties to attach fabric to posts. This fence will have a new bottom rail added where needed.	70.00	\$4,550.00

Item	Description		Qty	Amount
Services.	OUTFIELD FENCE- GREEN PRIVACY SLA	OUTFIELD FENCE- GREEN PRIVACY SLATS		\$18,125.00
	We will supply and install new green privacy will fill all the 10ft tall outfield fence and will the lower fence sections going from right fie will go to the top of the fence with an appropriate along the bottom. This will include materials	go across to eld to left. Slats kimate 12" gap		
Services.	10FT TALL CHAIN LINK FENCE BLOCKING RESTROOM	G	1.00	\$2,400.00
	We will remove the chain link from the area restrooms and haul it off. We will use the sa add new 8ft tall chain link fence with green p	me posts and		
	arefencing.com. PO's must be received prior to start of	Sub Total		\$53,475.00
ASK IF YOU HAVE QUESTIONS,	BE DONE, IF IT IS NOT IN THE CONTRACT, IT IS NOT BEING INSTALLED, PLEASE	Total		\$53,475.00

Prior to the start of the job you agree to contact Texas811 for a digitest www.texas811.org. Any charges incurred by not completing a digitest will be customers responsibility. Anything underground must be properly marked and is the responsibility of the contract owner to do so. Access to water and electricity will be required.

Billing for the estimate may be structured in increments based on the nature of the job.

Additional costs will be incurred for rock encountered during dig. Payment is due NET 30.

PLEASE NOTE CHANGES MADE WHILE JOB IS BEING INSTALLEO WILL CHANGE THIS ESTIMATE, IF THE ESTIMATED FOOTAGE CHANGES THE FINAL INVOICE WILL CHANGE.

Estmates are valid for 7 days from Date sent

Please contact us at 817-948-4503 with any questions. Thank you for your business!



Prepared By: Janice England

F. Action Regarding the Purchase of a New Gymnasium Floor for the Recreation Center--Keith Rinehart, Director of Community & Economic Development

Meeting	Agenda Group	
Tuesday, October 15, 2024, 6:00 PM	Consent Agenda Item: 2F.	
Reference File		
Community Goals		

BACKGROUND/DISCUSSION:

The Recreation Center is over 20 years old, and the gym floor is used 7 days per week. The existing gym floor needs to be replaced. The tiles are warping, and the "dead spots" have made adding the addition of three (3) indoor Pickleball Courts impossible. The floor's surface is not smooth. A durable floor designed for multipurpose use from Pickleball, Volleyball, Basketball, and Rentals will optimize the use and revenue of our gym while serving the needs of our residents.

FINANCIAL IMPACT:

This item was budgeted for and approved by the City Council as a Special Request in the Fiscal Year 24-25 budget. The Buy Board bid of \$107,454 from the GFC Floor Company is less than budgeted.

RECOMMENDATION:

N/A

Attachments

101524 Gym Floor.pdf





333 W. McLeroy Blvd., Saginaw, Texas 76179

Council Agenda Background

To: Gabe Reaume, City Manager

From: Keith C. Rinehart, Director of Community & Economic Development

Date: City Council Meeting – October 15, 2024

ITEM:

Consideration and Action Regarding the Purchase of a New Gymnasium Floor for the Recreation Center

PRESENTER:

Keith C. Rinehart, Director of Community & Economic Development

DISCUSSION:

The Recreation Center is over 20 years old, and the gym floor is used 7 days per week. The existing gym floor needs to be replaced. The tiles are warping, and the "dead spots" have made adding the addition of three (3) indoor Pickleball Courts impossible. The floor's surface is not smooth. A durable floor designed for multipurpose use from Pickleball, Volleyball, Basketball, and Rentals will optimize the use and revenue of our gym while serving the needs of our residents.

FINANCIAL IMPACT:

This item was budgeted for and approved by the City Council as a Special Request in the Fiscal Year 24-25 budget. The Buy Board bid of \$107,454 from the GFC Floor Company is less than budgeted.

RECOMMENDATION

NA

ATTACHMENTS:

• Buy Board Quote from GFC Flooring for Gymnasium Flooring (Available Upon Request)

If you have any questions, please contact me at 817-230-0331. Thank you, Keith C. Rinehart, Director of Community & Economic Development



Prepared By: Janice England

G. Action Regarding the Purchase of a Storage Building to Provide Equipment Storage for the Recreation Center--Keith Rinehart, Director of Community & Economic Development

Meeting	Agenda Group	
Tuesday, October 15, 2024, 6:00 PM	Consent Agenda Item: 2G.	
Reference File		
Community Goals		

BACKGROUND/DISCUSSION:

The Recreation Center is over 20 years old, and we've outgrown it. Currently, the Senior Center operates out of our two largest rooms until their new Senior Center is constructed. We've lost space for equipment storage and need to meet code compliance.

FINANCIAL IMPACT:

This item was budgeted for and approved by the City Council as a Special Request in the Fiscal Year 24-25 budget. The financial impact will be a total of \$9,362, which includes the cost of the building (Tuff Shed - \$8,362) and the cost of pouring a 10x16 concrete pad (in-house - \$1,000). This cost is less than that which was budgeted.

RECOMMENDATION:

N/A

Attachments

101524 Storage Bldg.pdf





333 W. McLeroy Blvd., Saginaw, Texas 76179

Council Agenda Background

To: Gabe Reaume, City Manager

From: Keith C. Rinehart, Director of Community & Economic Development

Date: City Council Meeting – October 15, 2024

ITEM:

Consideration and Action Regarding the Purchase of a Storage Building to Provide Equipment Storage for the Recreation Center

PRESENTER:

Keith C. Rinehart, Director of Community & Economic Development

DISCUSSION:

The Recreation Center is over 20 years old, and we've outgrown it. Currently, the Senior Center operates out of our two largest rooms until their new Senior Center is constructed. We've lost space for equipment storage and need to meet code compliance.

FINANCIAL IMPACT:

This item was budgeted for and approved by the City Council as a Special Request in the Fiscal Year 24-25 budget. The financial impact will be a total of \$9,362, which includes the cost of the building (Tuff Shed - \$8,362) and the cost of pouring a 10x16 concrete pad (in-house - \$1,000). This cost is less than that which was budgeted.

RECOMMENDATION

NA

ATTACHMENTS:

- Quote for Building (Available Upon Request)
- Quote for Concrete Pad (Available Upon Request)

If you have any questions, please get in touch with me at 817-230-0331.

Thank you, Keith C. Rinehart, Director of Community & Economic Development



City Council Memorandum

Prepared By: Janice England

B. Community Presentation--Family, Career and Community Leaders of America (FCCLA)--Maggie Henderson, Region II Vice President of Texas State Association of FCCLA

Meeting	Agenda Group		
Tuesday, October 15, 2024, 6:00 PM	Proclamations-Presentations Item: 3B.		
Reference File			
Community Goals			

BACKGROUND/DISCUSSION:

Maggie Henderson, a student at Boswell High School, will give a brief presentation. She is the Region II Vice President of the Texas State Association of Family, Career and Community Leaders of American (FCCLA). Her presentation is a requirement of the duties of the office she holds.

FINANCIAL IMPACT:

N/A

RECOMMENDATION:

N/A



City Council Memorandum

Prepared By: Janice England

D. Presentation Regarding the Remodeling of the John Ed Keeter Library--Jarred Coursey, Asst. Public Works Director

Meeting	Agenda Group		
Tuesday, October 15, 2024, 6:00 PM	Proclamations-Presentations Item: 3D.		
Reference File			
Community Goals			

BACKGROUND/DISCUSSION:

Asst. Public Works Director Coursey will give an update on the progress of the design concept for the John Ed Keeter Building remodel.

FINANCIAL IMPACT:

N/A

RECOMMENDATION:

N/A

Attachments

Presentation of John Ed Keeter Remodel Design and Cost Estimate for Construction.pdf

Design and Construction Cost Estimate Update John Ed Keeter Building.pdf

KEETER RENOVATION_ADDITION SCHEMATIC DESIGN.pdf

Saginaw Library Keeter Bldg Reno Concept v2.00.pdf

Saginaw City Hall Annex Exterior Options and Interior Perspectives_2024.10.15.pdf

Presentation of John Ed Keeter Remodel Design and Cost Estimate for Construction

This presentation is to update City Council on the progress of the design concept for the John Ed Keeter Building remodel. The design process is closing in on being 50% completed. PGAL has projected a 100% completion of the design process in mid-December. The design costs are being funded through ARPA funds which was approved by City Council.

Design

The building is being designed to efficiently allow 23-26 employees to have a work space. There are a total of 21 offices being built (some offices will have multiple shared work spaces). There will be a large conference room to hold various types of meetings, front lobby for citizens and guests, employee breakroom, copier/mailroom work station, 2 bathrooms for citizens and guests, 2 bathrooms for employees, 9 storage rooms, and a connection hallway between the Keeter building and City Hall which will not only be a walkway for employees, it will also house 4 of the 9 storage rooms.

Construction Cost Estimate

This is just estimates for the construction and it is not under contract. Staff is currently going over each line item to see where savings can occur, an example of this would be the furniture expense, the majority of the employees already have reliable and quality office furniture and computers to plug into their new work spaces which will dramatically bring this expense estimate down. Staff will have a more accurate estimate of construction costs at the 100% design completion point. Staff is recommending to use the Construction Management at Risk (CMAR) process which is what Saginaw used for the new Library project.


<u>Must Haves:</u> New HVAC system, Fire Protection (Library and City Hall), and new roof (not a part of the cost estimate).

Alternative Exterior Designs


PGAL added some alternative exterior designs, they are not apart of the cost estimate nor do they have an estimate of what that would cost. These are for strictly to showcase what could be done to the exterior.

CONCEPTUAL DESIGN AND CONSTRUCTION COST ESTIMATE UPDATE FOR JOHN ED KEETER BUILDING

CITY OF SAGINAW

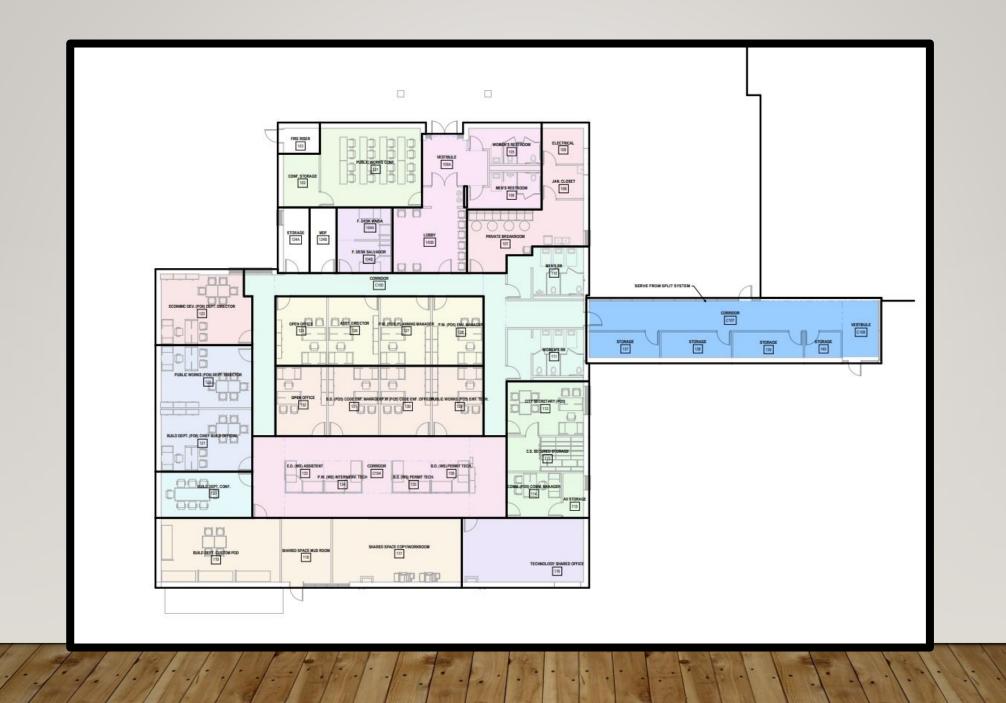



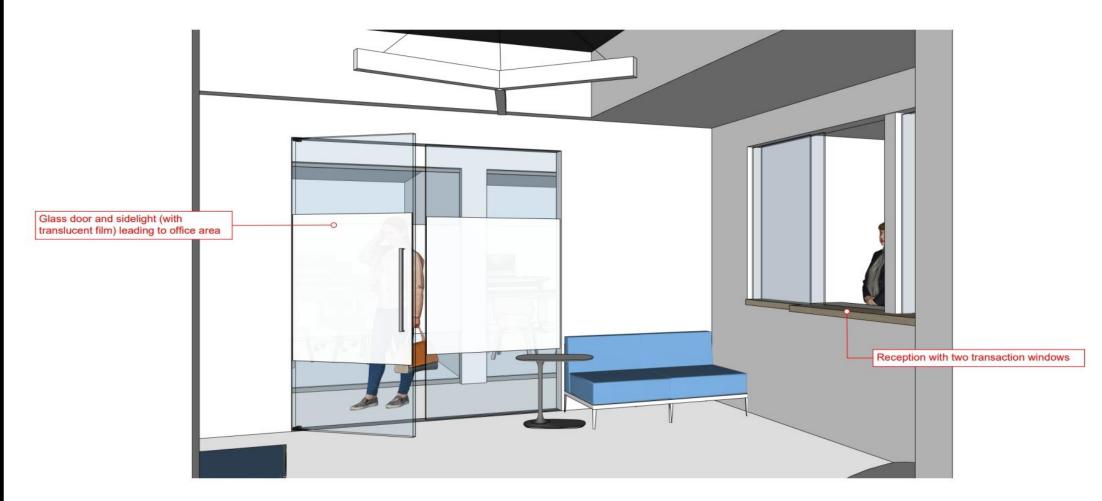



LOBBY | WAITING AREA

City Hall | City of Saginaw | Keeter Library Rennovation & Annexation 2024.10.15







City Hall | City of Saginaw | Keeter Library Rennovation & Annexation 2024.10.15









OPEN OFFICE | ASSISTANTS

City Hall | City of Saginaw | Keeter Library Rennovation & Annexation 2024.10.15





Estimate Report

Saginaw Keeter Bldg. Renovation

Saginaw, TX

AACEi Class 4: Concept

September 06, 2024

Version 2.00

Prepared for:





Basis of Estimate



01 EXECUTIVE SUMMARY


The total project cost for the scope of this project:


SUBTOTAL DIRECT COST (COST OF WORK)	\$ 3,640,248
DESIGN EVOLUTION	\$ 728,050
SUBTOTAL GMP (No Fee)	\$ 4,368,297
CMAR FEE	\$ 218,415
ESTIMATED CONSTRUCTION COST (ECC) W/FEE	\$ 4,586,712
CONSTRUCTION CONTINGENCY	\$ 458,671
ESTIMATED CONSTRUCTION COSTS (Final)	\$ 5,045,383
ESCALATION \$	\$ 321,946
TOTAL PROJECT COSTS	\$ 5,367,329


400	FURNITURE	1	LS	\$179,637	21.3%	23.8%	\$269,676	\$361,473	
401	Corner Decks	6.00	Ea.	\$22,884.66	21.3%	23.8%	\$34,355.03	\$46,050	\$7,674.92
402	Cardenza	6.00	Ea.	\$12,192.33	21.3%	23.8%	\$18,303.44	\$24,534	\$4,088.99
403	Small Conference Tables	30.00	Ea.	\$25,980.83	21.3%	23.8%	\$39,003.08	\$52,280	\$1,742.66
404	Large Conference Tables	2.00	Ea.	\$6,032.06	21.3%	23.8%	\$9,055.47	\$12,138	\$6,068.98
405	Office Desk	13.00	Ea.	\$10,375.08	21.3%	23.8%	\$15,575.33	\$20,877	\$1,605.94
406	Tall Storage Cabinet	33.00	Ea.	\$60,986.74	21.3%	23.8%	\$91,554.83	\$122,720	\$3,718.79
407	Breakroom Tables	4.00	Ea.	\$2,064.11	21.3%	23.8%	\$3,098.70	\$4,153	\$1,038.37
408	Breakroom Chair	8.00	Ea.	\$1,608.22	21.3%	23.8%	\$2,414.30	\$3,236	\$404.52
409	Task Chair	110.00	Ea.	\$37,513.05	21.3%	23.8%	\$56,315.53	\$75,485	\$686.23
410	EQUIPMENT	1	LS	\$25,000	21.3%	23.8%	\$37,531	\$50,306	
411	Copy Machine	2.00	Ea.	\$9,500.00	21.3%	23.8%	\$14,261.64	\$19,116	\$9,558.15
412	Refrigerator	1.00	Ea.	\$2,000.00	21.3%	23.8%	\$3,002.45	\$4,024	A
413	Dish Washer	1.00	Ea.	\$1,500.00	21.3%	23.8%	\$2,251.84	\$3,018	A. J.
414	Secured Storage - Allowance	1.00	Ea.	\$12,000.00	21.3%	23.8%	\$18,014.70	\$24,147	

ALTERNATIVE EXTERIOR OPTIONS


CITY OF SAGINAW

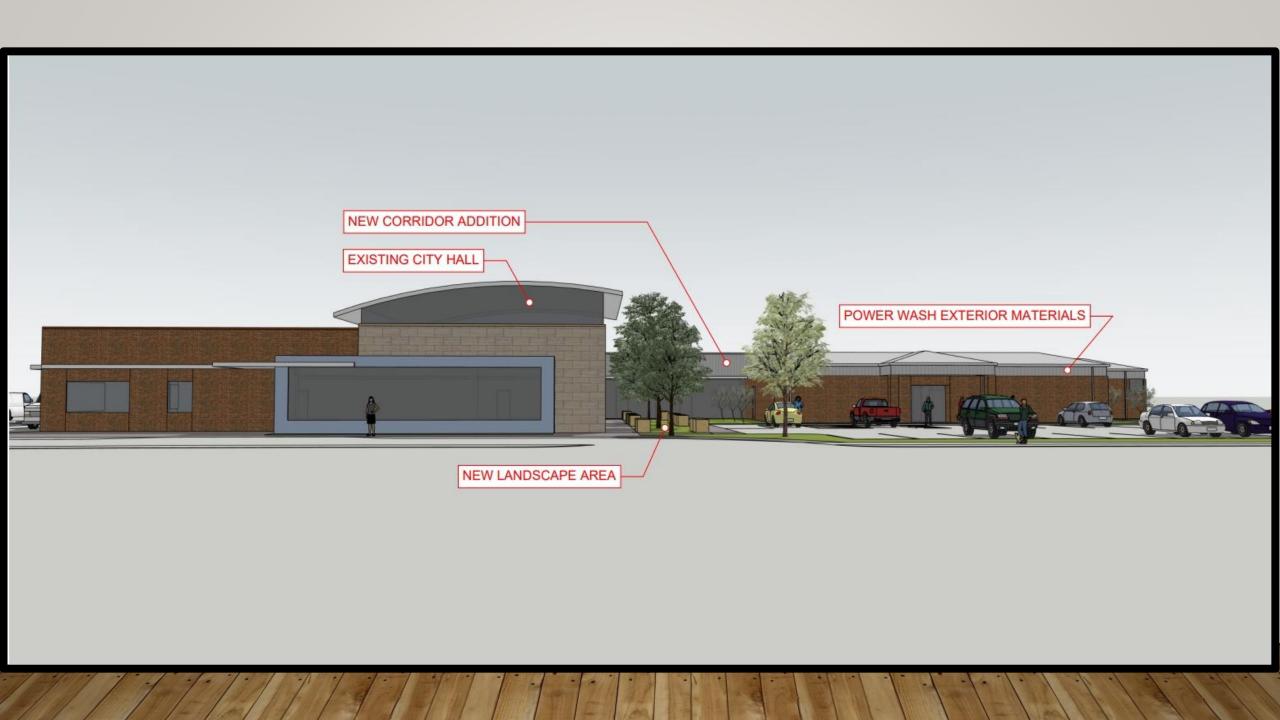


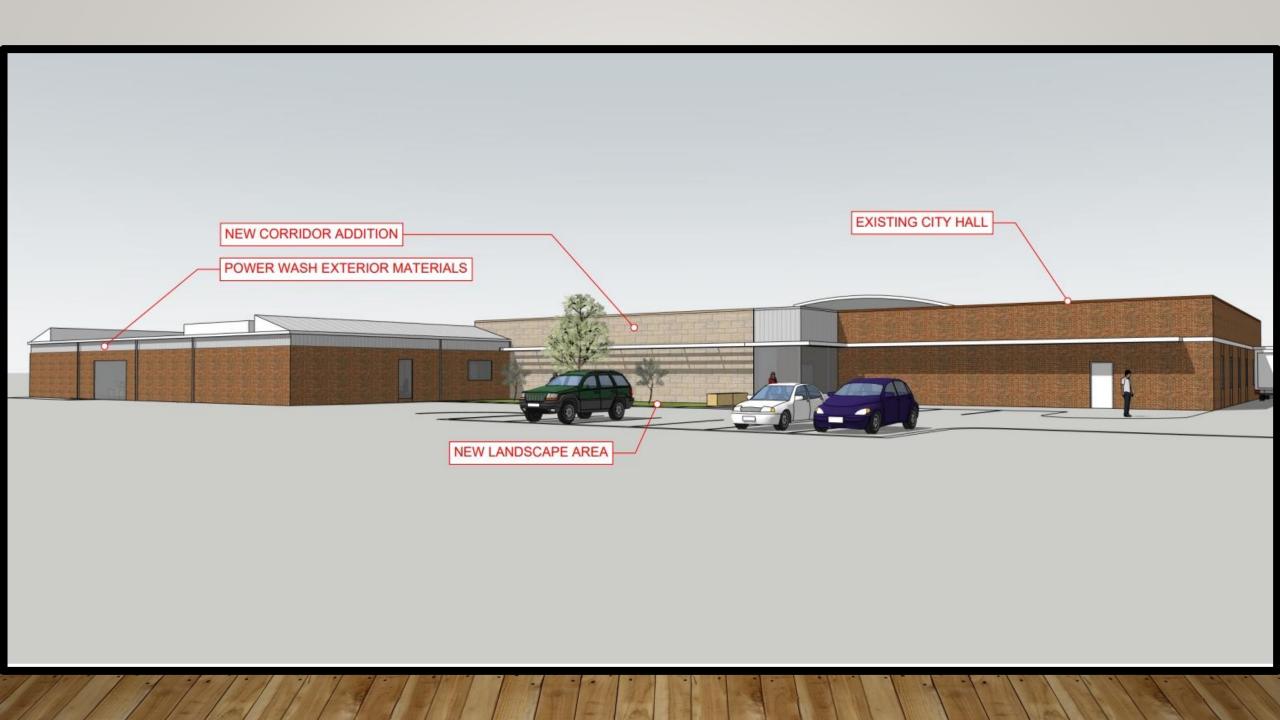

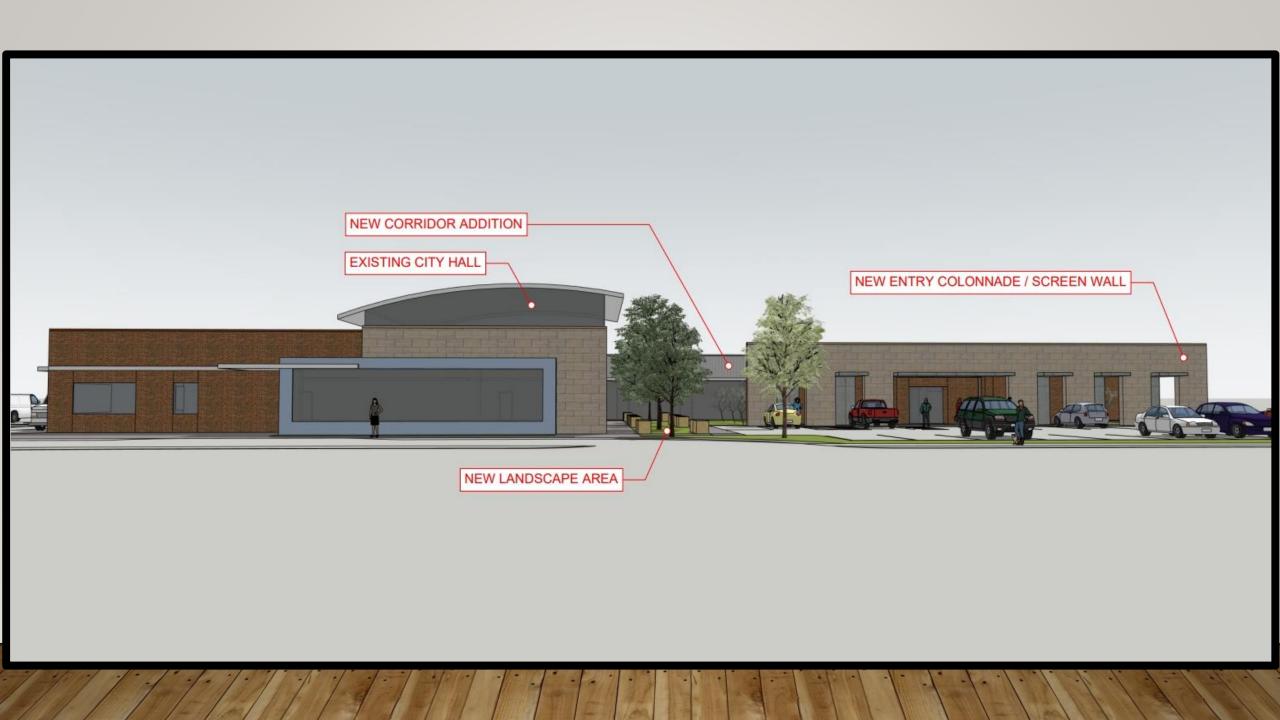



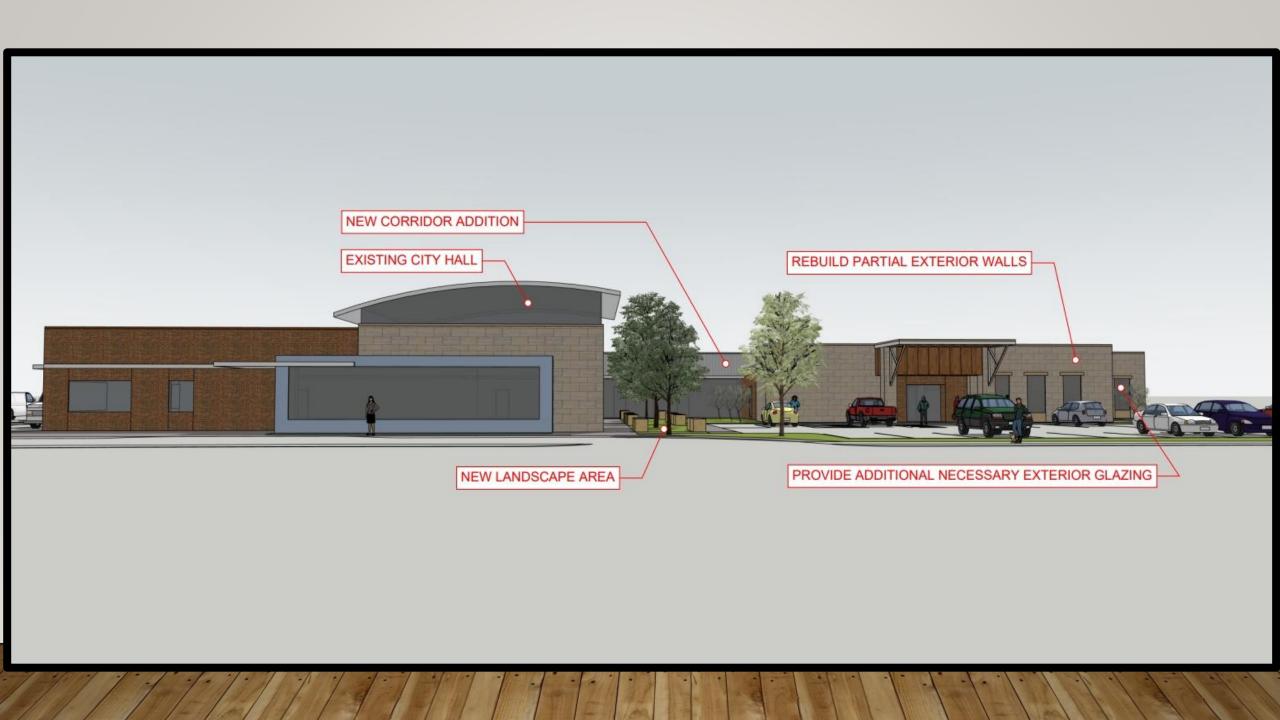

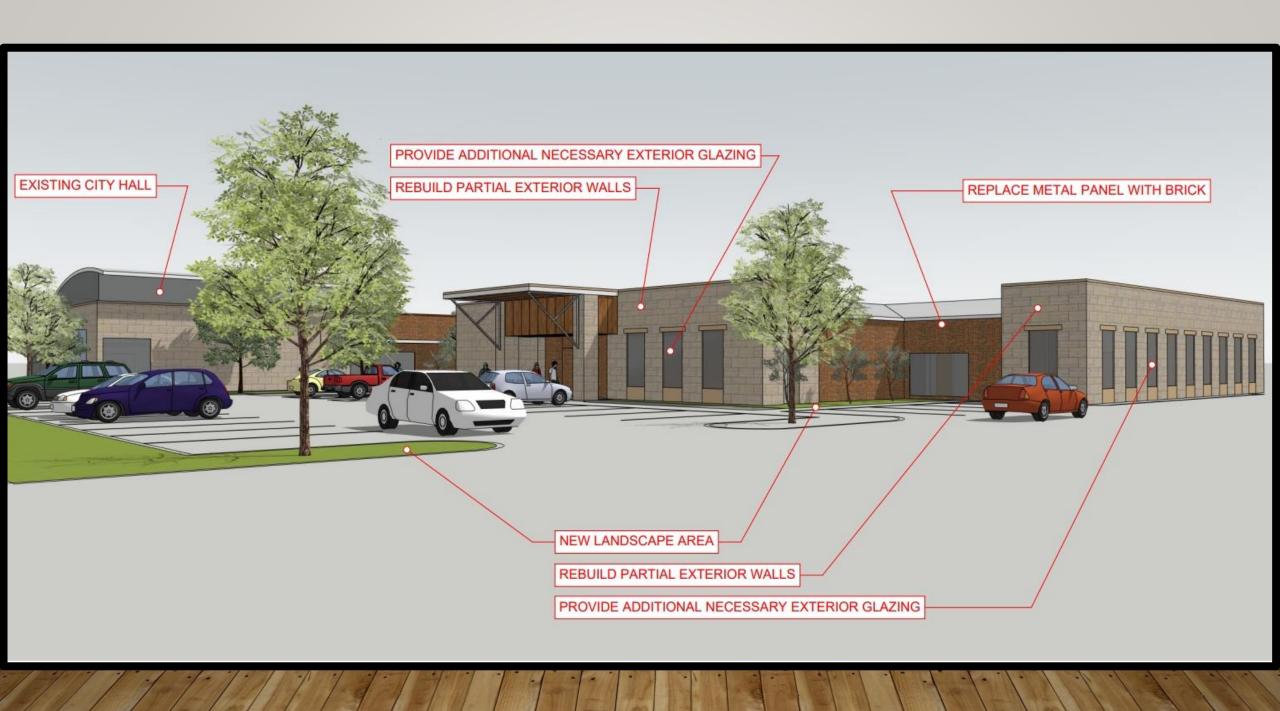

QUESTIONS



SAGINAW KEETER BUILDING RENOVATION

355 W McLeroy Blvd. Saginaw, TX 76179

Project State Registration #: TBD

ARCHITECT



PGAL, INC. 14135 Midway Road Suite G-200 Addison, TX 75001 T) 972.871.2225

CIVIL




TNP 5237 N Riverside Dr. Suite #100 Fort Worth, TX 76137 T) 817.336.5773

STRUCTURAL




3107 W. 7th St. Suite 400 Fort Worth, TX 76107 T) 817.546.7200

MEP

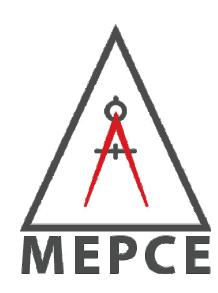

MEPCE 7500 Glenview Drive Suite A Fort Worth, TX 76118 T) 972.870.9060

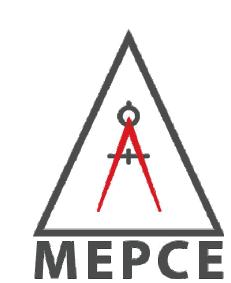

MEPCE 7500 Glenview Drive Suite A Fort Worth, TX 76118 Γ) 972.870.9060

COST EST.



APR 4425 W Airport Fwy Suite 110 Irving, TX 75062 T) 972.784.1277



SHEET INDEX

G0.00 COVER SHEET & SHEET INDEX G0.02 GENERAL PROJECT INFORMATION

EX-1 EX UTILITY EXHIBIT EX-2 EX UTILITY EXHIBIT

ARCHITECTURAL DEMO

S2.30 STRUCTURAL ROOF MARKUP S3.10 STRUCTURAL FOUNDATION MARKUP

AD2.10 OVERALL DEMO FLOOR PLAN AD2.30 OVERALL DEMO ROOF PLAN

AD3.10 OVERALL DEMO REFLECTED CEILING PLA ARCHITECTURAL

A0.20 FINISH LEGEND & SCHEDULE A1.01 SITE PLAN A2.10 OVERALL FLOOR PLAN

A2.30 OVERALL ROOF PLAN A3.10 OVERALL REFLECTED CEILING PLAN A6.01 EXTERIOR BUILDING ELEVATIONS A7.01 BUILDING SECTIONS

MECHANICAL

M-001 MECHANICAL GENERAL NOTES & LEGEND M-101 LEVEL 01 MECHANICAL PLAN

M-102 ROOF LEVEL MECHANICAL PLAN

PROJECT NUMBER 1006633.02

ARCHITECTURE

ENGINEERING

INTERIORS

PLANNING

ALEXANDRIA

BOCA RATON

ATLANTA

CHICAGO

DALLAS

DENVER

HOBOKEN

HOUSTON

LAS VEGAS

SAN DIEGO

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DRAWING HISTORY

INTERIM REVIEW THIS DOCUMENT IS RELEASED

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 №.
 DATE
 DESCRIPTION

 A
 2024/08/23
 SCHEMATIC DESIGN

LOS ANGELES


SALT LAKE CITY

AUSTIN

SHEET TITLE **COVER SHEET &** SHEET INDEX

G0.00

08/23/2024

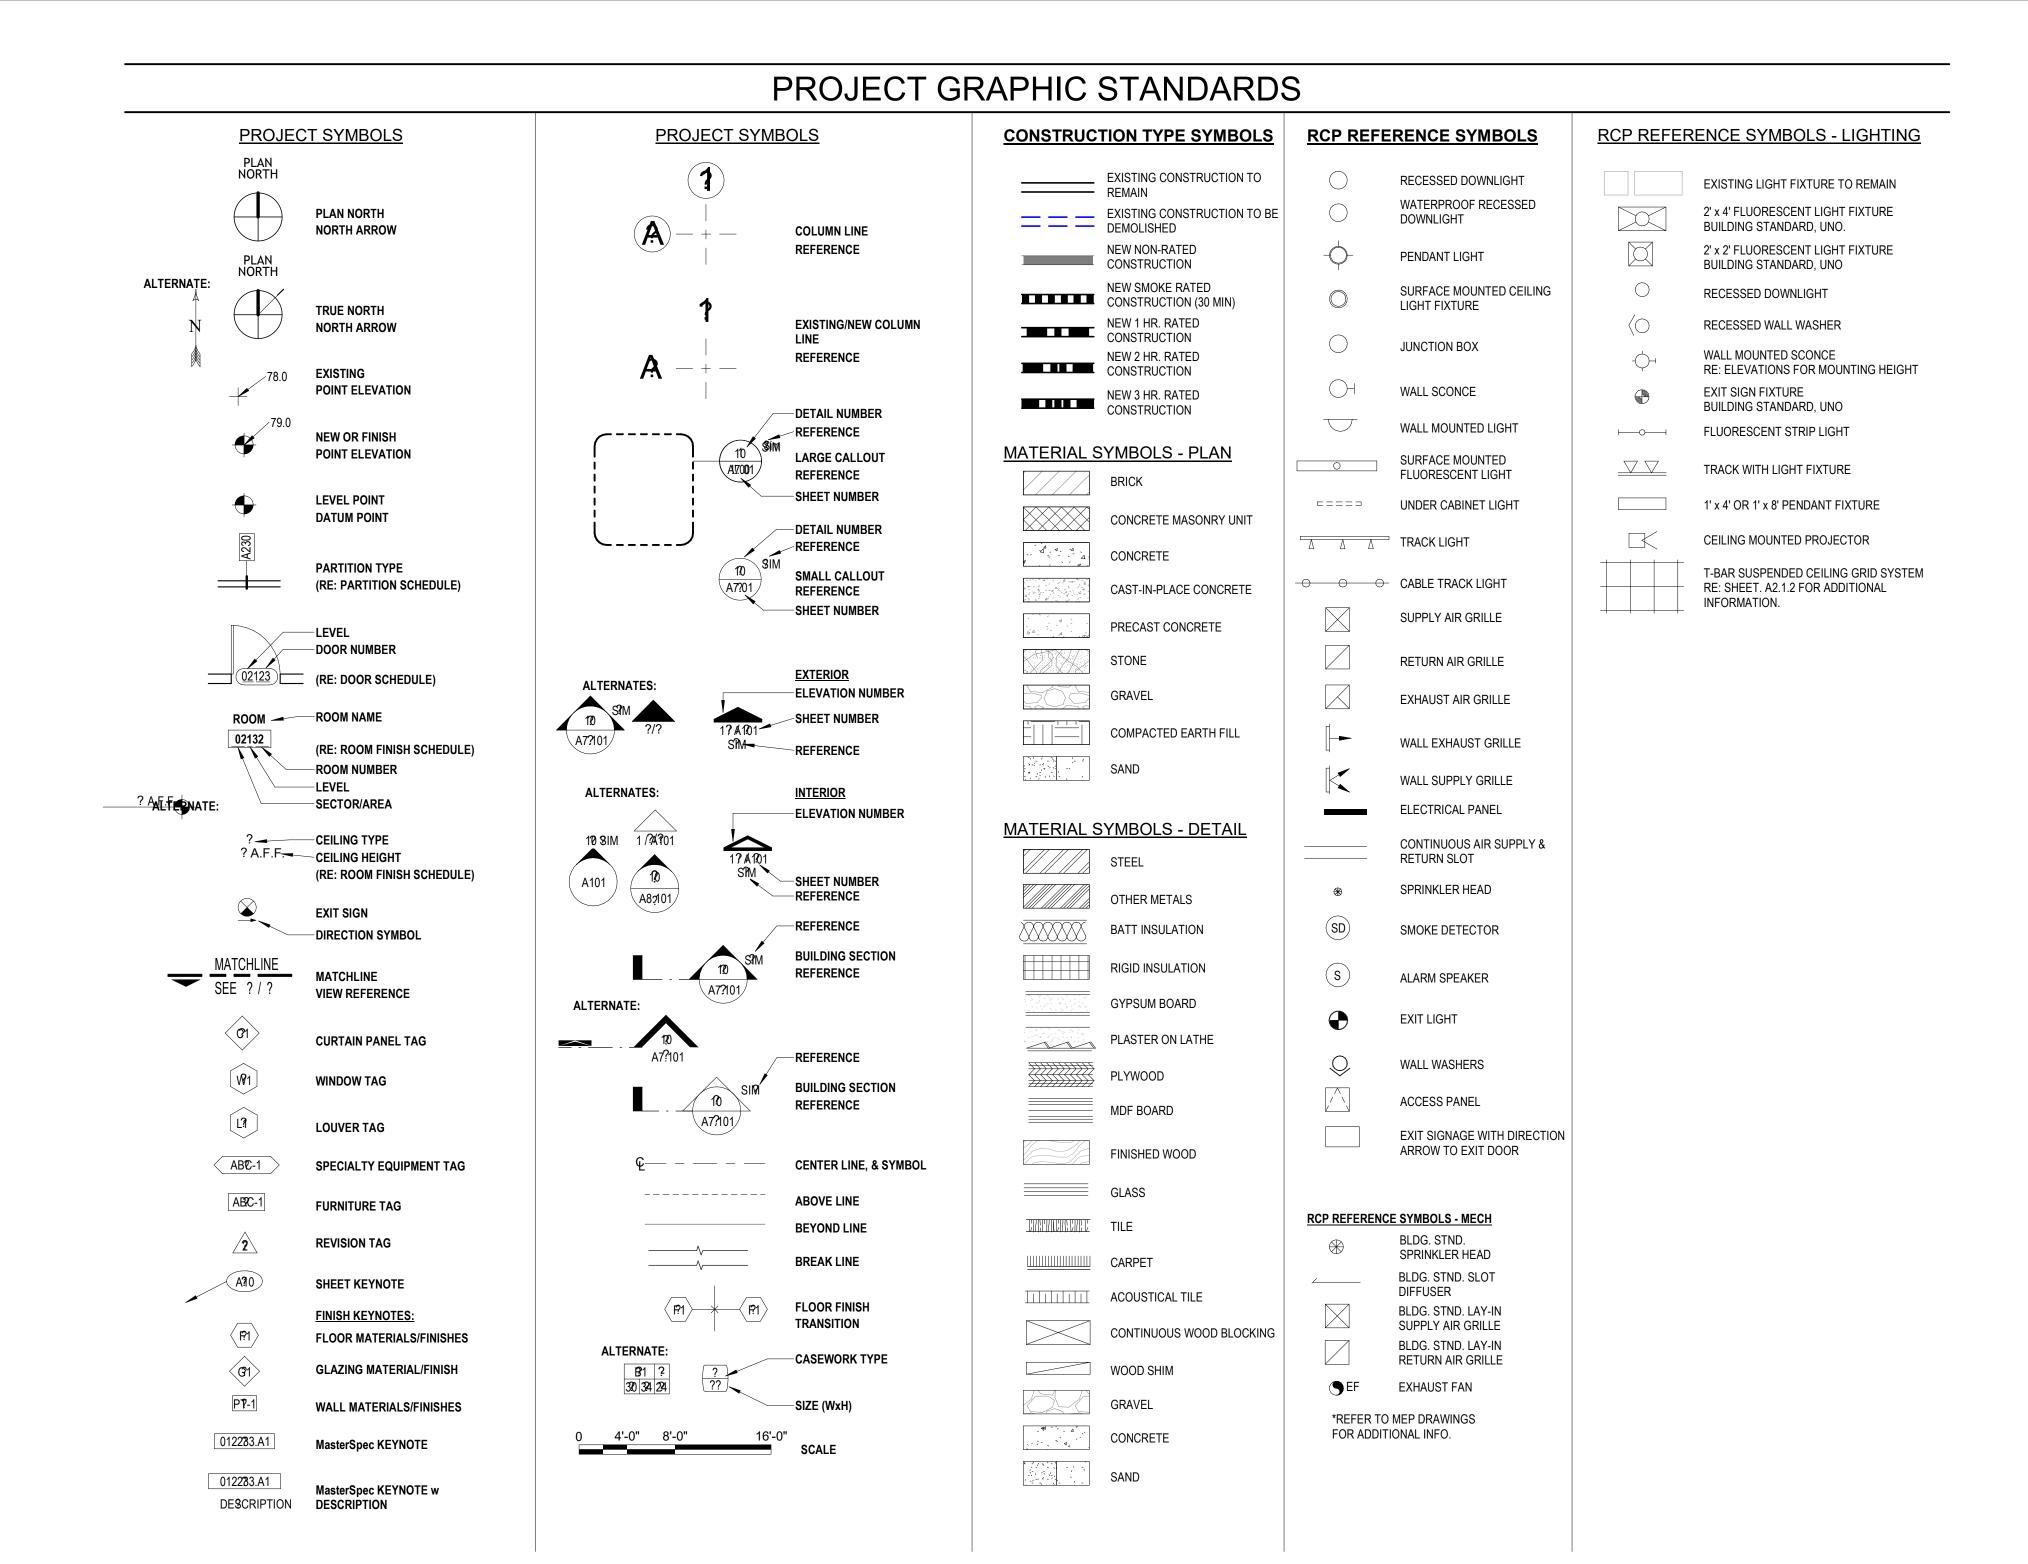

GENERAL PROJECT NOTES

DESCRIPTION

The Construction Documents are to include AIA document A201"General Conditions of the Contract for Construction". The City of Saginaw shall be designated as "The Owner", PGAL Architects shall be designated as "The Architect". The AIA document shall also include the Agreement, Performance and Payment Bonds, General Conditions, Supplementary Conditions, the Specifications, the Drawings Addendum, and Contract Modifications, Building Rules and Regulations & any other documents required by the Owner.

The General Contractor shall be both licensed and bonded in Texas and shall provide documents upon request.
 The Work shall be done in accordance with the rules and regulations of all applicable safety and building codes, and as approved by the Authority Having

- Jurisdiction. The General Contractor is responsible for securing and paying for all permits required for the Work and for the scheduling of all required inspections during the course of the Work.

 I. The General Contractor shall review and verify existing conditions as provided in the Construction Documents. The Contractor shall notify the Architect of all
- The General Contractor shall review and verify existing conditions as provided in the Construction Documents. The Contractor shall notify the Architect of a discrepancies, errors, inconsistencies or ambiguities prior to proceeding with the Work.

 The General Contractor shall be responsible for, and provide protection of, any existing finishes, materials, and equipment to remain. The General Contractor shall be responsible for, and provide protection of, any existing finishes, materials, and equipment to remain.
- The General Contractor shall be responsible for, and provide protection of, any existing finishes, materials, and equipment to remain. The General Contractor shall repair or replace any damaged finishes, materials, and equipment as a result of the work. All existing finishes to remain shall be cleaned at the completion of construction. The General Contractor shall photograph and document all existing damages, and provide to the Architect, prior to proceeding with the Work.
 All materials and systems shall be installed per manufacturer's specifications. All construction shall be of industry standard or better. The Architect shall be final
- judge of quality.

 7. Only new materials and equipment of recent manufacture, of standard quality and free from defects, will be permitted in the Work, unless otherwise noted.

 Rejected materials and equipment shall be removed immediately from the Work and replaced with materials and equipment of the quality specified. Failure to remove rejected materials and equipment shall not relieve the General Contractor from the responsibility for quality of material and equipment used nor from any other obligation imposed by the Contract.
- 8. Do not scale drawings. Stated & written dimensions govern. The General Contractor shall verify all dimensions in the field and shall be responsible for their accuracy. No extra charge or compensation shall be allowed because of difference between actual dimensions and those indicated on the drawings, unless they contribute to a change in the scope of the Work. Any difference found shall be submitted to the Architect for coordination prior to ordering, manufacturing, or proceeding with the Work. Horizontal dimensions indicated are to/from face of finish, unless noted otherwise. Vertical dimensions are from top of floor slab except where noted to be above finished floor (AFF). Dimensions are not adjustable without approval of Architect unless noted +/-.
- except where noted to be above finished floor (AFF). Dimensions are not adjustable without approval of Architect unless noted +/-.

 9. In the event of conflict between data shown on drawings and data provided in the specification, the specification shall govern. Detail drawings take precedent over drawings of larger scope. The Contractor shall provide written notification to the Architect of any discrepancies, prior to proceeding with the Work. In case of an inconsistency between Drawings and Specifications or within either Document, not clarified by Addendum, the more specific provision shall take
- 10. The General Contractor shall verify that no conflicts exist between the locations of existing and proposed new mechanical, electrical, plumbing, data, and sprinkler equipment (including but not limited to structural members, piping, duct work, conduit and sprinklers) and that clearances for installation and maintenance of equipment are provided. Elements in conflict shall be documented and provided to the Architect prior to proceeding with the Work.
- The General Contractor shall provide the Architect with shop drawings for review and approval, for all, but not limited to, the following: shop-fabricated millwork, carpet layout, flooring, light fixtures, doors, misc. steel, metal fabrication, glass/glazing, sprinkler layouts, hardware. Shop drawings shall be submitted in the form of 3 sets of prints. Shop drawings shall not be reproductions of Contract Documents. Material Submittals (3 samples) shall be provided for wood, fasteners, acrylic, carpet, tile, base, paint, laminate and any other materials indicated in the shop drawing.
 The General Contractor shall provide the Architect with manufacturer's cut sheets and specifications for all equipment including but not limited to: light fixtures,
- plumbing equipment, electrical equipment, fans, supplementary heating and cooling elements, all hardware and security equipment.
- 13. The General Contractor shall not proceed with work for which he expects additional compensation beyond the contract amount with out written authorization from the Architect and Owner. Failure to obtain such authorization shall invalidate a claim for extra compensation. The Contractor shall not proceed with work which, if completed in strict conformance with the Construction Documents, will result in additional work beyond the scope of the Contract without written authorization from the Architect and Owner. Any field conditions that significantly vary from the Contract Documents or will result in additional work, shall be brought to the attention of the Architect prior to proceeding with work.
 14. The General Contractor shall include all x-ray and core drill costs. The General Contractor shall review and coordinate the size and location of all slab openings.
- 14. The General Contractor shall include all x-ray and core drill costs. The General Contractor shall review and coordinate the size and location of all slab openings with all related disciplines. The General Contractor shall submit proposed locations of core drilling and slab openings to Architect and Structural Engineer of Record for review and approval prior to proceeding with the Work.
- Patch, repair, and install all fireproofing as required by Code. Fireproof all new penetrations as required for approval by the Authority Having Jurisdiction.
 Where building seismic joints are located, the General Contractor shall provide applicable Code and industry best practices for routing of all piping, ducts, conduits and other continuous runs.
- 17. The General Contractor shall continuously check architectural and structural clearances for accessibility of equipment and mechanical and electrical systems.

 No allowances of any kind will be made for the General Contractor's negligence to foresee means of installing equipment into position.
- 18. The finished work shall be firm, well-anchored, in true alignment, plumb, level, with smooth, clean, uniform, appearance without waves, distortions, holes, marks, cracks, stains, or discoloration. Jointing shall be close fitting, neat and well scribed. The finished work shall have no exposed unsightly anchors or fasteners and shall not present hazardous, unsafe corners. All work shall have the provision for expansion, contraction and shrinkage as necessary to prevent cracks, buckling, and warping due to temperature and humidity conditions.
- 19. Attachments, connections or fasteners of any nature are to properly and permanently be secured in conformance with industry best practices. The drawings highlight special conditions only and by no means illustrate every connection. The Contractor is responsible for improving connection accordingly.
- 20. General Contractor shall waive "Common Practice" and "Common Usage" as construction criteria wherever details and Contract Documents of governing codes, ordinances, etc. require quantity or better quality than common practice or common usage would require.
- 21. The General Contractor shall submit shop drawings and submittals, and shall order and schedule delivery of materials to avoid delays in construction. If an item is found to be unavailable or to have a long lead time, the General Contractor shall notify Architect immediately with a proposed alternative.
 22. The General Contractor shall notify the Owner, the Landlord, and the Architect in writing of any deficiencies in base building work prior to the commencement of
- the Work. Any unreported deficiencies will become the responsibility of the General Contractor to correct.

 23. The General Contractor shall exercise industry best practices for care and caution during the construction of the Work, and shall schedule work to minimize disturbances to occupants, adjacent spaces and/or structures, property, public thoroughfares, etc. The General Contractor shall take precautions and be
- responsible for the safety of all building occupants during construction procedures. The General Contractor shall be responsible for any costs incurred.

 24. All debris shall be removed from the site on a daily basis, or as directed by the Authority Having Jurisdiction. Upon completion of the work, remove all debris
- 24. All debris shall be removed from the site on a daily basis, or as directed by the Authority Having Jurisdiction. Upon completion of the work, remove all de from the building created by the work provided under this Contract and leave all areas clean. Trash is not permitted to be burned on site.
- 25. All abandoned and miscellaneous nails, hangers, staples, wires, conduits and debris shall be removed from exposed areas of the floors, walls, and ceilings. Remove all abandoned pipe sleeves in floor slabs. Patch existing slab as required to maintain UL fire rating of floor slab where pipes and conduits have been removed.
- 26. Slab penetrations shall be sealed as required to maintain fire rating, using materials and methods approved by the Authority Having Jurisdiction. Expansion material shall be approved by the Architect.
- 27. The General Contractor shall notify the Architect of any access panels which may be required prior to proceeding with the Work. Contractor shall be responsible for coordinating all trades. Required access panels shall be included in the Contractor's scope of Work.
- 28. Contractor shall provide the Team with a construction schedule showing the proposed phasing. Long lead items that will affect the Substantial Completion date shall be brought to the Architect's attention immediately.



City of Saginaw, Texas

333 West McLeroy Blvd. Saginaw, TX 76179 T 817 232 4640 F 817 232 0311

ARCHITECT



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DF	DRAWING HISTORY		
Nº.	DATE	DESCRIPTION	
Α	2024/08/23	SCHEMATIC DESIGN	
	1		

PROJECT NAME
SAGINAW
KEETER
BUILDING
RENOVATION

PROJECT LOCATION

355 W McLeroy Blvd.

Saginaw,TX 76179

PROJECT NUMBER 1006633.02

SHEET TITLE

GENERAL PROJECT
INFORMATION

SHEET NUMBER

G0.02

SAGINAW KEETER BUILDING RENOVATIONS

SCHEMATIC DESIGN
CIVIL/LANDSCAPE NARRATIVE
AUGUST 30, 2024

TNP Project Number: PGA 24336

CIVIL/LANDSCAPE

I. DEMOLITION & PHASING PLAN

A. Prepare a demolition based on the proposed improvements. The existing buildings will remain active during construction. Construction will need to be phased accordingly to ensure the existing facility remains active. Existing drives/parking lots/utilities that serve the existing buildings shall remain in service throughout construction. The demolition plan will include the removal of all pavements, utilities and storm drain within the limits of the proposed improvements.

II. SITE & DIMENSIONAL CONTROL PLAN

A. Prepare a detailed site and dimensional control plan based on the architect's site plan. Site plan will include all elements of design including building, drives, and parking lot changes. All fire lanes will be striped in accordance with local standards where necessary. Parking lot striping and signage will be provided throughout the limits of the improvements.

III. GRADING PLAN

A. Drives and parking lots will be graded to eliminate the need for a storm drain system, if possible. Grades will slope away from the building to mitigate ponding against the structure and around the new connector. Additional grading and flatwork will be needed to correct the drainage issues around the perimeter of the existing library building. A Storm Water Pollution Prevention Plan (SWPPP) and Erosion Control will be required for this site. Silt fence will be necessary along the limits of work. In addition, a construction entrance/exit will be required.

IV. STORM DRAIN PLAN

A. An underground storm drain with associated catch basins and inlets exist between the two buildings. The current storm drain system drains water from the north side of the existing building in the drop off drive, between the buildings towards the south, and under the proposed connector. The new storm drain system will be rerouted to go to the west, be achieved through changes in grading on the north side or drain through the proposed curb with a flume.

V. UTILITY PLAN

- A. Gas/Electric/Fiber
 - 1. It is anticipated that all existing franchise services are available at the site and extensions will not be necessary.

B. Water

There are existing domestic water lines to the site to serve both buildings. Fire lines may need
to be extended within the site for internal fire sprinklers. Double detector check backflow
assembly will be provided on the fire line at the water main connection. Fire hydrants will be
located to meet local standards where necessary.

C. Sewer

1. There are existing sewer lines connecting both buildings. A private 6"/8" sewer line will be extending within the site to collect all building sewer locations determined by the MEP.

VI. PAVING PLAN

A. All paving will be designed per recommendations in the geotechnical report. The subgrade for all paving areas will be treated with either lime or cement as determined by the geotechnical report. Fire lanes will be 7" thick concrete. All other drives will be 6" thick concrete. All parking areas will be 5" thick concrete. Miscellaneous flatwork throughout the campus will be 4" or 5" thick.

VII. DETAILS & SPECIFICATIONS

A. All applicable site, paving, water, sewer and storm drain details will be provided. A comprehensive set of specifications will be provided.

VIII. LANDSCAPE

- A. Landscape Character (proposed in necessary area only)
 - 1. Sustainability
 - 2. Low water use
 - 3. Low maintenance
 - 4. Low fertility requirements
 - 5. Native Texas plants and stone where possible
 - 6. Shrub beds limited to the public-facing front of the building and where required by code.
 - 7. Match existing landscaping
- B. Code Requirements: Landscape and irrigation follow the City of Saginaw's code.

C. Shrub Planting

1. Proposed shrub beds will be kept near the building entrances and only as required by code throughout the site.

D. Tree Planting


- 1. Ornamental trees will be used to accent the buildings architecture and entrances. To avoid future conflicts with the building, large canopy trees will be planted at least 30' away from the building where necessary.
- 2. All trees shall have a minimum size of 3" caliper at time of planting.


E. Turf Planting

- 1. For faster establishment of turfgrass, no hydroseed will be used. Instead, solid Bermuda sod will be proposed for all the turf areas.
- F. Quantities are not able to be determined until the limits of work are known and the site plan is further developed.

IX. IRRIGATION


- A. All proposed landscaping should have a permanent underground irrigation system. The system design will follow Texas TCEQ irrigation standards.
 - 1. Existing Water source: potable water will be used with backflow preventers for this site.
 - 2. A water pressure test will be conducted to determine if a booster pump is needed for the irrigation system.
 - 3. The irrigation controller, extensions and heads will match the existing system.

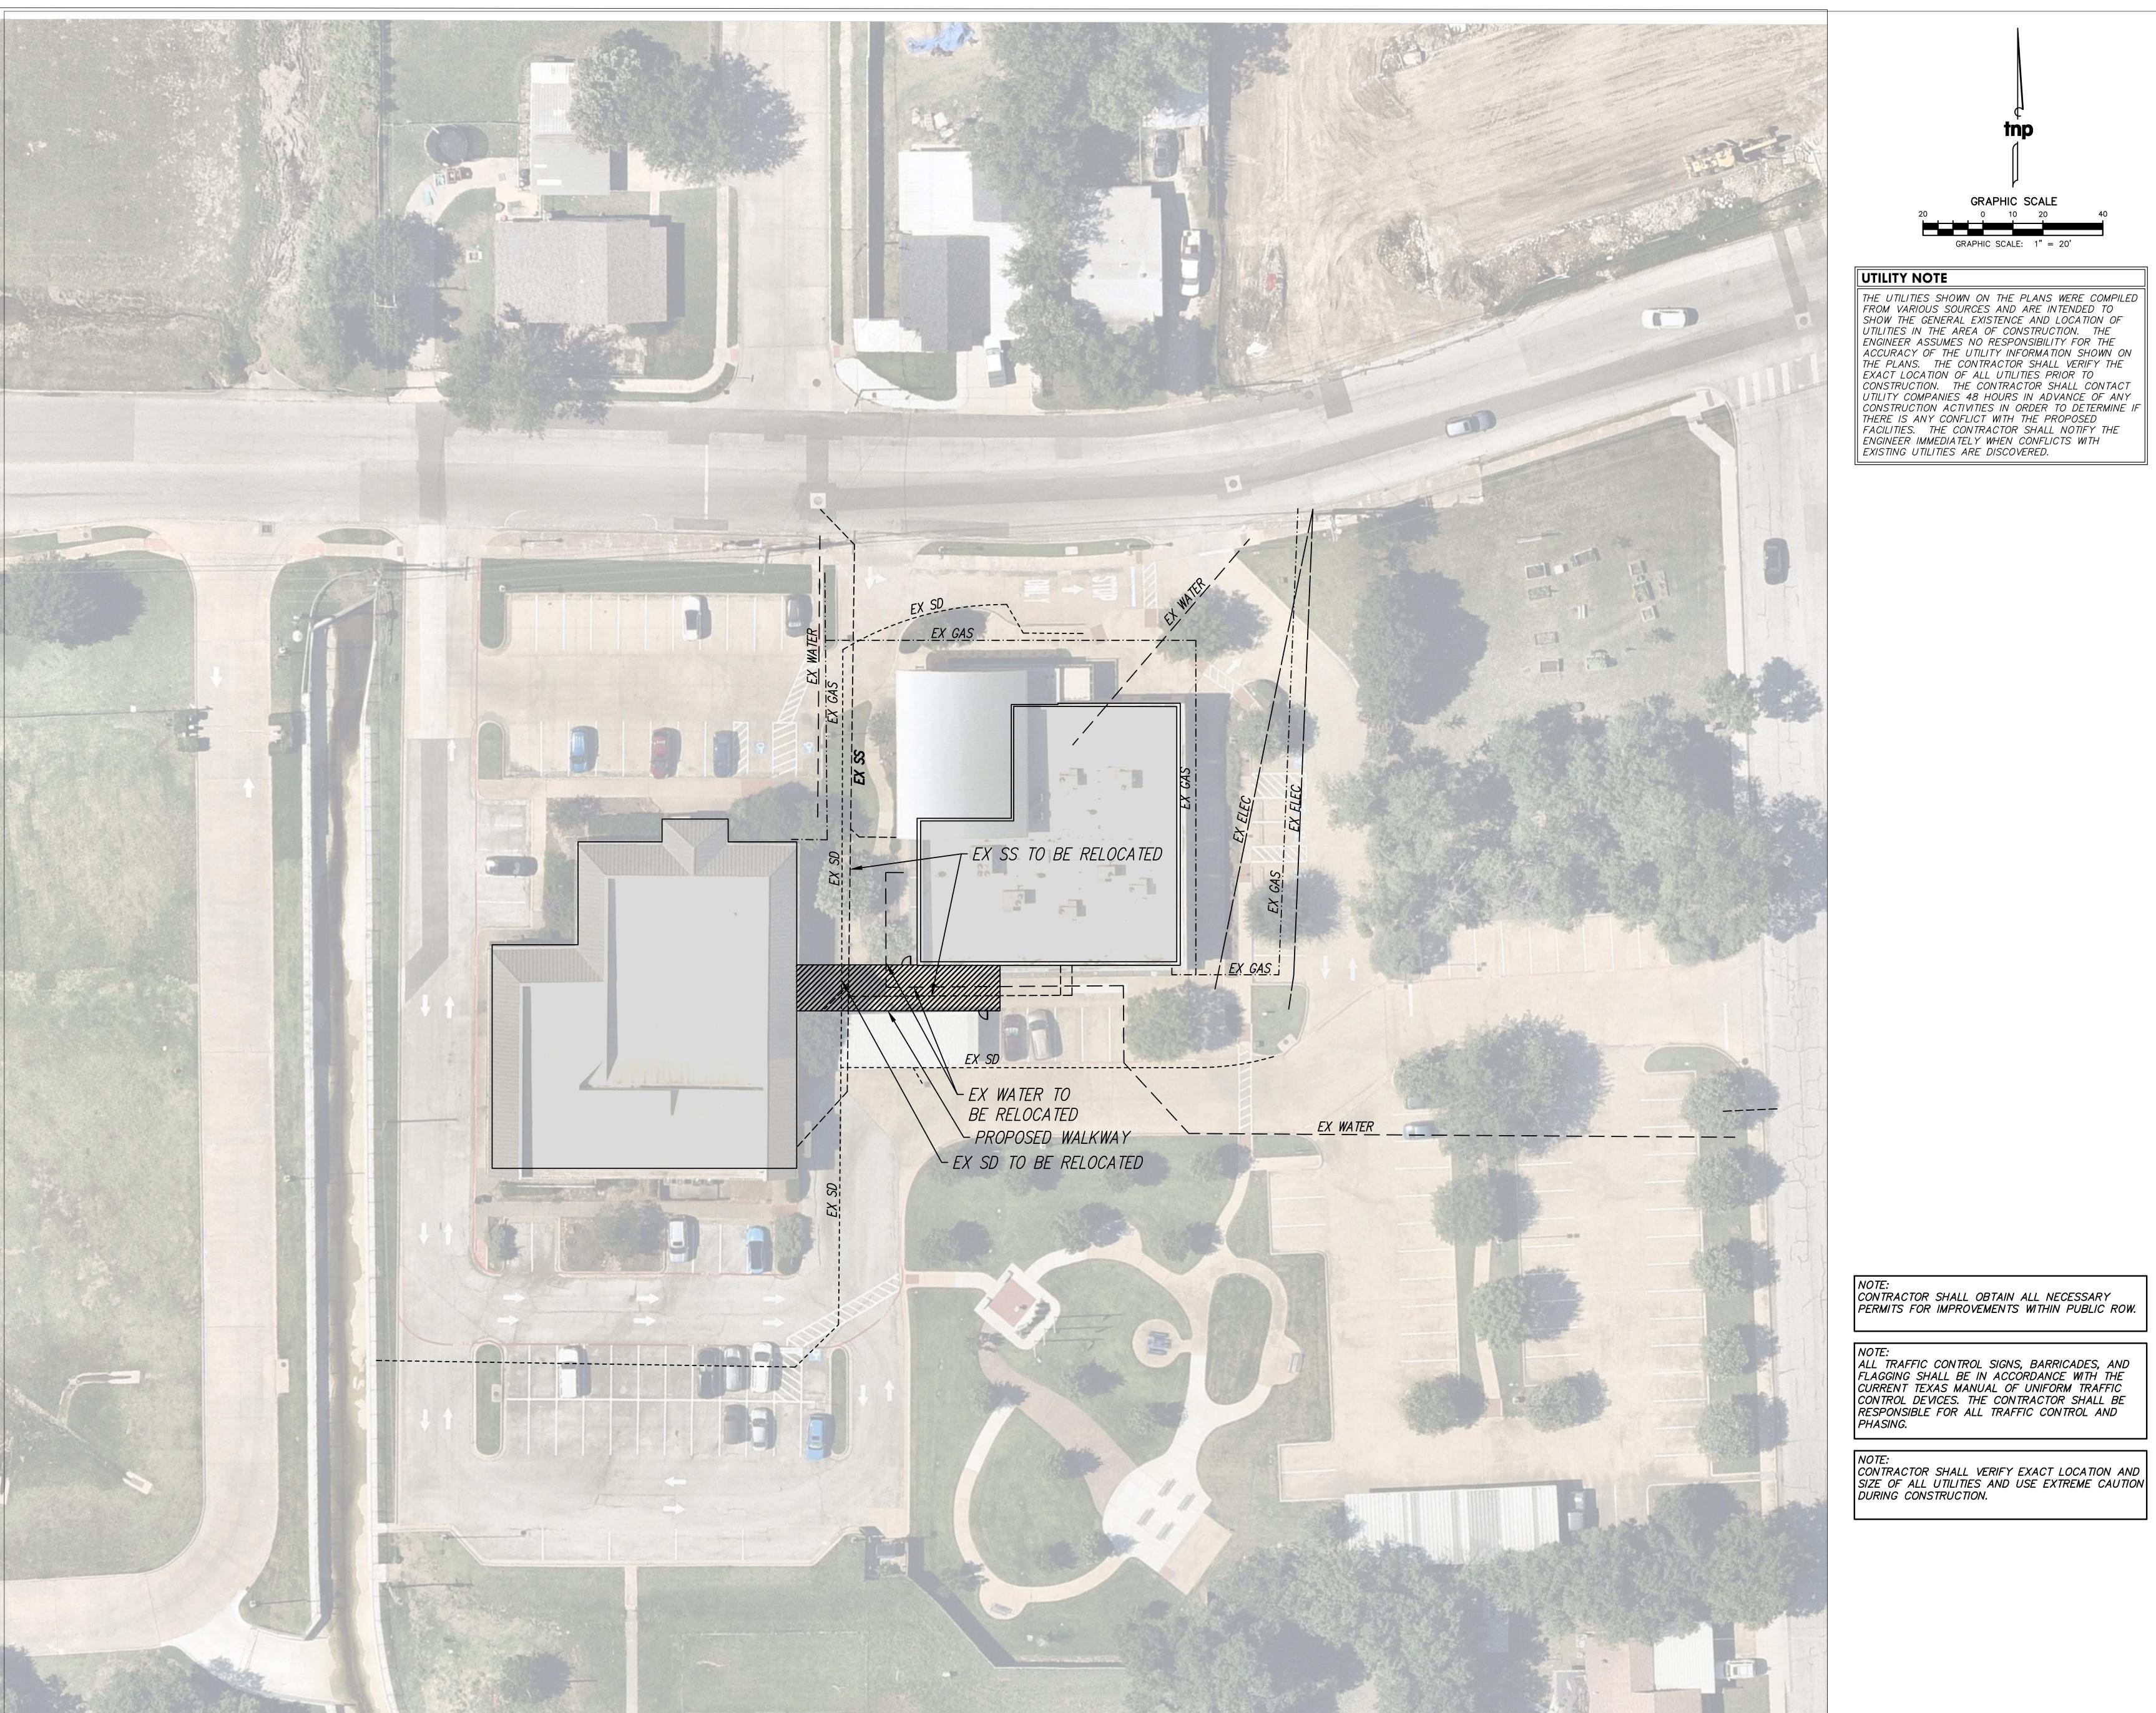

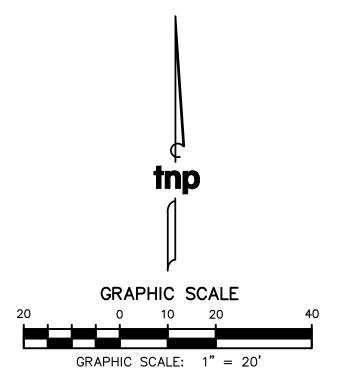

UTILITY NOTE

THE UTILITIES SHOWN ON THE PLANS WERE COMPILED FROM VARIOUS SOURCES AND ARE INTENDED TO SHOW THE GENERAL EXISTENCE AND LOCATION OF UTILITIES IN THE AREA OF CONSTRUCTION. THE ENGINEER ASSUMES NO RESPONSIBILITY FOR THE ACCURACY OF THE UTILITY INFORMATION SHOWN ON THE PLANS. THE CONTRACTOR SHALL VERIFY THE EXACT LOCATION OF ALL UTILITIES PRIOR TO CONSTRUCTION. THE CONTRACTOR SHALL CONTACT UTILITY COMPANIES 48 HOURS IN ADVANCE OF ANY CONSTRUCTION ACTIVITIES IN ORDER TO DETERMINE IF THERE IS ANY CONFLICT WITH THE PROPOSED FACILITIES. THE CONTRACTOR SHALL NOTIFY THE ENGINEER IMMEDIATELY WHEN CONFLICTS WITH EXISTING UTILITIES ARE DISCOVERED.

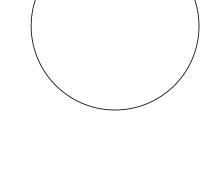

City of Saginaw, Texas

333 West McLeroy Blvd. Saginaw, TX 76179

T 817 232 4640 F 817 232 0311

PGAL, Inc. 3131 Briarpark Dr. Suite 200

Houston, TX 77042

T 713 622 1444

F 713 622 1444

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PROJECT NAME SAGINAW KEETER BUILDING RENOVATION


PROJECT LOCATION 355 W McLeroy Blvd. Saginaw,TX 76179

PROJECT NUMBER 1006633.02

SHEET TITLE EX UTILITY EXHIBIT

SHEET NUMBER

EX-1

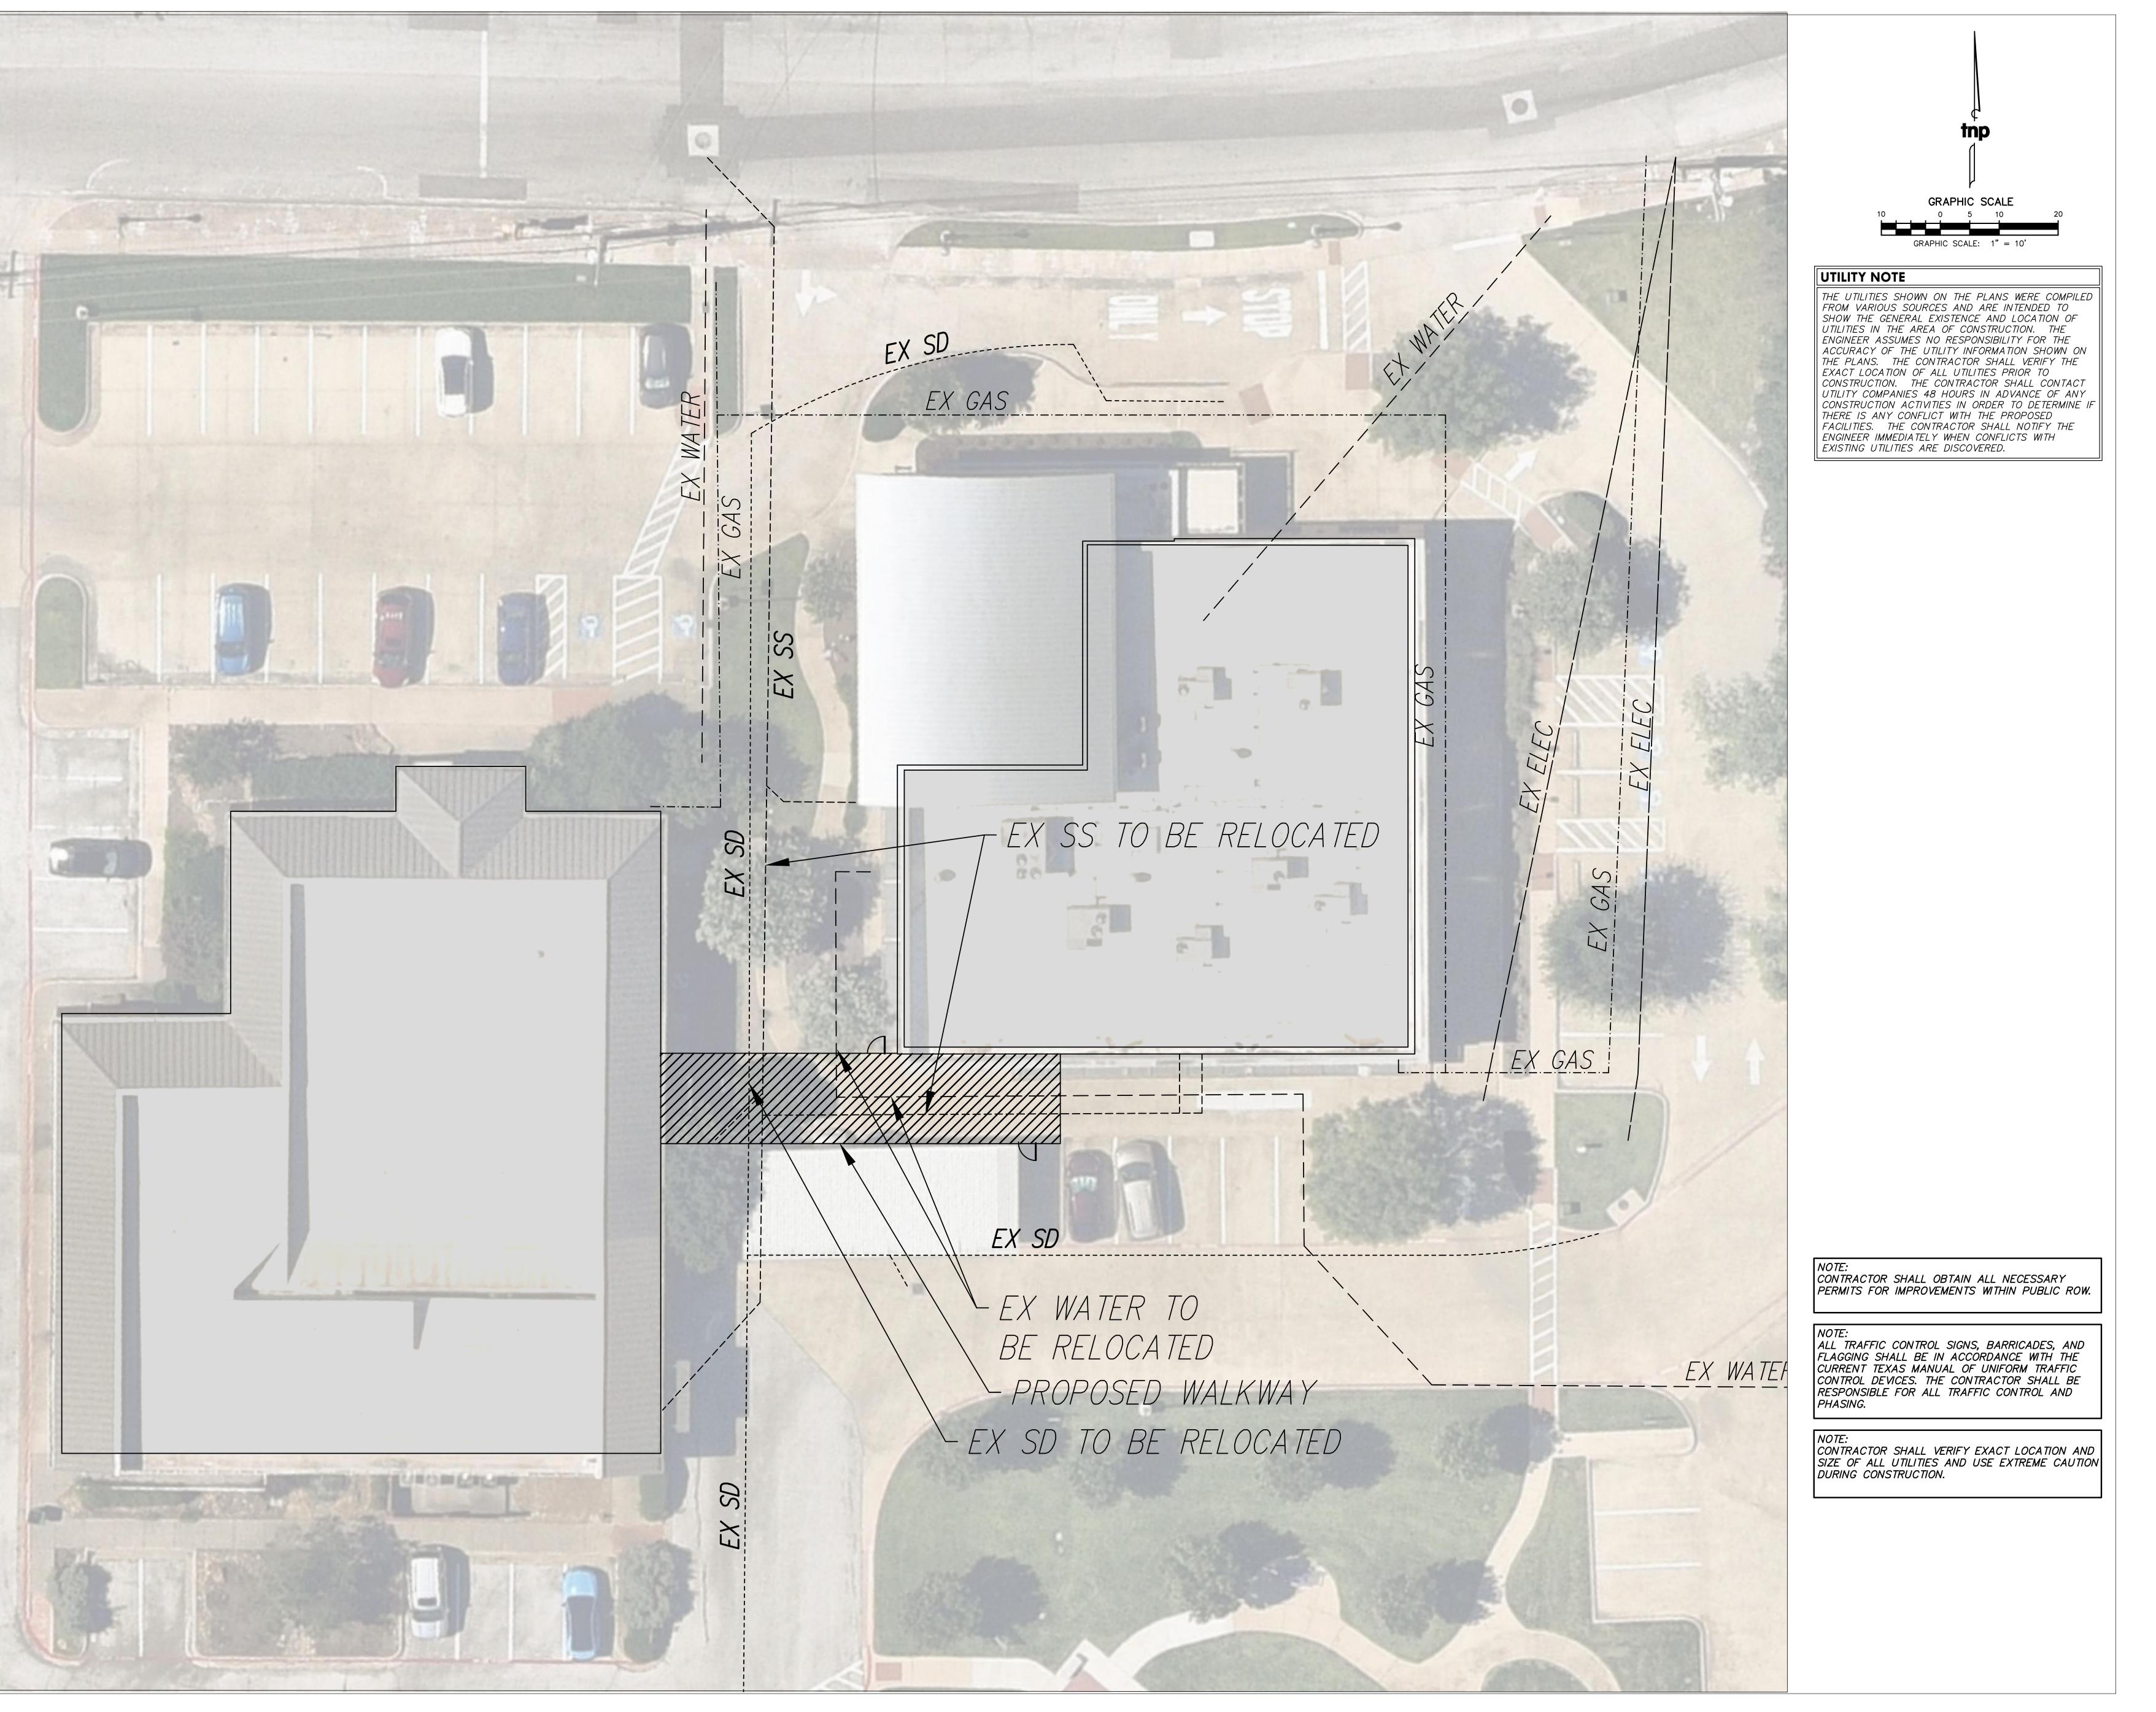

CLIENT


City of Saginaw, Texas

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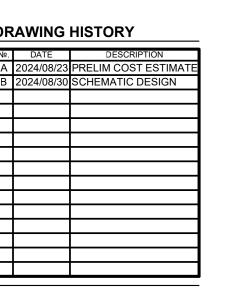
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3131 Briarpark Dr.
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T 713 622 1444
F 713 622 1444
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PROJECT NAME
SAGINAW
KEETER
BUILDING
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355 W McLeroy Blvd.
Saginaw,TX 76179

PROJECT NUMBER 1006633.02

SHEET TITLE

EX UTILITY EXHIBIT

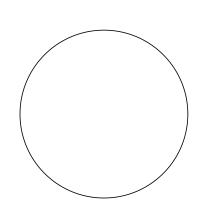SHEET NUMBER

EX-2



Saginaw Keeter Building Renovation Schematic Design – Preliminary Cost Estimate STRUCTURAL NARRATIVE

Descriptive Specifications

Concrete

Normal weight Portland cement concrete with 3" to 7" slump, depending on the application. Minimum 28-day compressive strength:

Drilled Piers	4,000 psi
Grade Beams, Pilasters, and Pier Caps	4,000 psi
Slab-on-Void	4,000 psi
Elevated Slabs	4,000 psi

Reinforcing Steel

Deformed Bars (typical)

ASTM A615, Grade 60

• Structural Steel

Wide-Flange Shapes ASTM A992
Steel Angles, Channels, Plates ASTM A36
Steel Tubes (HSS) ASTM A500, GR C (50 ksi)
Steel Pipe ASTM A53, GR B or A500, GR C
Field Bolted Connections ASTM A325 Bolts
Anchor Rods ASTM F1554, GR 36
Welding 70 ksi Filler Metal per AWS D1.1

Steel Roof Deck

1 1/2", 20 GA, Type B (wide rib) roof deck; ASTM A653, G60 Galv. Finish.

Design Analysis

• Codes and Standards

The following codes and standards will be used for the structural design of the project:

International Building Code (IBC), 2021 Edition.

International Existing Building Code (IBC), 2021 Edition.

D.24 Page 2 of 4

American Society of Civil Engineers (ASCE) 7, Minimum Design Loads for Buildings and Other Structures.¹

American Concrete Institute (ACI) 318, Building Code Requirements for Structural Concrete.¹

American Institute of Steel Construction (AISC) Specification for Structural Steel Buildings, AISC 360.¹

Design Loads

Dead Loads

Design dead loads for the structural frame will include self-weight of the structural elements and the following superimposed dead loads:

Ceiling and Mechanical at Roof	10 psf
Roofing and Rigid Insulation	15 psf
Ceiling and Mechanical at Floors	5 psf

Live Loads

Based on the anticipated functions to be contained in the building, the following superimposed live loads will be utilized in the design of the structural frame:

Public areas, corridors, lobbies	100 psf
Offices	50 psf
Partitions at areas with less than 80 psf live load	15 psf
Mechanical rooms	150 psf
Storage (minimum)	125 psf
Restrooms	60 psf
Roof (unreducible)	20 psf

Wind Loads

Wind Loads will be determined per ASCE 7 using the following anticipated parameters:

Wind Speed (3-sec gust)	106 MPH
Exposure Category	"C"
Enclosed Structure	

Seismic Loads

Seismic loads will be determined per ASCE 7-16 using the following anticipated parameters:

Site Class	С
Seismic Design Category	Α
Seismic Importance Factor	1.00
Response Modification Factor	3

¹ The edition of the standard will be the edition referenced in the noted edition of the International Building Code.



Snow Loads

Snow loads will be determined per ASCE 7 using the following anticipated parameters: Ground snow load, Pg 5 psf

Ice Loads

Ice loads will be determined per ASCE 7 using the following anticipated parameters: Ice thickness 11/2"

Building Addition Superstructure

The superstructure of the building must be adequate to resist the applied design loading, satisfy the performance criteria for such items as deflection and vibration control, and accommodate the architectural design. For this building the following structural systems are recommended:

Ground Level Structure

It is anticipated that the ground floor will consist of a 5" slab-on-grade reinforced with #3 bars at 16" on-center each way, over prepared subgrade. Subgrade preparation is anticipated to consist of removal of on-site expansive soils and replacement with select fill, or a combination of moisture conditioned on-site soil and select fill. The slab-on-grade will be placed over a 15 mil, Class A vapor retarder. Perimeter grade beams are anticipated to be 16" wide x 24" deep with 18 plf of reinforcing. Grade beams will be isolated from the subgrade with 8" to 12" deep carton void forms, and soil retainers each side to prevent soil from entering the void space.

Typical Roof Structure

It is anticipated that the roof framing will consist of 1.5" deep x 20 gage steel roof deck, open-web steel joists, and steel girders. Wide-flange, tube steel, and pipe columns will be used to support the superstructure. Additional miscellaneous steel will be required to support the proposed prefabricated canopies.

Foundation

The foundation for the building will be designed in accordance with the final Geotechnical Engineering Report prepared specifically for this site. Based on our previous experience, it is anticipated that the foundation system will consist of drilled, straight shaft bearing at a depth to be determined by the geotechnical report in unweathered limestone or shale. Typical piers will be approximately 24 inches in diameter, reinforced with 6 - #6 vertical bars and #3 ties at 18" on-center, with 10 feet of penetration into the bearing strata.

Lateral Stability

The lateral stability of the building will be provided by rigid steel frames and steel bracing located so as to have minimal impact on the architectural configuration of the building.



Existing Library Building

JQ now IMEG currently does not have structural drawings for the existing Library Building. From field investigations, the existing building consists of structural steel framing with wide-flange columns, wide-flange girders, and cold-formed c-purlin joists. The existing foundation is unknown but is anticipated to be a structural slab-on-grade slab with isolated piers underneath the columns.

A new mechanical unit is planned to be installed on the existing roof. The existing roof will need to be reinforced for this additional load. Roof reinforcement will include doubling-up of c-purlins and reinforcement of wide-flange girders with nestled steel channels welded to the web. Final reinforcement information will be determined once the mechanical unit weight is finalized.

The new bathrooms in the existing library will require penetrations/trenching in the existing slab. Explorational coring of the existing slab should be performed prior to slab demolition to confirm foundation type.



GENERAL ROOF NOTES

- 1. CONTRACTOR SHALL FIELD VERIFY ALL EXISTING CONDITIONS PRIOR TO COMMENCING
- 2. CONTRACTOR SHALL NOTIFY ARCHITECT OF ANY DISCREPANCY, INACCURACY OR
- 3. DO NOT SCALE DIMENSIONS FROM DRAWINGS, ANY UNKNOWN DIMENSION SHALL BE OBTAINED FROM DESIGN PROFESSIONALS VIA REQUEST FOR INFORMATION (RFI). 4. CONTRACTOR SHALL FIELD COORDINATE LOCATION, SIZE AND TYPE OF BLOCKING FOR

CONFLICTING INFORMATION BEFORE EXECUTION OF WORK.

- INSTALLATION OF SIGNAGE, PLUMBING FIXTURES, MILLWORK, ETC. ALL CONCEALED WOOD SHALL BE FIRE RETARDANT TREATED (F.R.T).
- 5. ALL SHAFTS PENETRATING SLAB SHALL BE RATED 2HR. 6. ALL FLAT ROOF SLOPES SHALL BE 1/4" PER FOOT U.N.O.
- 7. PROVIDE WALKWAY ROOF PADS TO AND FROM ALL ACCESS POINTS AND AROUND THE PERIMETER OF ALL EQUIPMENT IN ACCORDANCE WITH THE PROJECT SPECIFICATIONS AND ROOF MANUFACTURER SPECIFICATIONS.

ROOF GRAPHICS LEGEND

STRUCTURAL ROOF MARKUP

INDICATES 1/4" PER FOOT SLOPE TO DRAIN AT ROOF OR 2% SLOPE TO DRAIN AT EXTERIOR TERRACE

NOTE: KEYNOTE NUMBERING IS FOR ORGANIZATIONAL PURPOSES ONLY AND NOT INTENDED TO REFERENCE A SPECIFIC CSI DIVISION

DESCRIPTION

City of Saginaw, Texas

333 West McLeroy Blvd. Saginaw, TX 76179 T 817 232 4640

F 817 232 0311

ARCHITECT



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DRAWING HISTORY

DR	DRAWING HISTORY				
Nº.	DATE	DESCRIPTION			
Α	2024/08/30	SCHEMATIC DESIGN			

PROJECT NAME SAGINAW KEETER BUILDING RENOVATION

PROJECT LOCATION 355 W McLeroy Blvd. Saginaw,TX 76179

PROJECT NUMBER 1006633.02

SHEET TITLE OVERALL ROOF

SHEET NUMBER

S2.30

GENERAL RCP NOTES

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- 2. CONTRACTOR SHALL FIELD VERIFY ALL EXISTING CONDITIONS PRIOR TO COMMENCING
- CONTRACTOR SHALL NOTIFY THE ARCHITECT OF ANY DISCREPANCY, INACCURACY OR CONFLICTING INFO. PRIOR TO EXECUTION OF THE WORK.
- REFER TO PARTITION INFORMATION FOR ADDITIONAL INFORMATION.
 ALL SHAFTS PENETRATING SLABS SHALL BE RATED 2HR.
 LIGHT FIXTURES ARE DIMENSIONED TO CENTERLINE OF FIXTURE, OR PROVIDE THE "CL"
 (CENTERLINE) SYMBOL, AND COR LINE TYPE ON THE DIMENSION STRING AT EACH

9. CEILING GRIDS SHALL BE CENTERED IN ROOMS U.N.O.

(CENTERLINE) SYMBOL, AND / OR LINE TYPE ON THE DIMENSION STRING AT EACH FIXTURE.
7. REFER TO ELECTRICAL DRWGS FOR FIXTURE DESIGNATIONS AND TYPES.
8. FIXTURES SHALL BE CENTERED BETWEEN WALLS U.N.O.

RCP GRAPHIC LEGEND

ACT-1

2x2 ACOUSTICAL CEILING TILE SYSTEM

PAINTED, (1) LAYER 5/8" GWB CEILING ON METAL FRAMING SYSTEM.

STR-1

EXPOSED STRUCTURE PAINTED BLACK.

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Saginaw,TX 76179

PROJECT NUMBER 1006633.02

SHEET TITLE
OVERALL
REFLECTED
CEILING PLAN

SHEET NUMBER

S3.10

STRUCTURAL FOUNDATION MARKUP

- FFE OF 0'-0" IN THESE PLANS REFERS TO CIVIL ELEVATION XX.XX' NAVD OR XX.XX' NGVD.
 CONTRACTOR SHALL FIELD VERIFY ALL EXISTING CONDITIONS PRIOR TO COMMENCING WORK.
- 3. CONTRACTOR SHALL NOTIFY ARCHITECT OF ANY DISCREPANCY, INACCURACY OR CONFLICTING INFORMATION BEFORE EXECUTION OF WORK.

 4. DO NOT SCALE DIMENSIONS FROM DRAWINGS, ANY UNKNOWN DIMENSION SHALL BE OBTAINED
- FROM DESIGN PROFESSIONALS VIA REQUEST FOR INFORMATION (RFI).

 5. REFER TO CIVIL AND LANDSCAPE DWGS FOR ALL INFORMATION REGARDING SITE ELEMENTS INCLUDING BUT NOT LIMITED TO PAVING, GRADING, SITE DRAINAGE, PLANTINGS ECT.



City of Saginaw, Texas

333 West McLeroy Blvd. Saginaw, TX 76179 T 817 232 4640 F 817 232 0311

ARCHITECT



PGAL, Inc.
3131 Briarpark Dr.
Suite 200
Houston, TX 77042
T 713 622 1444
F 713 622 1444
www.pgal.com

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DRAWING HISTORY

 №.
 DATE
 DESCRIPTION

 A
 2024/08/23
 SCHEMATIC DESIGN

PROJECT NAME SAGINAW KEETER BUILDING RENOVATION

PROJECT LOCATION 355 W McLeroy Blvd. Saginaw,TX 76179


PROJECT NUMBER 1006633.02

SHEET TITLE OVERALL DEMO SITE PLAN

SHEET NUMBER

AD1.01



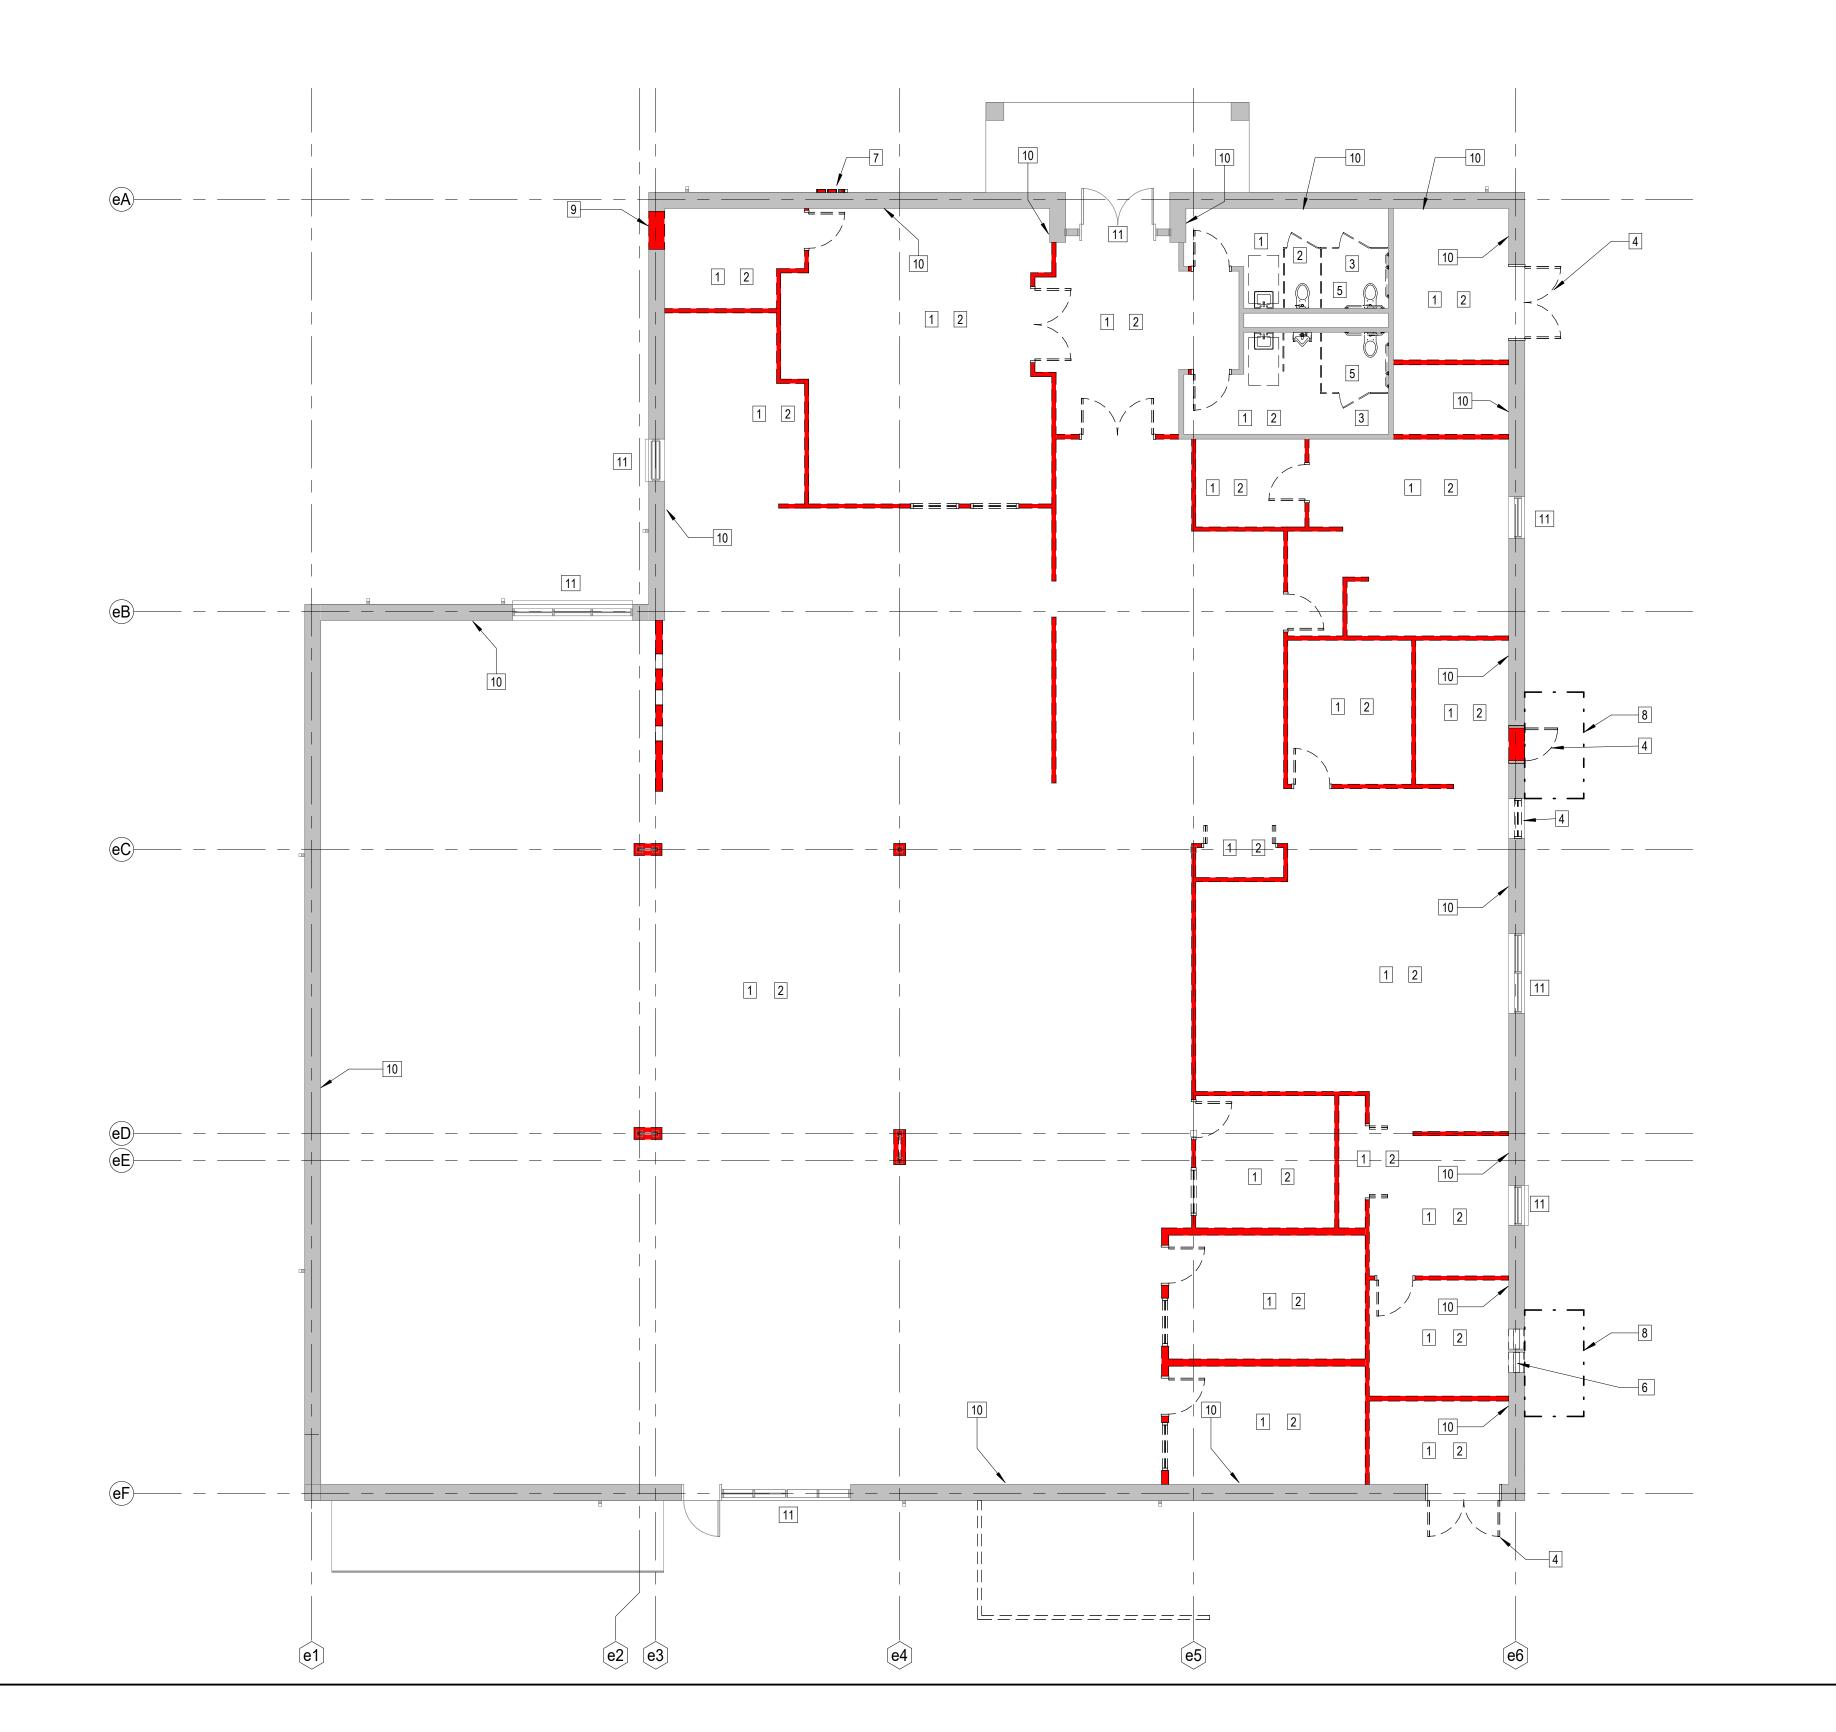

DEMO FLOOR PLAN 1/8" = 1'-0" 1

GENERAL DEMOLITION NOTES

- ROOM AND DOOR REFERENCE NUMBERS ARE FOR CONSTRUCTION COORDINATION ONLY. CONTRACTOR SHALL COORDINATE WITH OWNER FOR FINAL ROOM & DOOR IDENTIFICATION.
- 2. DO NOT SCALE DIMENSIONS FROM DRAWINGS, ANY UNKNOWN DIMENSION SHALL BE OBTAINED FROM DESIGN PROFESSIONALS VIA REQUEST FOR INFORMATION (RFI).
- ALL DIMENSIONS ARE TO FACE OF GYP., GRID LINES AND FACE OF WALL U.N.O. ALL DIMENSIONS TO EXISTING WALLS ARE TO FACE OF WALL ASSEMBLY U.N.O.
 ALL 36" WIDE INTERIOR SWING DOORS SHALL BE LOCATED 2'-0" FROM CENTER OF DOOR TO
- ALL 36" WIDE INTERIOR SWING DOORS SHALL BE LOCATED 2'-0" FROM CENTER OF DOOR PERPENDICULAR SURFACE OF ADJACENT WALL AT DOOR JAMB U.N.O.
 CONTRACTOR SHALL FIELD VERIFY ALL EXISTING CONDITIONS PRIOR TO COMMENCING WORK
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- REFER TO WALL TYPE SCHEDULE FOR ADDITIONAL INFORMATION.
 CONTRACTOR SHALL FIELD COORDINATE LOCATION, SIZE AND TYPE OF BLOCKING FOR INSTALLATION OF SIGNAGE, MILLWORK, ETC. ALL CONCEALED WOOD SHALL BE FIRE RETARDANT TREATED (F.R.T.)
- PROVIDE IN-WALL REINFORCEMENT FOR ALL WALL MOUNTED FURNITURE AND EQUIPMENT AS REQUIRED.
 GENERAL CONTRACTOR IS RESPONSIBLE TO CONFIRM THAT ABATEMENT OF HAZARDOUS MATERIALS ARE COMPLETED PRIOR TO THE START OF ANY WORK. COORDINATE WITH

CUTTING AND PATCHING NOTES

- PROVIDE MATERIALS FOR CUTTING AND PATCHING WHICH WILL RESULT IN EQUAL-OR-BETTER WORK THAN THAT BEING CUT OR PATCHED.
- 2. CAREFULLY REMOVE EXISTING COMPONENTS THAT ARE TO BE REMOVED, SO AS NOT TO DAMAGE EXISTING CONSTRUCTION THAT IS TO REMAIN. PATCH FLOORS/WALLS IN A RECTANGULAR PATTERN TO MATCH EXISTING CONDITIONS AND MAKE THEM READY TO RECEIVE ANY NEW WORK INDICATED.
- 3. CONTRACTOR TO FIELD VERIFY LOCATION OF ALL EXISTING UTILITIES. COORDINATE DEMOLITION AS REQUIRED TO AVOID DAMAGE TO EXISTING UTILITY LINES. CONTRACTOR WILL BE RESPONSIBLE FOR REPAIRING AND PATCHING UTILITY LINES DAMAGED DURING CONSTRUCTION.
- 4. WHERE EXISTING AREAS OF FLOOR FINISH IS TO BE REMOVED, SURFACES TO REMAIN SHALL BE STRIPPED CLEAN AND MADE READY TO RECEIVE NEW WORK. FLOAT FLOOR AS REQUIRED FOR A LEVEL FLOOR FINISH.

DEMO PLAN GRAPHICS LEGEND

INDICATES WALLS TO BE DEMOLISHED

INDICATES SCOPE OF WORK

1 REMOVE FLOORING AND PREP FOR NEW FINISHES.

REMOVE CEILINGS AND ASSOCIATED LIGHTS AND DEVICES RE: MEP.

DEMO RESTROOM PARTITIONS AND ASSOCIATED FRAMING.

DEMO EXTERIOR DOOR/WINDOW AND FRAME AND PREP FOR NEW WORK.

DEMO RESTROOM FIXTURES AND ASSOCIATED PLUMBING RE: MEP.

6 DEMO BOOK DROP AND PREP FOR NEW WORK.

DEMO BUILDING SIGNAGE AND REPAIR WALL.

DEMO CANOPY AND PREP FOR NEW WORK.

DEMO PARTIAL EXTERIOR WALL AND PREP FOR NEW WORK.

PREP EXISTING WINDOWS FOR NEW CAULKING

DEMO EXISTING FINISHES ON ENTIRE INTERIOR GYP. FACE.

KEYNOTE LEGEND

NOTE: KEYNOTE NUMBERING IS FOR ORGANIZATIONAL PURPOSES ONLY AND NOT INTENDED TO REFERENCE A SPECIFIC CSI DIVISION

SAGINAV

City of Saginaw, Texas

333 West McLeroy Blvd. Saginaw, TX 76179 T 817 232 4640 F 817 232 0311

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DRAWING HISTORY

Nº. DATE DESCRIPTION
A 2024/08/23 SCHEMATIC DESIGN

PROJECT NAME
SAGINAW
KEETER
BUILDING
RENOVATION

PROJECT LOCATION

355 W McLeroy Blvd.

Saginaw,TX 76179

PROJECT NUMBER 1006633.02

SHEET TITLE
OVERALL DEMO
FLOOR PLAN

SHEET NUMBER

AD2.10

THIS SECTION OF EXISTING ROOF TO BE DEMOLISHED. NEW ROOF TIE IN AT THIS

DEMO ROOF PLAN 1/8" = 1'-0" (1)

GENERAL DEMO ROOF NOTES

- 1. CONTRACTOR SHALL FIELD VERIFY ALL EXISTING CONDITIONS PRIOR TO COMMENCING
- 2. CONTRACTOR SHALL NOTIFY ARCHITECT OF ANY DISCREPANCY, INACCURACY OR

CONFLICTING INFORMATION BEFORE EXECUTION OF WORK.

- 3. DO NOT SCALE DIMENSIONS FROM DRAWINGS, ANY UNKNOWN DIMENSION SHALL BE OBTAINED FROM DESIGN PROFESSIONALS VIA REQUEST FOR INFORMATION (RFI). 4. CONTRACTOR SHALL FIELD COORDINATE LOCATION, SIZE AND TYPE OF BLOCKING FOR
- INSTALLATION OF SIGNAGE, PLUMBING FIXTURES, MILLWORK, ETC. ALL CONCEALED WOOD SHALL BE FIRE RETARDANT TREATED (F.R.T).
- 5. ALL SHAFTS PENETRATING SLAB SHALL BE RATED 2HR.
- 6. ALL FLAT ROOF SLOPES SHALL BE 1/4" PER FOOT U.N.O. 7. PROVIDE WALKWAY ROOF PADS TO AND FROM ALL ACCESS POINTS AND AROUND THE PERIMETER OF ALL EQUIPMENT IN ACCORDANCE WITH THE PROJECT SPECIFICATIONS AND ROOF MANUFACTURER SPECIFICATIONS.

ROOF GRAPHICS LEGEND

INDICATES 1/4" PER FOOT SLOPE TO DRAIN AT ROOF OR 2% SLOPE TO DRAIN AT EXTERIOR TERRACE

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AWING HISTORY				
		-		
DATE	DESCRIPTION			
2024/08/23	SCHEMATIC DESIGN			
		-		
		-		

PROJECT NAME SAGINAW KEETER BUILDING RENOVATION


PROJECT LOCATION 355 W McLeroy Blvd. Saginaw,TX 76179

PROJECT NUMBER 1006633.02

SHEET TITLE OVERALL DEMO ROOF PLAN

SHEET NUMBER

AD2.30

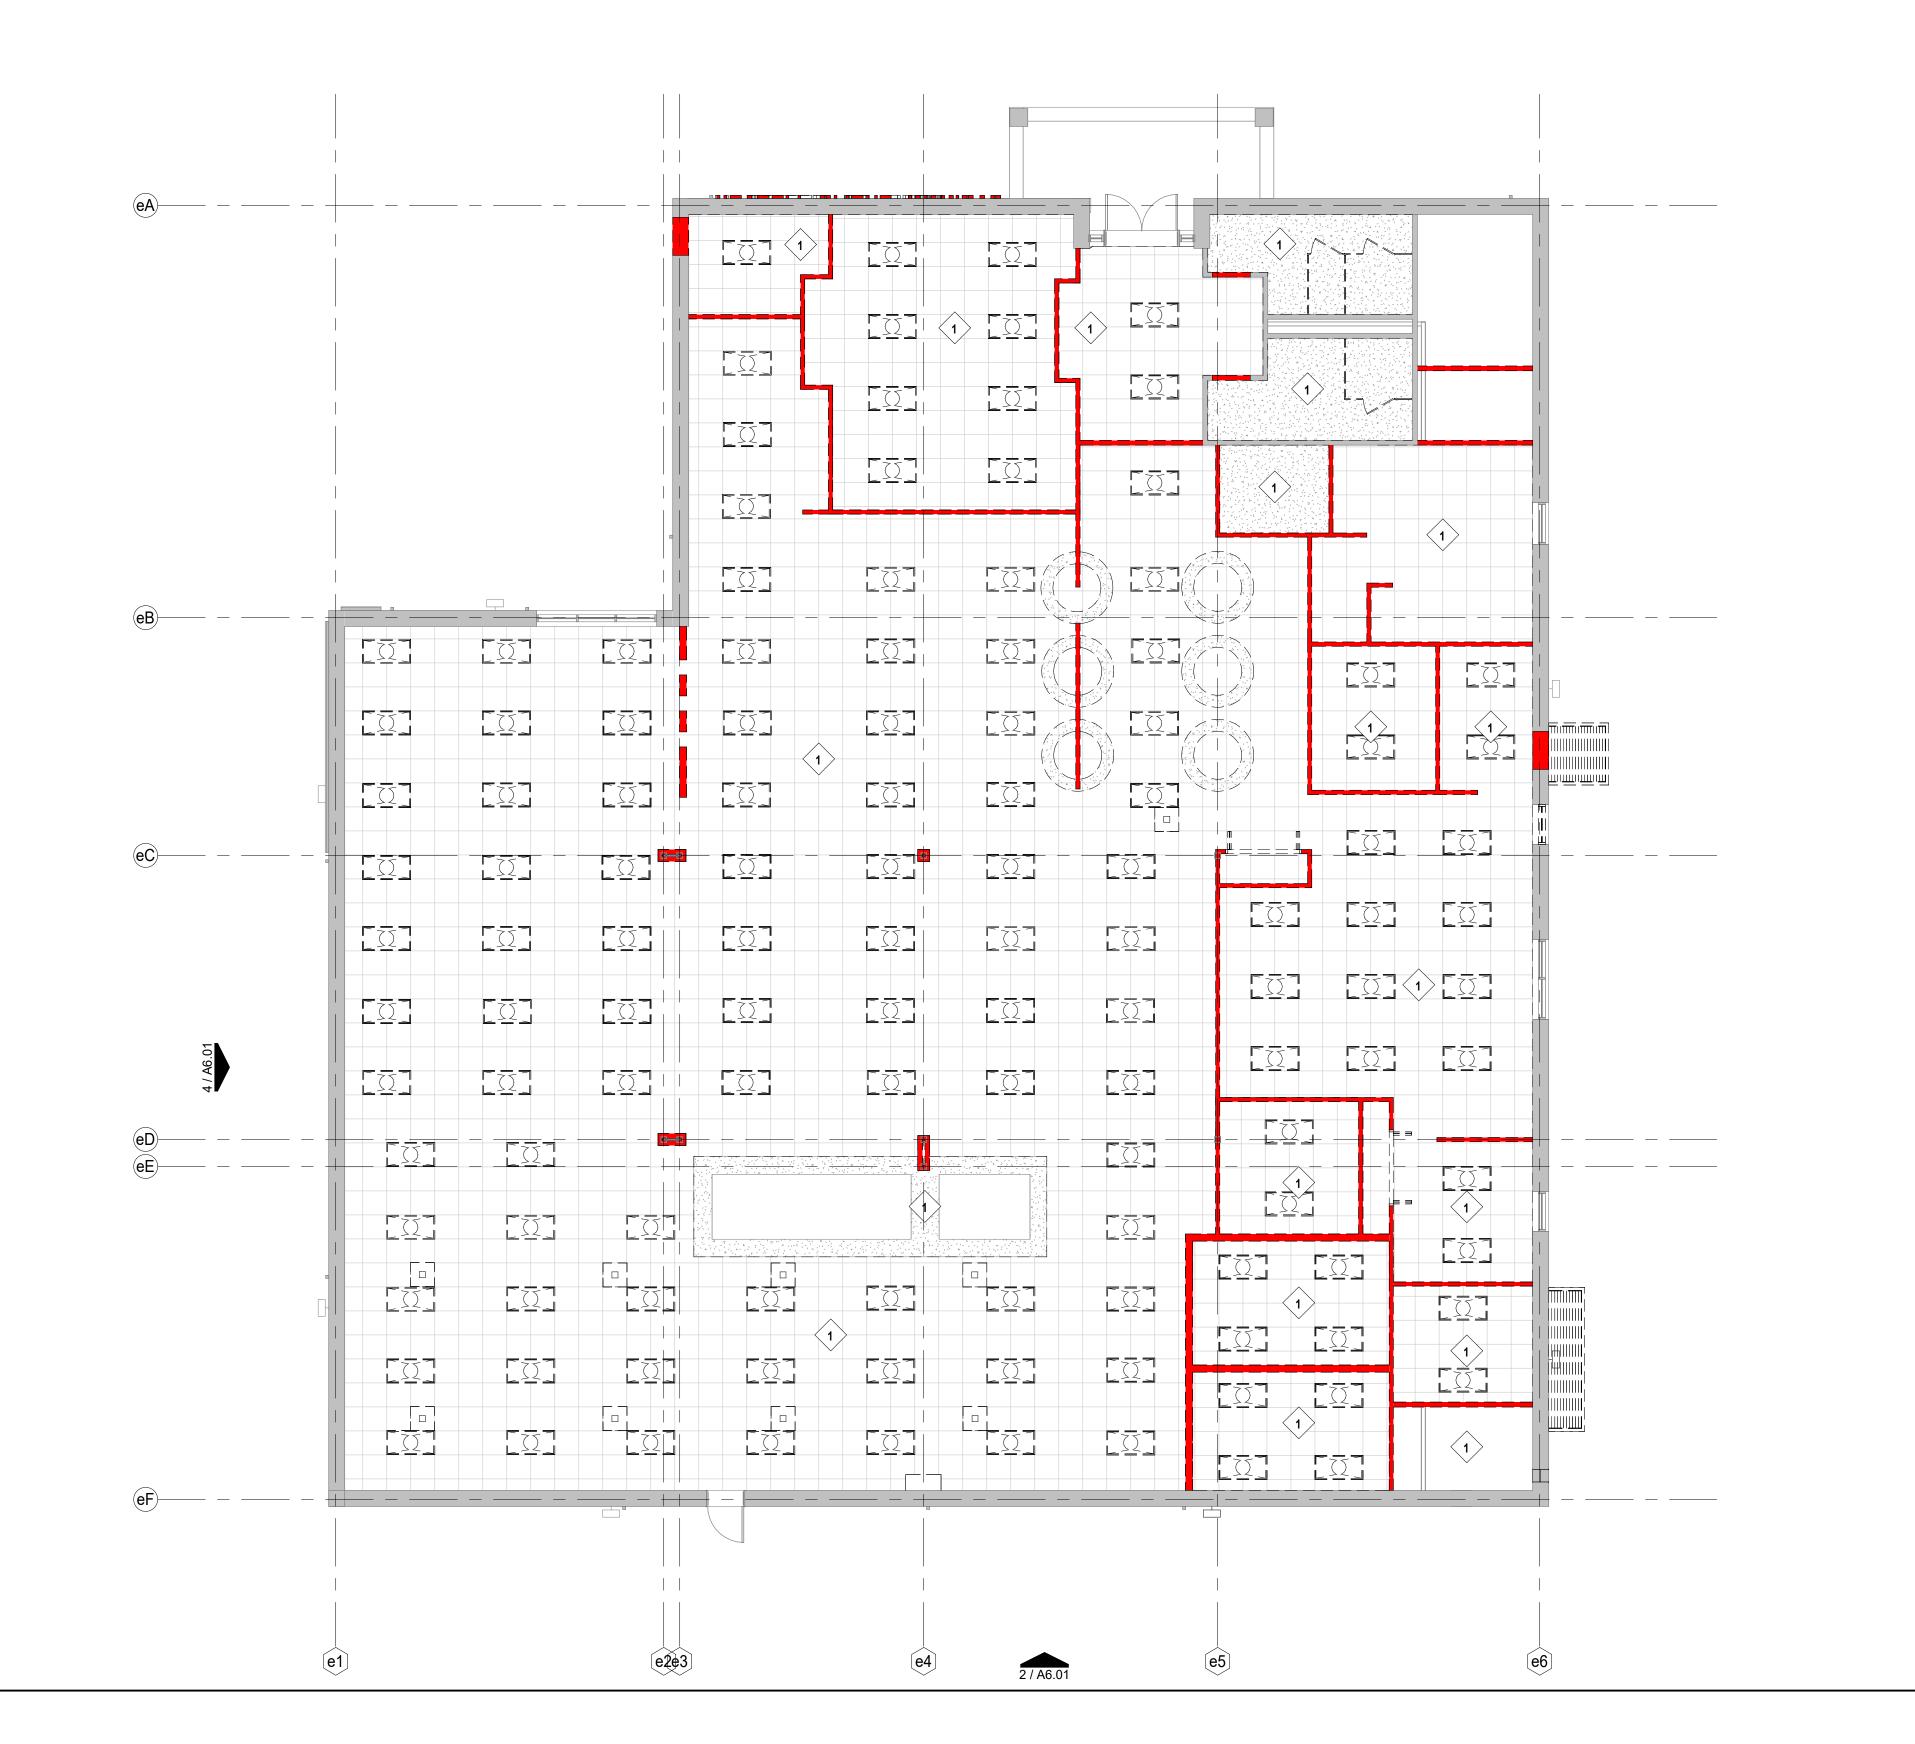

GENERAL DEMO RCP NOTES

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- 7. REFER TO WALL TYPE SCHEDULE FOR ADDITIONAL INFORMATION.

 8. CONTRACTOR SHALL FIELD COORDINATE LOCATION, SIZE AND TYPE OF BLOCKING FOR
- INSTALLATION OF SIGNAGE, MILLWORK, ETC. ALL CONCEALED WOOD SHALL BE FIRE RETARDANT TREATED (F.R.T.)

 9. PROVIDE IN-WALL REINFORCEMENT FOR ALL WALL MOUNTED FURNITURE AND EQUIPMENT
- AS REQUIRED.

 10. LICENSED FIRE SUPPRESSION/FIRE ALARM CONTRATOR TO MODIFY SPRINKLER LINES AS REQUIRED PER AHJ REQUIREMENTS.

CUTTING AND PATCHING NOTES

- 1. PROVIDE MATERIALS FOR CUTTING AND PATCHING WHICH WILL RESULT IN EQUAL-OR-BETTER WORK THAN THAT BEING CUT OR PATCHED.
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- WILL BE RESPONSIBLE FOR REPAIRING AND PATCHING UTILITY LINES DAMAGED DURING CONSTRUCTION.


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- REQUIRED FOR A LEVEL FLOOR FINISH.

DEMO PLAN GRAPHICS LEGEND



INDICATES NOT IN SCOPE

EXISTING TO BE DEMOLISHED

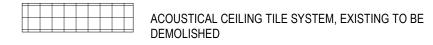

DEMOLISHED

GYPSUM BOARD CEILING ON METAL FRAMING SYSTEM,



REMOVE ALL CEILING TILES AND GRIDS AND PREP. FOR NEW CEILING TREATMENT. PREP ANY GYPSUM BOARD CEILINGS FOR NEW FINISHES. REMOVE ALL EXISTING CEILING LIGHTS AND DIFFUSERS.



DIFFUSER, EXISTING TO BE DEMOLISHED

2' X 4' LIGHT FIXTURE, EXISTING TO BE DEMOLISHED

KEYNOTE LEGEND

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DRAWING HISTORY

Nº. DATE DESCRIPTION
A 2024/08/23 SCHEMATIC DESIGN

PROJECT NAME
SAGINAW
KEETER
BUILDING
RENOVATION

PROJECT LOCATION

355 W McLeroy Blvd.
Saginaw,TX 76179

PROJECT NUMBER 1006633.02

SHEET TITLE
OVERALL DEMO
REFLECTED
CEILING PLAN

SHEET NUMBER

AD3.10



EXISTING CITY HALL

DEMOLISH ALL EXISTING CEILINGS AND

CORRESPONDING FRAMING. SALVAGE

ALL CEILING DEVICES FOR

REINSTALLATION.

ROOM FINISH SCHEDULE

	ROOM DATA	FLOOR	W	/ALL FINISH (AL	1	WALL F	FINISHES		CEILINGS	
Nº	NAME	FINISH	BASE FINISH	U.N.O.)	NORTH	EAST	SOUTH	WEST	FINISH	COMMENTS
00A	VESTIBULE	TILE	TILE	PAINT		-			GYP. BD.	
100B	LOBBY	TILE	TILE	PAINT		ACOUSTIC PANEL			GYP. BD.	
101	PUBLIC WORKS CONF.	CARPET	RUBBER	PAINT	ACOUSTIC PANE	L ACOUSTIC PANEL	ACOUSTIC PANEL		CEILING TILE	
102	CONF. STORAGE	VINYL TILE	RUBBER	PAINT					CEILING TILE	
103	FIRE RISER	CONCRETE	RUBBER	PAINT					OPEN TO STRUC.	
104A	F. DESK MARIA	CARPET	RUBBER	PAINT					CEILING TILE	
104R	F. DESK SALVADOR	CARPET	RUBBER	PAINT					CEILING TILE	
105	WOMEN'S RESTROOM	TILE	TILE	TILE				PAINT	GYP. BD.	
106	MEN'S RESTROOM	TILE	TILE	TILE				PAINT	GYP. BD.	
107	PRIVATE BREAKROOM	VINYL TILE	RUBBER	PAINT		TILE		FAINT	CEILING TILE	
107	JAN. CLOSET	VINYL TILE	RUBBER	PAINT		IILC			CEILING TILE CEILING TILE	
					FDD	FDD				
109	ELECTRICAL	CONCRETE	RUBBER	PAINT	FRP	FRP		DAINIT	OPEN TO STRUC.	
110	MEN'S RR	TILE	TILE	TILE				PAINT	GYP. BD.	
111	WOMEN'S RR	TILE	TILE	TILE				PAINT	GYP. BD.	
112	CITY SECRETARY (PO5)	CARPET	RUBBER	PAINT					CEILING TILE	
113	C.S. SECURED STORAGE	CARPET	RUBBER	PAINT					CEILING TILE	
114	COMM. (PO5) COMM. MANAGER	CARPET	RUBBER	PAINT					CEILING TILE	
115	AV STORAGE	CARPET	RUBBER	PAINT					CEILING TILE	
116	TECHNOLOGY SHARED OFFICE	CARPET	RUBBER	PAINT					CEILING TILE	
117	SHARED SPACE COPY/WORKROOM	VINYL TILE	RUBBER	PAINT					CEILING TILE	
118	SHARED SPACE MUD ROOM	VINYL TILE	RUBBER	PAINT					CEILING TILE	
119	BUILD DEPT. CUSTOM POD	CARPET	RUBBER	PAINT					CEILING TILE	
120	BUILD DEPT. CONF.	CARPET	RUBBER	PAINT					CEILING TILE	
121	BUILD DEPT. (PO6) CHIEF BUILD OFFICIAL	CARPET	RUBBER	PAINT					CEILING TILE	
122	PUBLIC WORKS (PO6) DEPT. DIRECTOR	CARPET	RUBBER	PAINT					CEILING TILE	
123	ECONIMIC DEV. (PO6) DEPT. DIRECTOR	CARPET	RUBBER	PAINT					CEILING TILE	
124A	STORAGE	CONCRETE	RUBBER	PAINT					OPEN TO STRUC.	
124B	MDF	CONCRETE	RUBBER	PAINT					OPEN TO STRUC.	
125	OPEN OFFICE	CARPET	RUBBER	PAINT					CEILING TILE	
126	ASST. DIRECTOR	CARPET	RUBBER	PAINT					CEILING TILE	
127		CARPET	RUBBER	PAINT					CEILING TILE CEILING TILE	
	P.W. (PO5) PLANNING MANAGER									
128	P.W. (PO5) ENV. MANAGER	CARPET	RUBBER	PAINT					CEILING TILE	
129	PUBLIC WORKS (PO5) ENV. TECH.	CARPET	RUBBER	PAINT					CEILING TILE	
130	P.W (PO5) CODE ENF. OFFICER	CARPET	RUBBER	PAINT					CEILING TILE	
131	B.D. (PO5) CODE ENF. MANAGER	CARPET	RUBBER	PAINT					CEILING TILE	
132	OPEN OFFICE	CARPET	RUBBER	PAINT					CEILING TILE	
133	E.D. (WS) ASSISTENT	CARPET	RUBBER	PAINT					CEILING TILE	
134	P.W. (WS) INTERN/ENV. TECH	CARPET	RUBBER	PAINT					CEILING TILE	
135	B.D. (WS) PERMIT TECH.	CARPET	RUBBER	PAINT					CEILING TILE	
136	B.D. (WS) PERMIT TECH.	CARPET	RUBBER	PAINT					CEILING TILE	
137	STORAGE	VINYL TILE	RUBBER	PAINT					CEILING TILE	
138	STORAGE	VINYL TILE	RUBBER	PAINT					CEILING TILE	
139	STORAGE	VINYL TILE	RUBBER	PAINT					CEILING TILE	
140	STORAGE	VINYL TILE	RUBBER	PAINT					CEILING TILE	
C100	CORRIDOR	CARPET	RUBBER	PAINT					CEILING TILE	
C101	CORRIDOR	CARPET	RUBBER	PAINT					CEILING TILE	
C102	CORRIDOR	CARPET	RUBBER	PAINT					CEILING TILE	
C103	CORRIDOR	CARPET	RUBBER	PAINT					CEILING TILE	
C104	CORRIDOR	CARPET	RUBBER	PAINT					CEILING TILE	
C105	CORRIDOR	CARPET	RUBBER	PAINT					CEILING TILE	
C106	CORRIDOR	CARPET	RUBBER	PAINT					CEILING TILE	
C100	CORRIDOR	VINYL TILE	RUBBER	PAINT					GYP. BD.	
C108 EL 01	VESTIBULE	WALKOFF	RUBBER	PAINT					GYP. BD.	



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DRAWING HISTORY

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Nº.	DATE	DESCRIPTION
Α	2024/08/23	SCHEMATIC DESIGN

PROJECT NAME SAGINAW KEETER BUILDING RENOVATION

PROJECT LOCATION 355 W McLeroy Blvd. Saginaw,TX 76179

PROJECT NUMBER 1006633.02

SHEET TITLE
FINISH LEGEND &
SCHEDULE

SHEET NUMBER

A0.20

- FFE OF 0'-0" IN THESE PLANS REFERS TO CIVIL ELEVATION XX.XX' NAVD OR XX.XX' NGVD.
 CONTRACTOR SHALL FIELD VERIFY ALL EXISTING CONDITIONS PRIOR TO COMMENCING WORK.
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SAGINAW
KEETER
BUILDING
RENOVATION

PROJECT LOCATION


355 W McLeroy Blvd.
Saginaw,TX 76179

PROJECT NUMBER 1006633.02

SHEET TITLE
SITE PLAN

SHEET NUMBER

A1.01

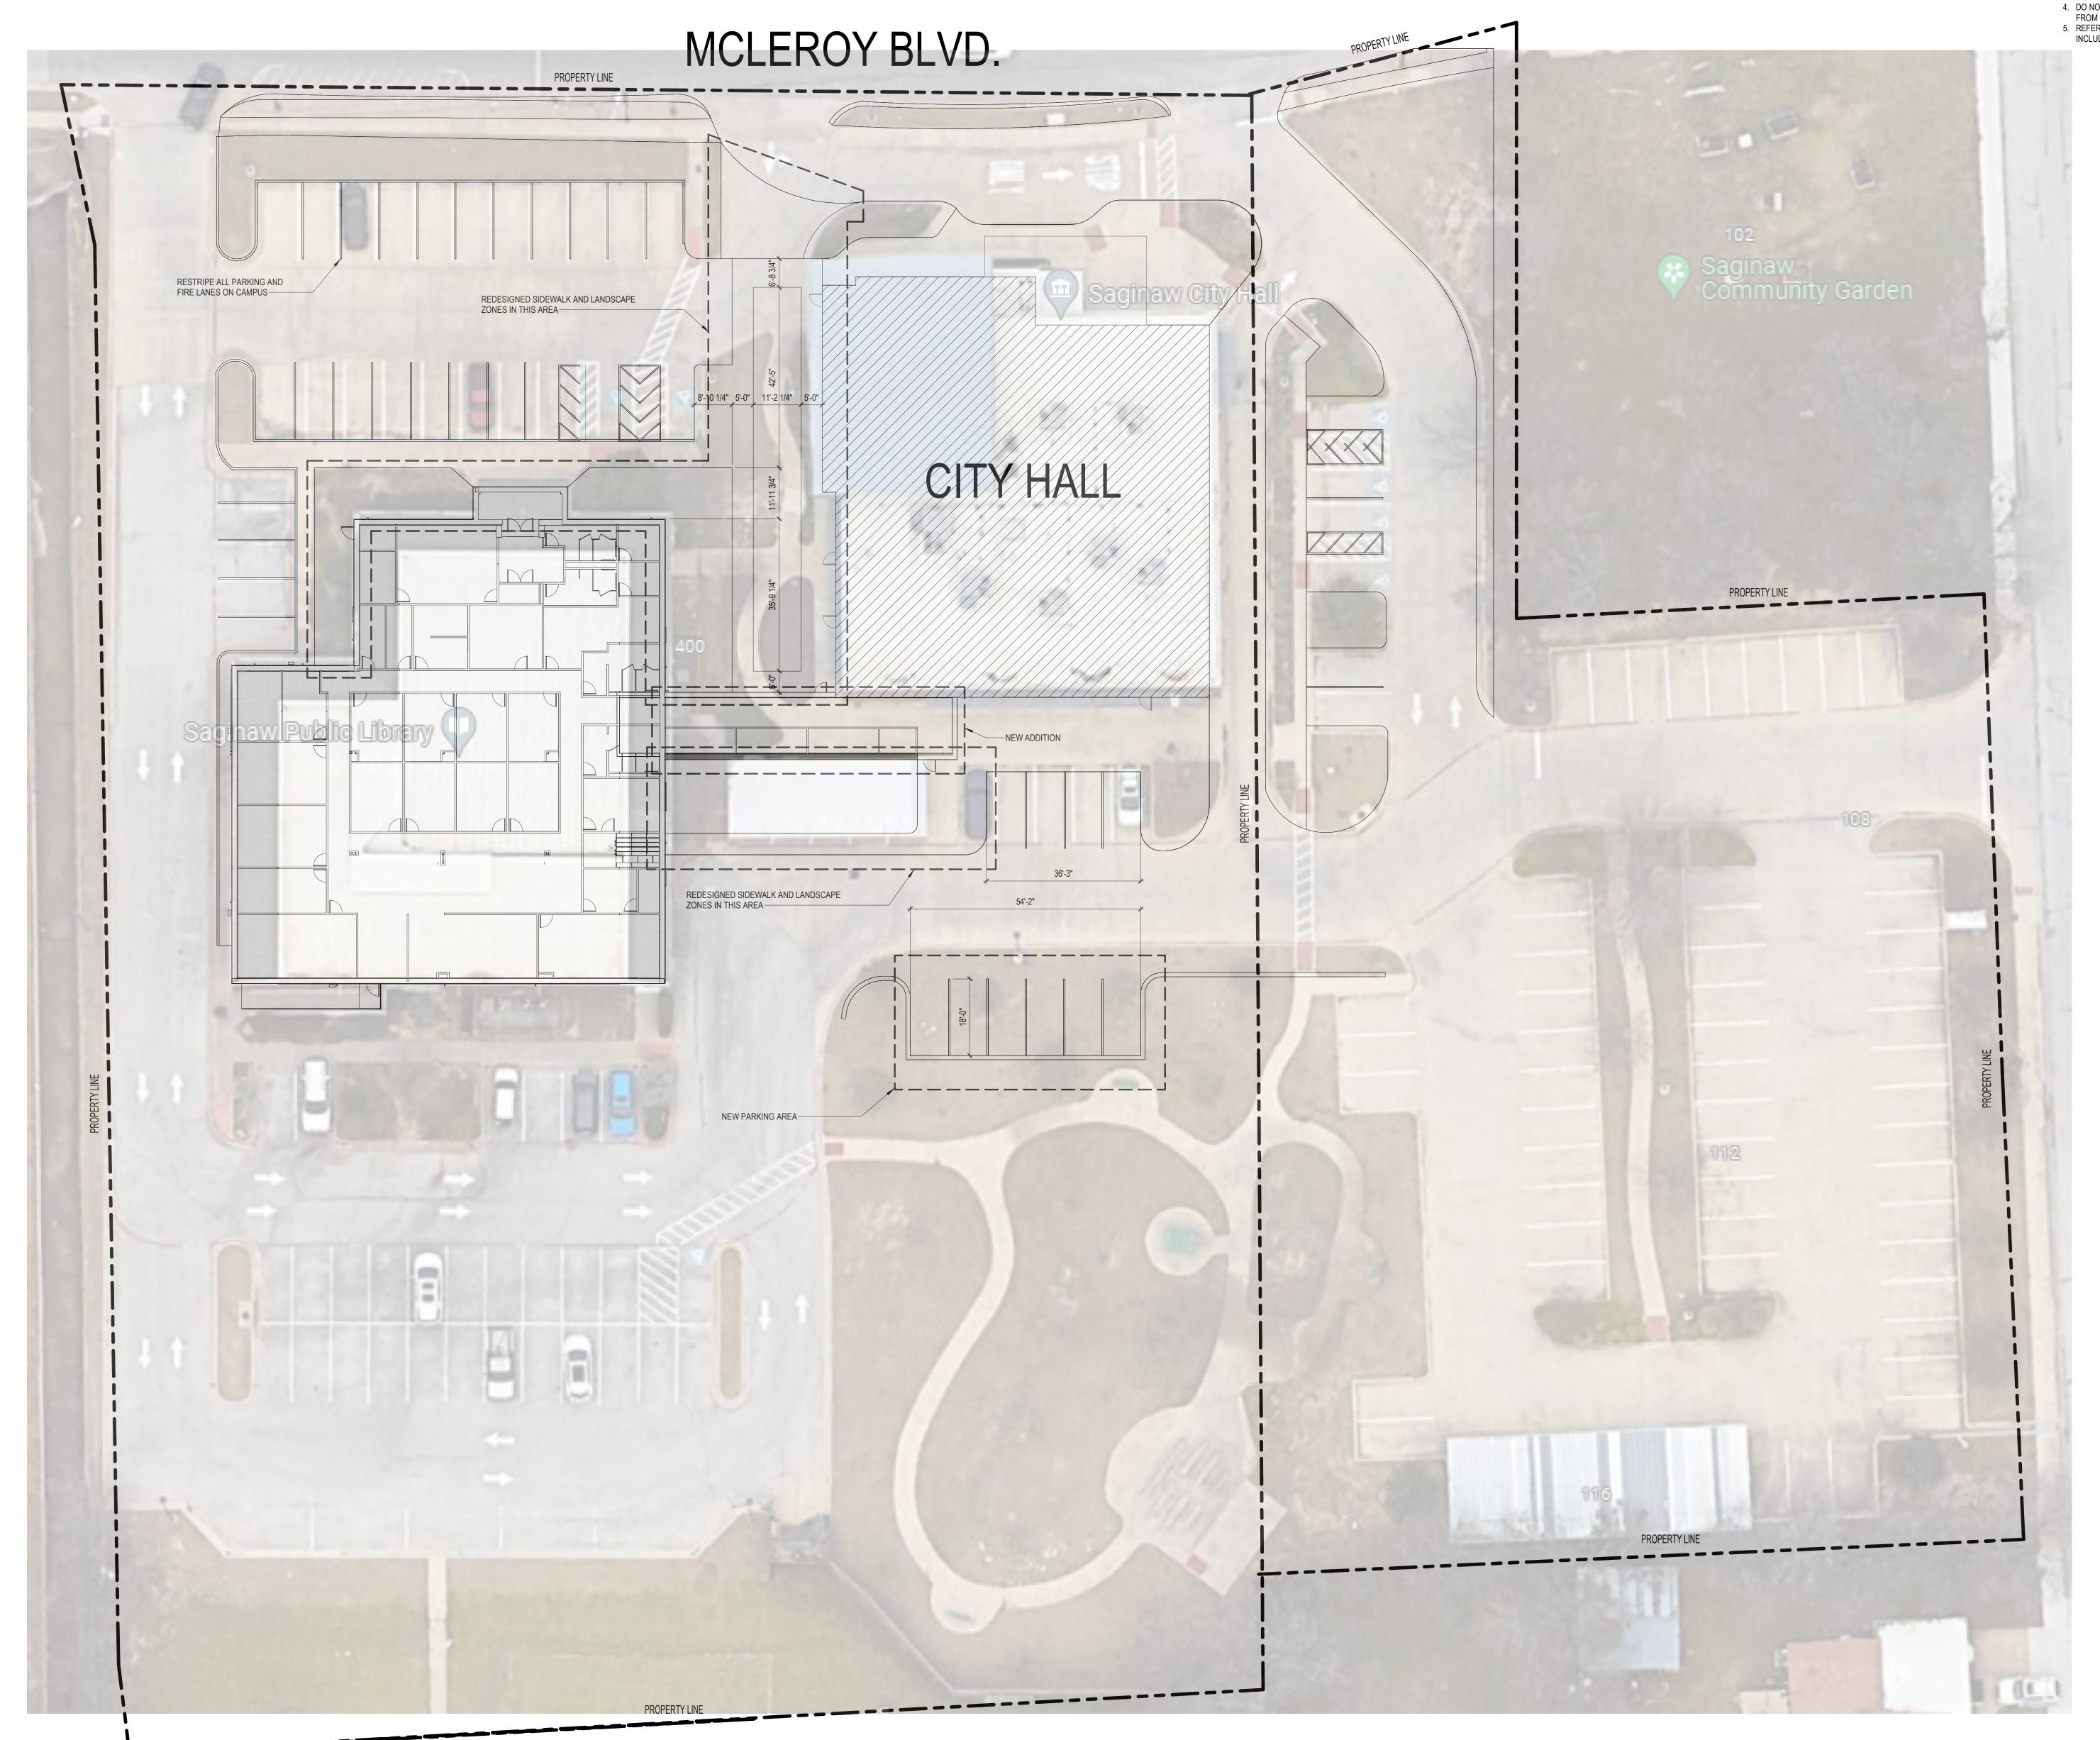

GENERAL PLAN NOTES

- 1. ROOM AND DOOR REFERENCE NUMBERS ARE FOR CONSTRUCTION COORDINATION ONLY. CONTRACTOR SHALL COORDINATE WITH OWNER FOR FINAL ROOM & DOOR
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- 4. ALL 36" WIDE INTERIOR SWING DOORS SHALL BE LOCATED 2'-0" FROM CENTER OF DOOR TO PERPENDICULAR SURFACE OF ADJACENT WALL AT DOOR JAMB U.N.O. 5. CONTRACTOR SHALL FIELD VERIFY ALL EXISTING CONDITIONS PRIOR TO COMMENCING
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- 7. REFER TO WALL TYPE SCHEDULE FOR ADDITIONAL INFORMATION.
- 8. ALL SHAFTS PENETRATING SLAB SHALL BE RATED 2HR. 9. CONTRACTOR SHALL FIELD COORDINATE LOCATION, SIZE AND TYPE OF BLOCKING FOR INSTALLATION OF SIGNAGE, PLUMBING FIXTURES, MILLWORK, ETC. ALL CONCEALED WOOD
- SHALL BE FIRE RETARDANT TREATED (F.R.T). 10. PROVIDE IN-WALL REINFORCEMENT FOR ALL WALL MOUNTED FURNITURE AND EQUIPMENT
- AS REQUIRED. 11. POWERWASH ENTIRE EXTERIOR FACADES.
- 12. POINT EXISTING BRICK AS NEEDED. 13. RECAULK EXTERIOR GLAZING.

PLAN GRAPHICS LEGEND


INDICATES 1/4" PER FOOT SLOPE TO DRAIN AT ROOF INDICATES SCOPE OF WORK TO BE INCLUDED IN THIS PERMIT INDICATES SCOPE OF WORK TO BE INCLUDED IN

FUTURE FIT OUT UNDER SEPARATE PERMIT

KEYNOTE LEGEND

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DESCRIPTION

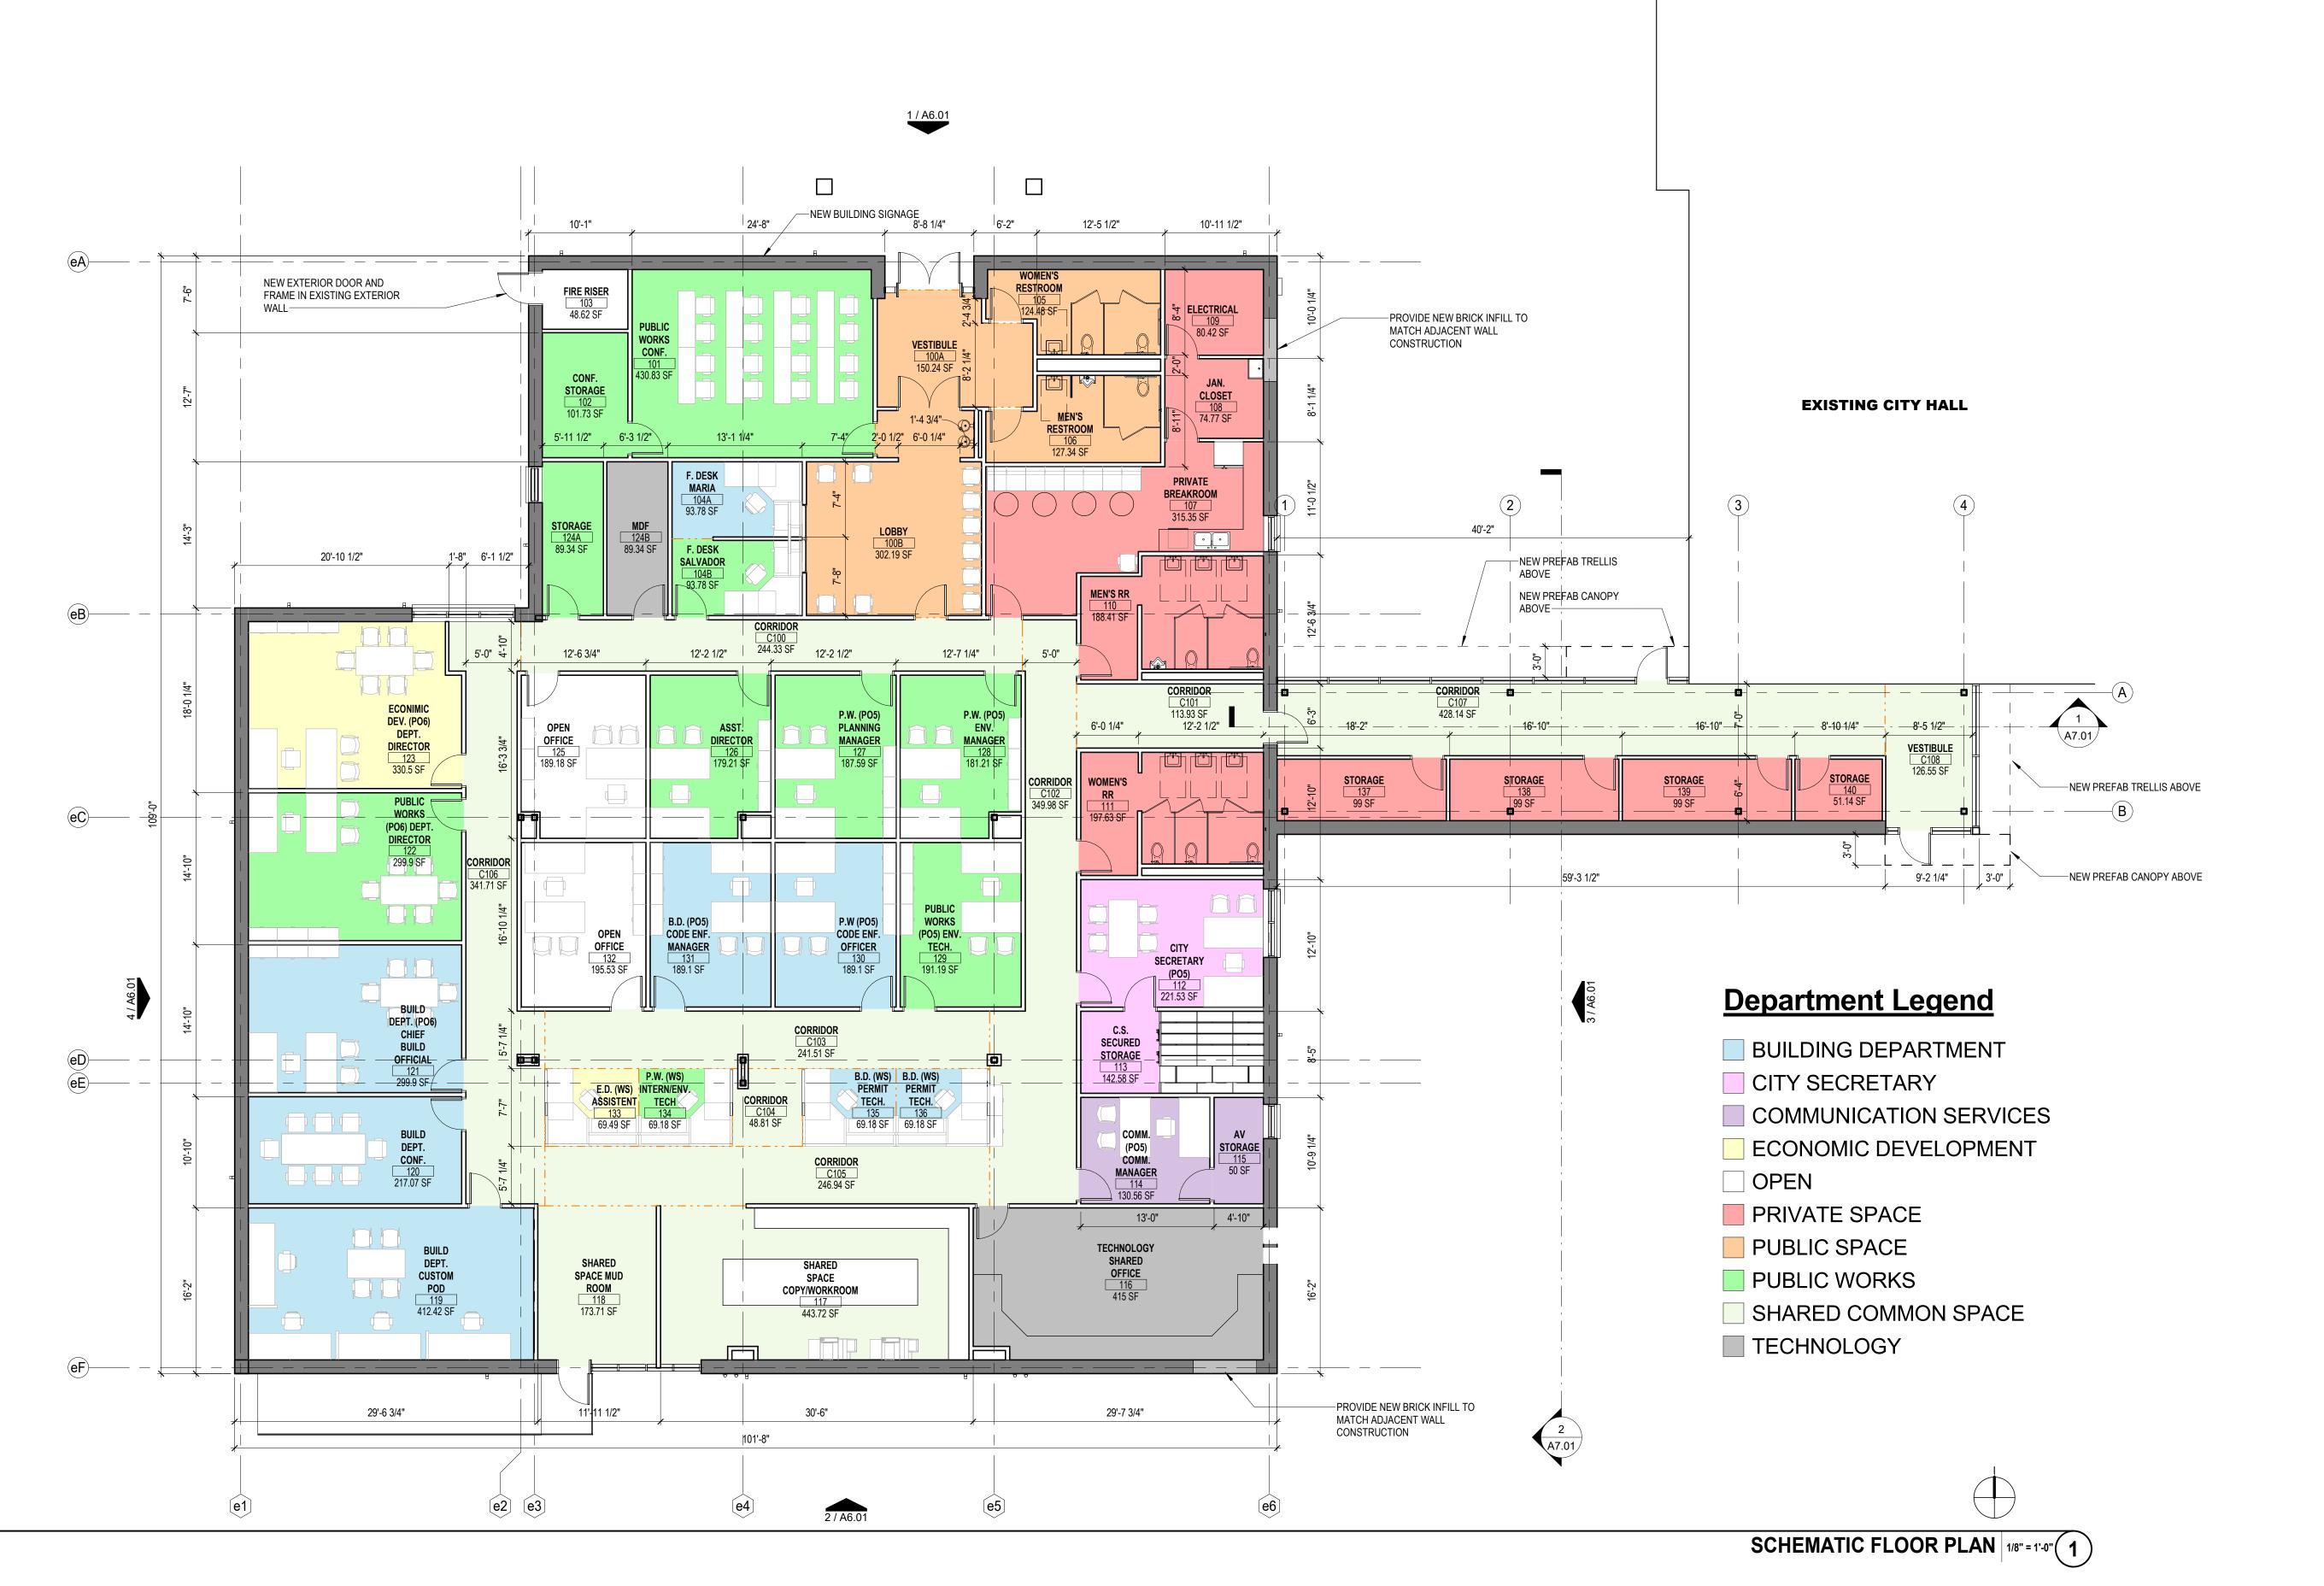

City of Saginaw, Texas

333 West McLeroy Blvd.

Saginaw, TX 76179

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PROJECT LOCATION 355 W McLeroy Blvd. Saginaw,TX 76179

PROJECT NUMBER 1006633.02

SHEET TITLE OVERALL FLOOR PLAN

SHEET NUMBER

A2.10

GENERAL ROOF NOTES

CONFLICTING INFORMATION BEFORE EXECUTION OF WORK.

- 1. CONTRACTOR SHALL FIELD VERIFY ALL EXISTING CONDITIONS PRIOR TO COMMENCING
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- INSTALLATION OF SIGNAGE, PLUMBING FIXTURES, MILLWORK, ETC. ALL CONCEALED WOOD SHALL BE FIRE RETARDANT TREATED (F.R.T).
- 5. ALL SHAFTS PENETRATING SLAB SHALL BE RATED 2HR. 6. ALL FLAT ROOF SLOPES SHALL BE 1/4" PER FOOT U.N.O.
- 7. PROVIDE WALKWAY ROOF PADS TO AND FROM ALL ACCESS POINTS AND AROUND THE PERIMETER OF ALL EQUIPMENT IN ACCORDANCE WITH THE PROJECT SPECIFICATIONS AND ROOF MANUFACTURER SPECIFICATIONS.

ROOF GRAPHICS LEGEND

INDICATES 1/4" PER FOOT SLOPE TO DRAIN AT ROOF OR 2% SLOPE TO DRAIN AT EXTERIOR TERRACE

> NOTE: KEYNOTE NUMBERING IS FOR ORGANIZATIONAL PURPOSES ONLY AND NOT INTENDED TO REFERENCE A SPECIFIC CSI DIVISION

> > DESCRIPTION

PGAL, Inc. 3131 Briarpark Dr.

F 817 232 0311 **ARCHITECT**

Suite 200

Houston, TX 77042 T 713 622 1444 F 713 622 1444 www.pgal.com

City of Saginaw, Texas

333 West McLeroy Blvd.

Saginaw, TX 76179 T 817 232 4640

CLIENT

REGISTRATION

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DRAWING HISTORY

Nº. DATE DESCRIPTION
A 2024/08/23 SCHEMATIC DESIGN

PROJECT NAME SAGINAW KEETER BUILDING RENOVATION


PROJECT LOCATION 355 W McLeroy Blvd. Saginaw,TX 76179

PROJECT NUMBER 1006633.02

SHEET TITLE
OVERALL ROOF
PLAN

SHEET NUMBER

A2.30

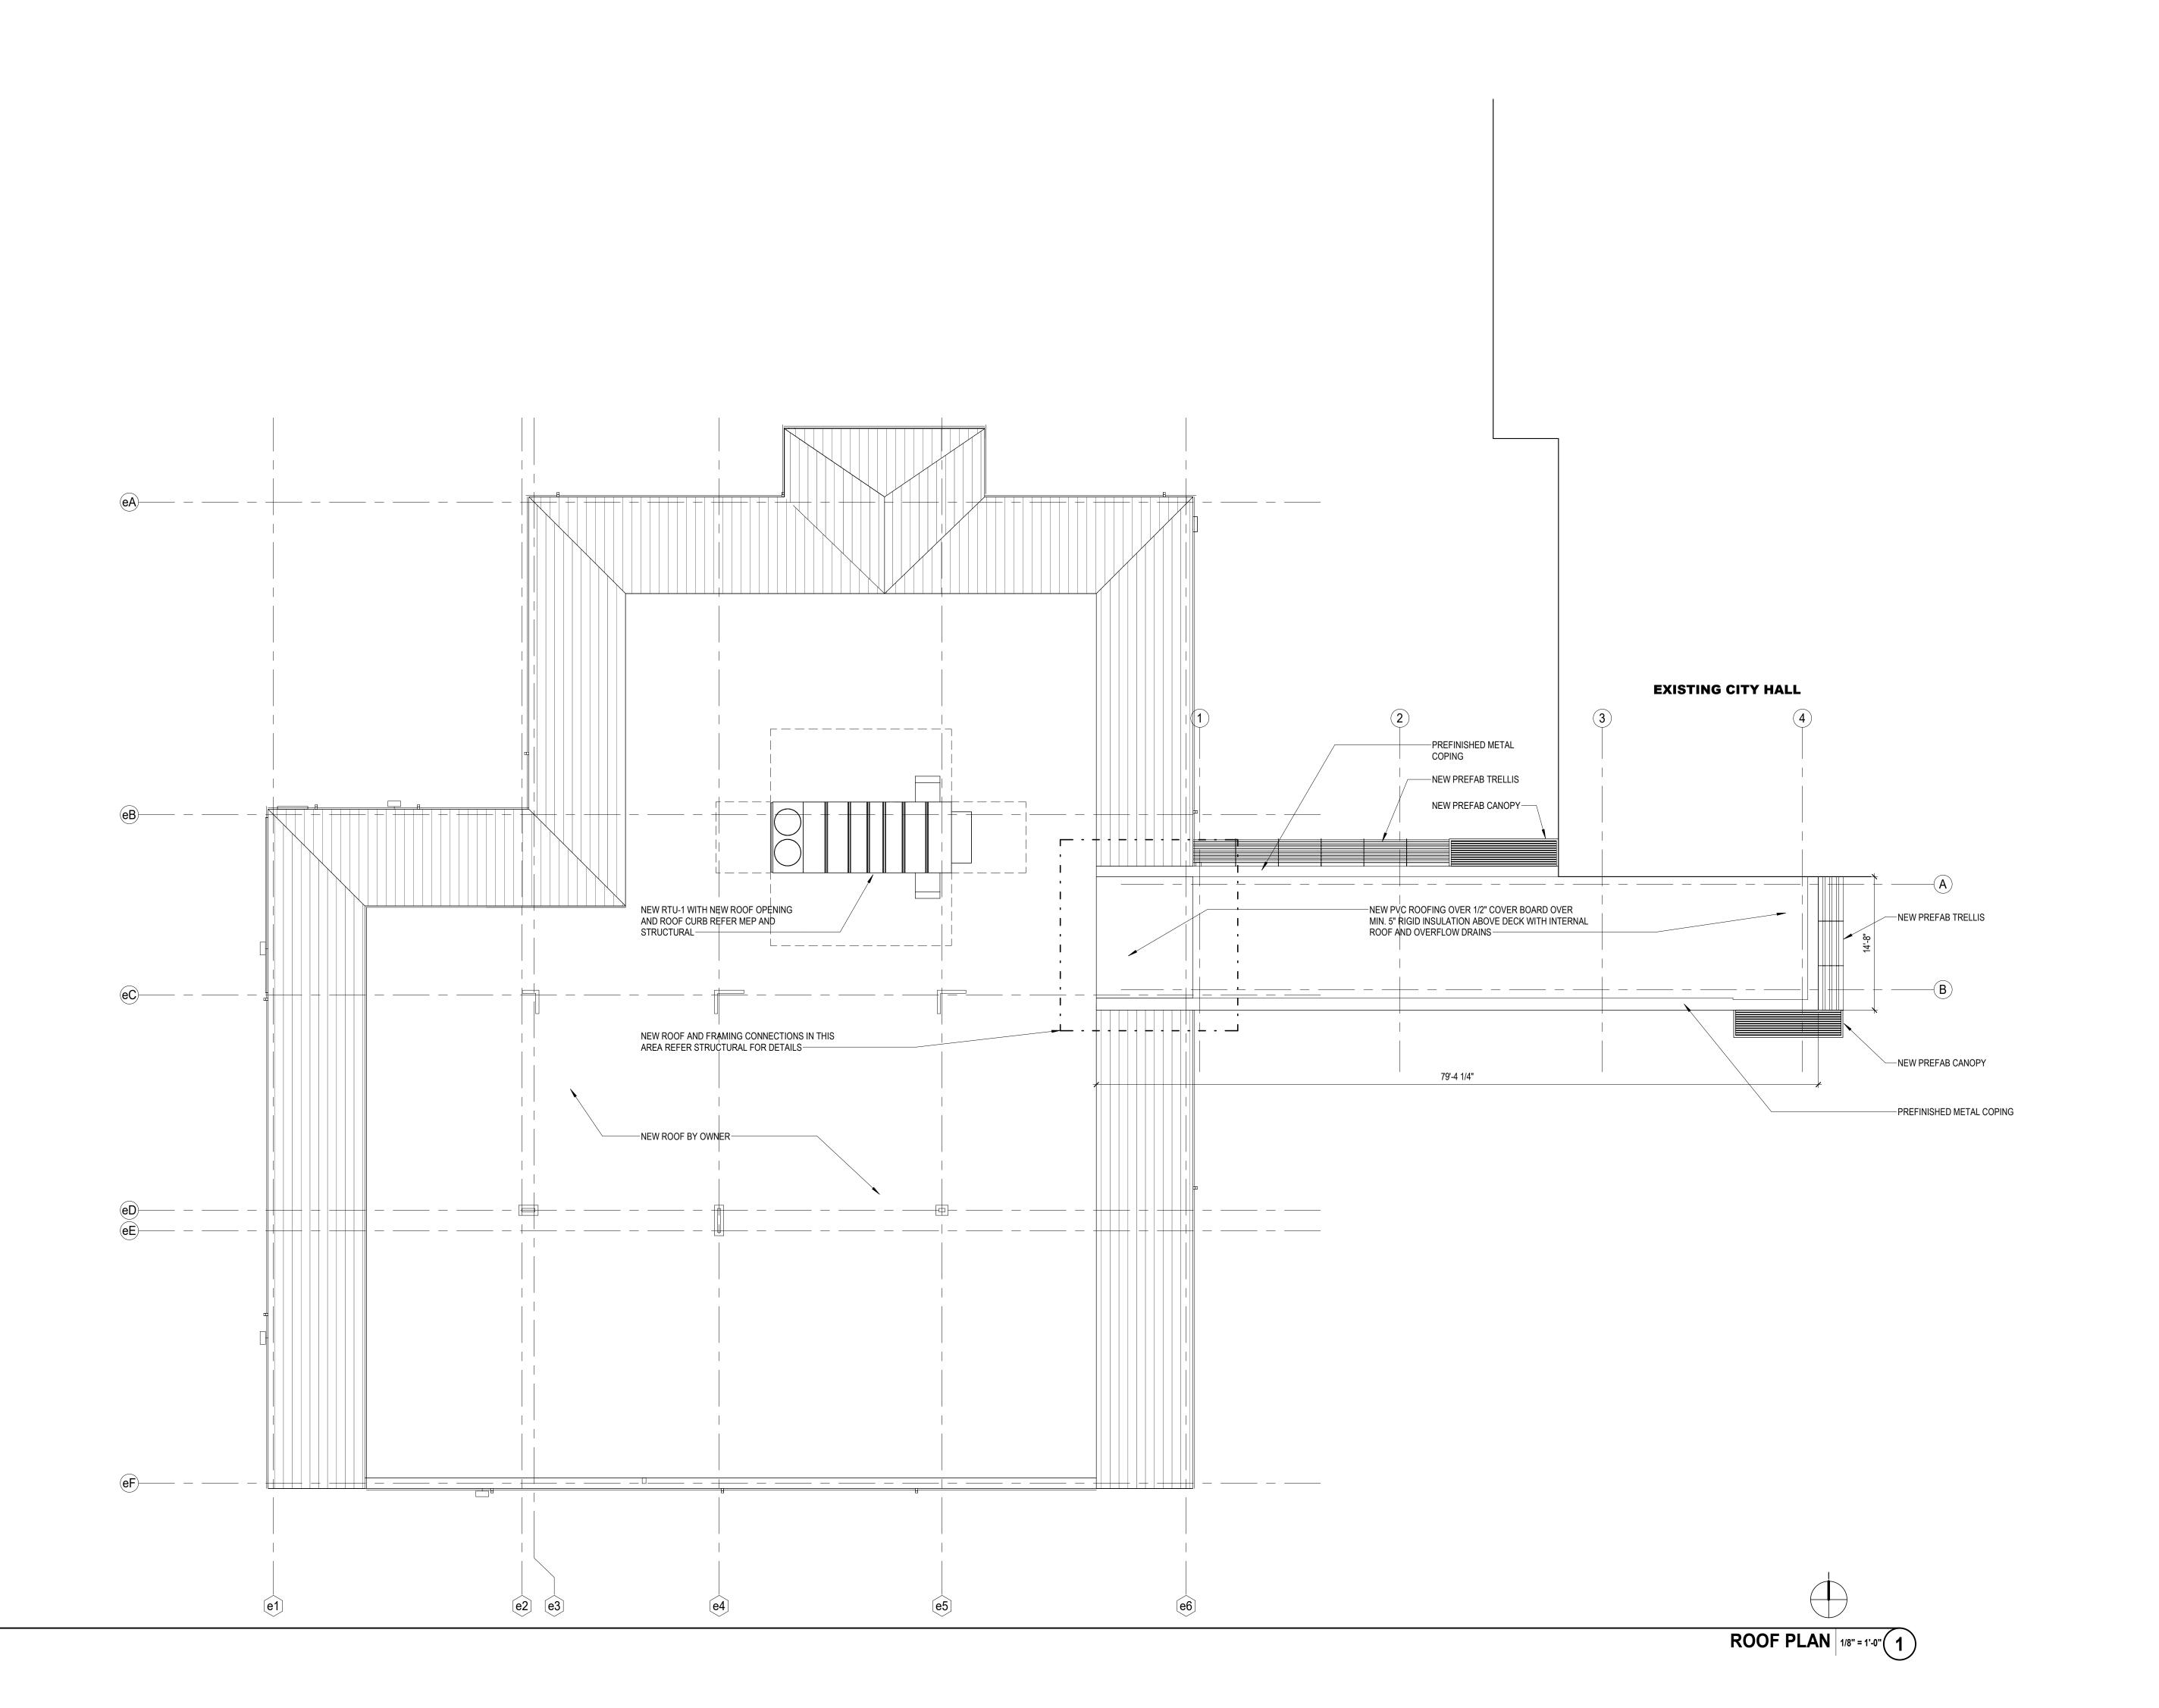


FIRE RISER WOMEN'S RESTROOM ELECTRICAL 109 VESTIBULE 100A PUBLIC WORKS CONF. **EXISTING CITY HALL** CONF. STORAGE PROVIDE NEW FIRE SPRINKLER SYSTEM JAN. CLOSET THROUGHOUT ABOVE CEILINGS. PROVIDE NEW CEILINGS WITH REINSTALLED DEVICES. MEN'S RESTROOM STR-1 PRIVATE BREAKROOM STORAGE 124A ----NEW PREFAB TRELLIS RTU ON ROOF THIS F. DESK SALVADOR LOCATION RE MEP NEW PREFAB CANOPY— ECONIMIC DEV. (PO6) DEPT. DIRECTOR CORRIDOR C101 OPEN OFFICE P.W. (PO5) PLANNING MANAGER P.W. (PO5) ENV. MANAGER ----NEW PREFAB TRELLIS WOMEN'S RR PUBLIC WORKS (PO6) DEPT. DIRECTOR NEW PREFAB CANOPY OPEN OFFICE 132 BD. (PO5) CODE ENF. MANAGER P.W (PO5) CODE ENF. OFFICER PUBLIC WORKS (PO5) ENV. FECH. CITY SECRETARY (PO5) BUILD DEPT. (PO6) CHIEF BUILD C.S. SECURED STORAGE —EXISTING CLERESTORY WINDOWS TO REMAIN— BUILD DEPT. CONF. COMM. (PO5) COMM. MANAGER AV STORAGE BUILD DEPT. CUSTOM POD TECHNOLOGY SHARED OFFICE SHARED SPACE MUD ROOM SHARED SPACE COPY/WORKROOM

GENERAL RCP NOTES

- 1. DO NOT SCALE DIMENSIONS FROM DRAWINGS, ANY UNKNOWN DIMENSION SHALL BE OBTAINED FROM DESIGN PROFESSIONALS VIA REQUEST FOR INFORMATION (RFI).
- 2. CONTRACTOR SHALL FIELD VERIFY ALL EXISTING CONDITIONS PRIOR TO COMMENCING
- 3. CONTRACTOR SHALL NOTIFY THE ARCHITECT OF ANY DISCREPANCY, INACCURACY OR CONFLICTING INFO. PRIOR TO EXECUTION OF THE WORK.
- 4. REFER TO PARTITION INFORMATION FOR ADDITIONAL INFORMATION. 5. ALL SHAFTS PENETRATING SLABS SHALL BE RATED 2HR.
- 6. CEILING HEIGHTS TO BE 10'-0" A.F.F. U.N.O. 7. LIGHT FIXTURES ARE DIMENSIONED TO CENTERLINE OF FIXTURE, OR PROVIDE THE "CL" (CENTERLINE) SYMBOL, AND / OR LINE TYPE ON THE DIMENSION STRING AT EACH
- 8. REFER TO ELECTRICAL DRWGS FOR FIXTURE DESIGNATIONS AND TYPES. 8. FIXTURES SHALL BE CENTERED BETWEEN WALLS U.N.O. 9. CEILING GRIDS SHALL BE CENTERED IN ROOMS U.N.O.

RCP GRAPHIC LEGEND

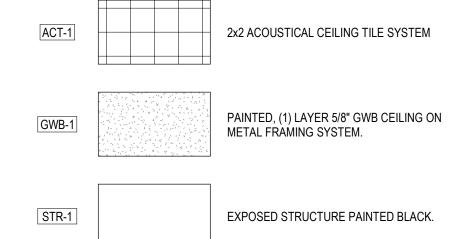

NOTE: KEYNOTE NUMBERING IS FOR ORGANIZATIONAL PURPOSES ONLY AND NOT INTENDED TO REFERENCE A SPECIFIC CSI DIVISION

DESCRIPTION

OVERALL REFLECTED CEILING PLAN 1/8" = 1'-0" 1



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DRAWING HISTORY

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PROJECT NAME SAGINAW KEETER BUILDING RENOVATION


PROJECT LOCATION 355 W McLeroy Blvd. Saginaw,TX 76179

PROJECT NUMBER 1006633.02

SHEET TITLE OVERALL REFLECTED CEILING PLAN

SHEET NUMBER

A3.10

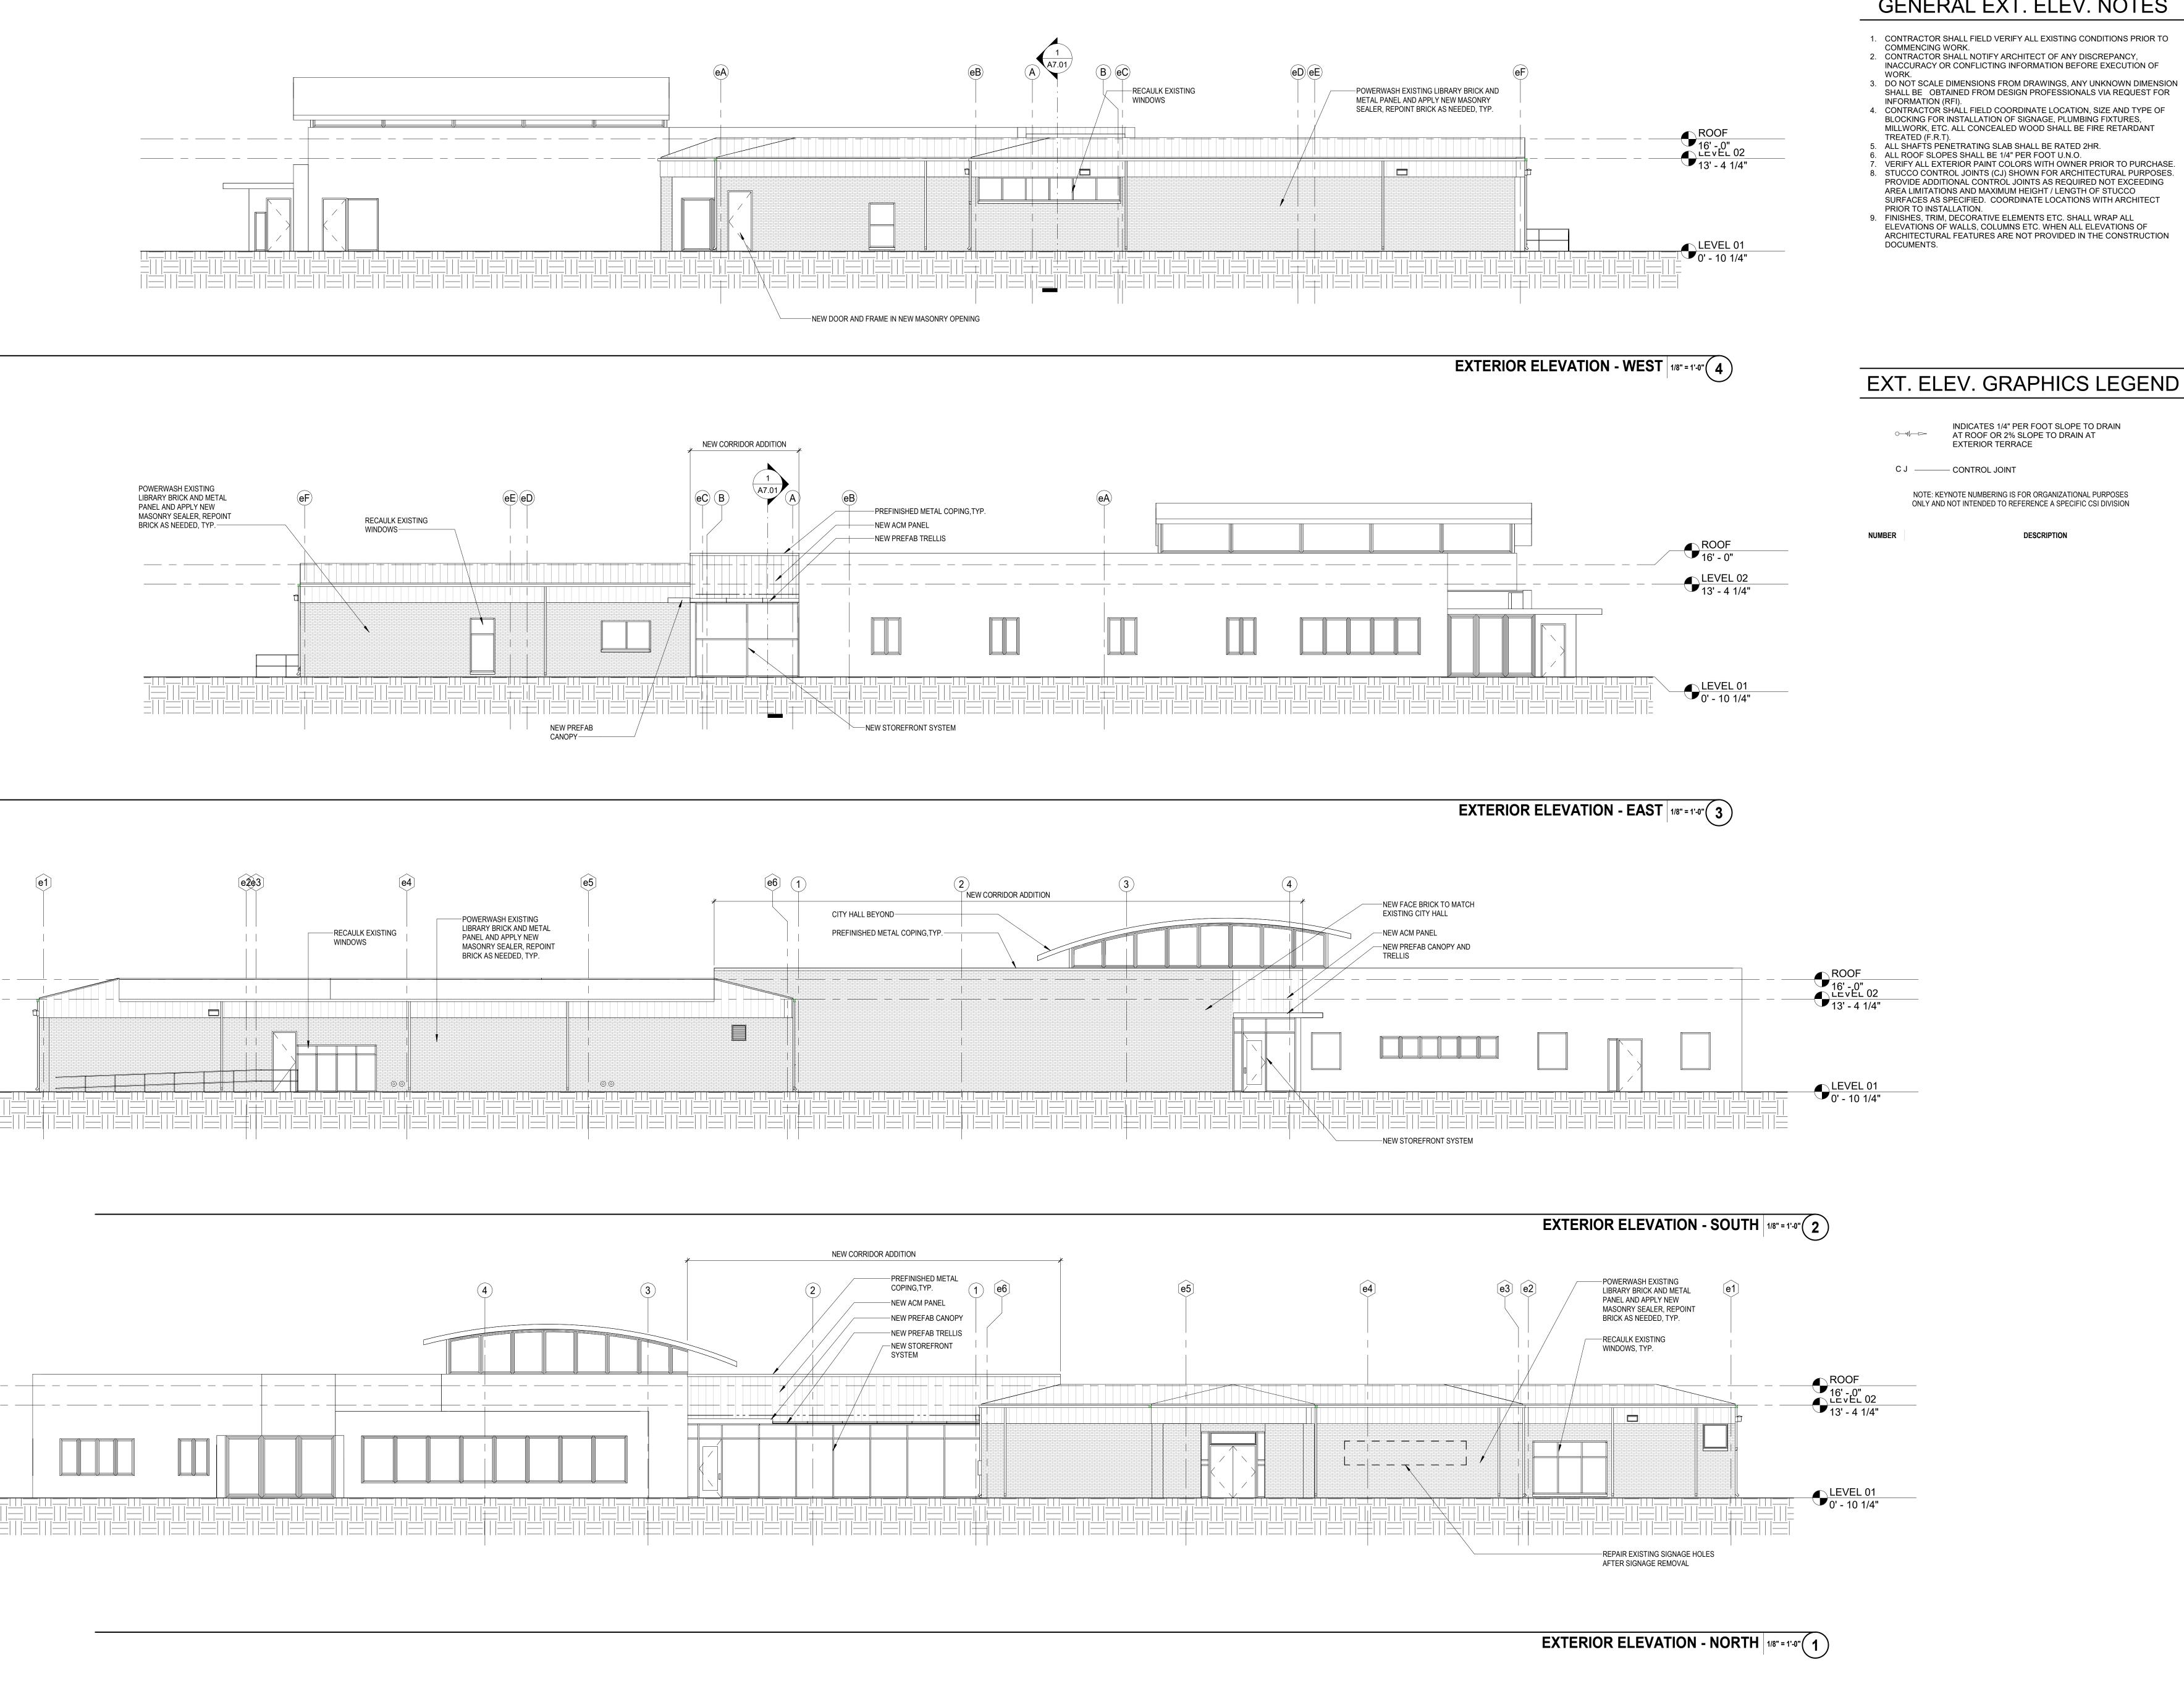

GENERAL EXT. ELEV. NOTES

REGISTRATION

CLIENT

City of Saginaw, Texas

333 West McLeroy Blvd.

Saginaw, TX 76179

T 817 232 4640

F 817 232 0311

PGAL, Inc. 3131 Briarpark Dr.

Houston, TX 77042 T 713 622 1444 F 713 622 1444 www.pgal.com

Suite 200

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DRAWING HISTORY

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 SCHEMATIC DESIGN

PROJECT NAME SAGINAW KEETER BUILDING RENOVATION

PROJECT LOCATION 355 W McLeroy Blvd. Saginaw,TX 76179

PROJECT NUMBER 1006633.02

SHEET TITLE **EXTERIOR** BUILDING ELEVATIONS

SHEET NUMBER

A6.01

GENERAL SECTION NOTES

- 1. CONTRACTOR SHALL FIELD VERIFY ALL EXISTING CONDITIONS PRIOR TO COMMENCING WORK. 2. CONTRACTOR SHALL NOTIFY ARCHITECT OF ANY DISCREPANCY,
- INACCURACY OR CONFLICTING INFORMATION BEFORE EXECUTION OF 3. DO NOT SCALE DIMENSIONS FROM DRAWINGS, ANY UNKNOWN
- DIMENSION SHALL BE OBTAINED FROM DESIGN PROFESSIONALS VIA REQUEST FOR INFORMATION (RFI). 4. CONTRACTOR SHALL FIELD COORDINATE LOCATION, SIZE AND TYPE OF BLOCKING FOR INSTALLATION OF SIGNAGE, PLUMBING FIXTURES, MILLWORK, ETC. ALL CONCEALED WOOD SHALL BE FIRE RETARDANT
- 5. ALL SHAFTS PENETRATING SLABS SHALL BE RATED 2HR.6. ALL ROOF SLOPES SHALL BE 1/4" PER FOOT U.N.O. 7. REFER TO SHEETS A5.01T AND A5.02T FOR TYPICAL ROOF DETAILS.

TREATED (F.R.T).


SECTION GRAPHICS LEGEND

DRAWINGS

NOTE: KEYNOTE NUMBERING IS FOR ORGANIZATIONAL PURPOSES ONLY AND NOT INTENDED TO REFERENCE A SPECIFIC CSI DIVISION

DESCRIPTION

NEW CORRIDOR ADDITION -POWERWASH EXISTING LIBRARY BRICK AND METAL PANEL AND APPLY NEW MASONRY SEALER, REPOINT BRICK AS NEEDED, TYP. eC B -NEW PREFAB TRELLIS -NEW STOREFRONT SYSTEM ROOF 16' - 0" -RECAULK EXISTING WINDOWS, TYP. LEVEL 02 13' - 4 1/4" LEVEL 01 0' - 10 1/4"

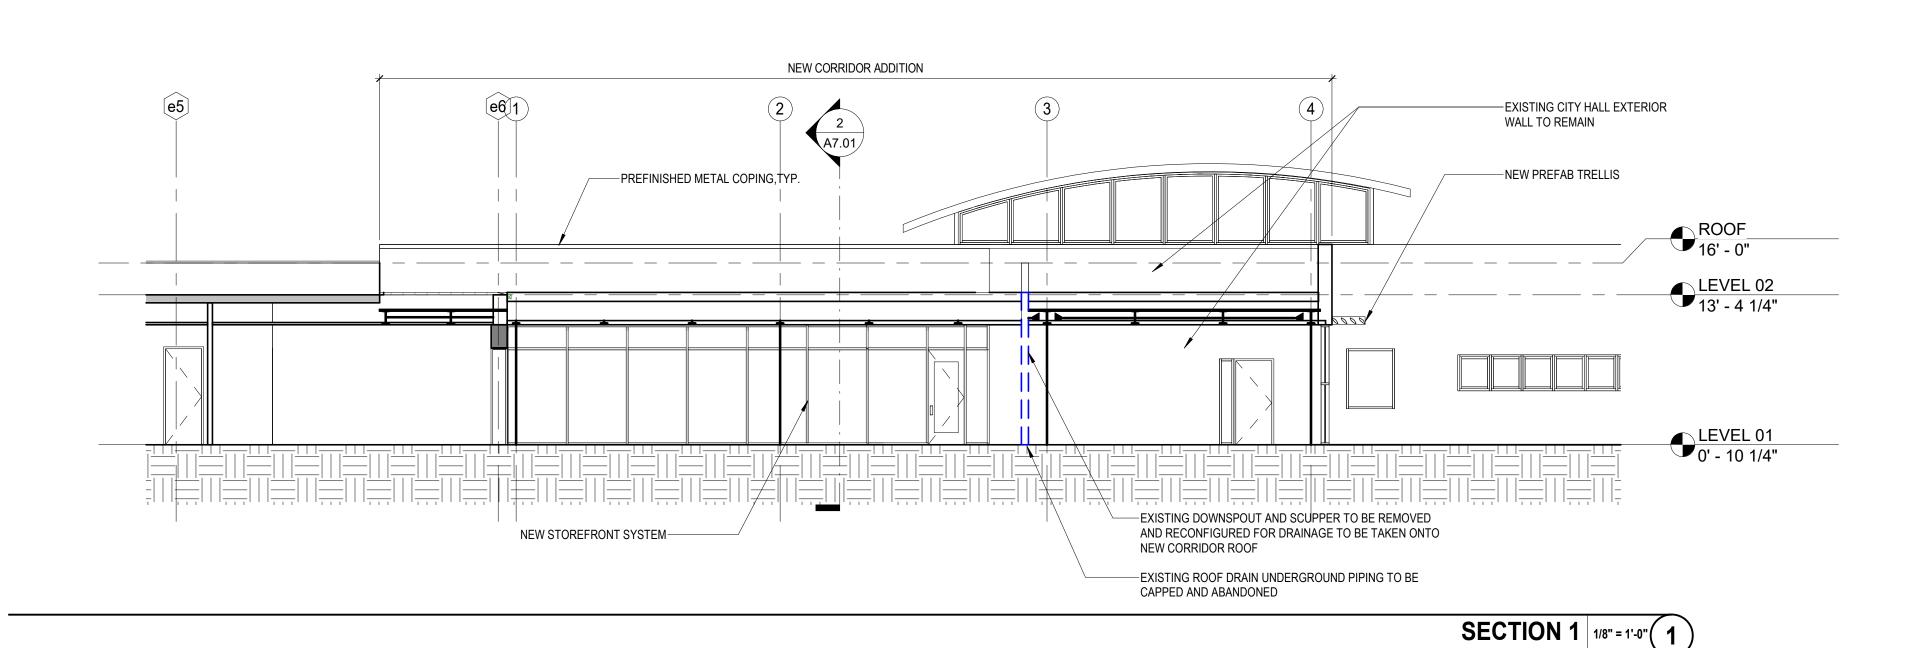

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DRAWING HISTORY Nº. DATE DESCRIPTION
A 2024/08/23 SCHEMATIC DESIGN

PROJECT NAME SAGINAW KEETER BUILDING RENOVATION

PROJECT LOCATION 355 W McLeroy Blvd. Saginaw,TX 76179

PROJECT NUMBER 1006633.02

SHEET TITLE BUILDING SECTIONS

SHEET NUMBER

A7.01



Keeter Bldg. Renovation

31.00548

Schematic Design Narrative

Issue Date: 08/30/2024

Insert photo or rendering here

Client: City of Saginaw, Texas

Architect: PGAL

Engineer: MEPCE, Inc.



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EXECUTIVE SUMMARY

Design Narrative Intent

• The intent of this narrative is to give a description of the Mechanical, Electrical, and Plumbing (MEP) systems that will be used to serve the new renovations and additions to the project. Descriptions of the major renovations to the existing MEP systems in the existing building are also included in this narrative.



Applicable Codes and Standards

- 2021 International Fuel Gas Code (IFGC)
- 2021 International Building Code (IBC)
- 2021 International Mechanical Code (IMC)
- 2021 International Plumbing Code (IPC)
- 2021 International Energy Conservation Code (IECC)
- 2021 International Fire Code (IFC)
- 2020 National Electrical Code (NEC)
- Electrical Industries Association (EIA-242-D, EIA-485)
- ANSI/TIA-568-C.1: Commercial Building Telecommunications Cabling Standard, Part 1
- ANSI/TIA-568-C.2-1: Commercial Building Telecommunications Cabling Standard, Part 2: Balanced Twisted-Pair
- ANSI/TIA-568-C.3: Commercial Building Telecommunications Cabling Standard, Part 3: Optical Fiber Cabling
- ANSI/TIA-455-A: Standard Test Procedures for Fiber Optic Cables
- ANSI/CEA S83-596: Fiber Optic Premises Distribution Cable
- ANSI/TIA-526-7: Optical Power Loss Measurements of Installed Single Mode Fiber Cable Plant- OFSTP-7
- ANSI/TIA-526-14-A: Optical Power Loss Measurements of Installed Multi Mode Fiber Cable Plant- OFSTP-14A
- ANSI/TIA-569-A: Commercial Building Standards for Telecommunications Pathways and Spaces
- ANSI/TIA-606: The Administration Standard for the Telecommunications Infrastructure of Commercial Buildings
- ANSI/TIA-607: Commercial Building Grounding and Bonding Requirements for Telecommunications
- TIA/EIA 758: Customer-Outside Plant Telecommunications Cabling Standard



FIRE SUPPRESSION SCOPE NARRATIVE

Design Criteria

- Applicable Codes and Standards
 - o Refer to Executive Summary section for applicable codes and standards

Existing Conditions

• The existing Library and City Hall currently do not have a fire suppression system.

Fire Suppression Site Utility Estimates

 MEPCE has developed preliminary fire suppression service utility estimates for the new hospital. The load analysis is based on building height, quantities of stairwell standpipes, NFPA 20 requirements, and historical experience with similarly occupied structures. This information is preliminary and will be developed further as the design progresses.
 Further development of the piping routing will occur as the building floorplan design progresses.

			Pipe Size
Building	Utility	Demand	(in)
Library and City Hall	Fire Suppression	500 GPM	6

- Both buildings will be provided with a single 6-inch fire suppression water line routed into the new fire riser room. All standpipes will be Class I, combination automatic wet type/riser system. All systems will comply with NFPA 13, 14, 20, and 24. The building will be protected throughout by wet pipe automatic sprinkler with floor control valves connected to the combination standpipes at all levels. The building will be predominantly light hazard.
- The contractor will need to provide a hydrant flow test taken with a year for all hydraulic calculations.
- For IT/MDF/IDF rooms, a pre-action sprinkler system shall be installed. It shall consist of
 a double interlocking system that is activated upon a signal from the fire alarm when a
 detection device is activated and the sprinkler opens simultaneously. The systems shall
 comply with NFPA 13.

Outline Specifications



21 05 00 Common Work Results for Fire Suppression21 10 00 Water-Based Fire-Suppression Systems

- This section specifies various components for water-based fire suppression systems. Included are piping, hangers, sprinklers, valves and alarm bells. Fire sprinkler piping will be schedule 40 and schedule 10 steel pipe.
- Required submittals will include calculations, product data, shop drawings, and approval from the local Authority Having Jurisdiction (AHJ).



PLUMBING SCOPE NARRATIVE

Design Criteria

- Applicable Codes and Standards
 - o Refer to Executive Summary section for applicable codes and standards

Existing Conditions

• The existing library's domestic water line size is unidentified on existing as-built drawings and will need further investigation. There is no domestic water backflow preventer protecting the domestic water line connection to the city. The sanitary sewer line is assumed to be a 4 " sanitary sewer line until this can be confirmed through accurate record drawings. The natural gas line is approximately a 1" line at an unknown pressure. The storm drain system is currently gutters and downspouts around the perimeter of the building.

Domestic Water System

- The existing domestic water and natural gas system will be rerouted from the northwest corner of
 the facility to the new riser room located in the northwest corner of the building. The domestic
 water line will have a new reduced pressure backflow preventer installed.
- The new domestic water line into the building will be 2 ½".
- A new 100" gallon, 120 MBH natural gas water heater will store water at 140 degrees F with a thermostatic mixing valve used to deliver hot water at 120 degrees F.
- A recirculating domestic hot water system will be utilized. The domestic hot water main will be a approximately 1 ½" in diameter.
- Lavatories will utilize ASSE 1070 thermostatic mixing valves to temper water from 120 degrees F to 110 degrees F.

Plumbing Fixtures

• All existing plumbing fixtures will be replaced. All new plumbing fixtures will be hard-wired sensor type fixtures. Estimated flow rates are as follows:

Water Closets: 1.28 gallons per flush (GPF)

Urinals: 0.125 GPF

Lavatories: 0.5 gallons per minute (GPM)

Showers: 1.5 gallons per minute (GPM)



Other Sinks: 1.5 gallons per minute (GPM)

Sanitary Sewer System

New sanitary sewer piping will tie into the existing sanitary sewer outside of the building.

Storm Drain System

• The storm drain system will remain gutters and downspouts. No new storm drains are anticipated.

Natural Gas System

• The gas meter and natural gas main to the building will be rerouted around the north end of the building to the new riser room. The size will remain 1 ½". The gas meter will be replaced and a new gas regulator will be installed to maintain a minimum of 2 psig. A new 1" natural gas line will be installed downstream of the new gas regulator to the new mechanical equipment and water heater.

Outline Specifications

22 05 00	Common Work Results for Plumbing
22 05 16	Expansion Fittings and Loops for Plumbing Piping
22 05 19	Thermometers and Gages for Plumbing Piping
 Requ 	ired submittals will include product data.

- 22 05 23 General-Duty Valves for Plumbing Piping
 - This section specifies various valves used for plumbing piping for shut-off duty, throttling duty and drain valves. It does not include stop valves for plumbing fixtures. Valves for this project will include the following:
 - For domestic water shut-off: two piece, copper alloy ball valves with full port, chrome plated bronze ball with PTFE seats.
 - For flow direction control: Type 2, class 125 bronze check valves with non-metallic disc and bronze seat.
 - Required submittals will include product data for all valve types.
- 22 05 29 Hangers and Supports for Plumbing Piping and Equipment
 - Required submittals will include product data and application.
- 22 05 53 Identification for Plumbing Piping and Equipment



- This section specifies labels for piping, equipment and valves. In addition, it specifies the color code used to identify warning signs and various fluids in the plumbing system. All equipment will have metal labels. Labels should include the following:
 - o Drawing designation or unique equipment number
 - o Drawing numbers where equipment is identified on plans, details and schedules
 - Specification section number and title where equipment is specified
 - o Equipment manufacturer
 - Equipment model number
 - o Equipment serial number
 - Voltage
 - MCA
 - o GPM
- Date of manufacture
- Required submittals will be product data, samples, equipment label schedule, valve numbering scheme, and valve schedule.

22 07 00 Plumbing Insulation

- This section specifies the various insulations used for domestic water piping and jacketing required. Allowable insulation materials will be as follows:
 - o Domestic Cold water:
 - o Flexible Elastomeric, ½" thick minimum
 - o Domestic Hot water:
 - o Flexible elastomeric ½" thick minimum
 - o Mineral-fiber, preformed, type I, 1" thick minimum
 - Condensate and equipment drain piping:
 - o Flexible elastomeric 3/4" thick minimum
 - o Drawing numbers where equipment is identified on plans, details and schedules
 - o Required submittals will include product data.

22 11 16 Domestic Water Piping

- This section specifies the piping, fittings, and support spacing used for domestic, potable water for the project. Pipe types allowed for this project will be soft copper tube, types K and L, and hard copper tube, types L and M.
- Required submittals will be product data and shop drawings.
- 22 11 19 Domestic Water Piping Specialties
- 22 11 24 Facility Natural Gas Piping
 - This section specifies the piping, fittings and support spacing used for natural gas piping within the building. Pipe type allowed for this project will be steel piping with welded fittings.
 - Required submittals will include product data and shop drawings.
- 22 13 16 Sanitary Waste and Vent Piping



- This section specifies the waste and vent piping used for the project, within the building, both above and below grade. This includes piping, fittings and supports. Pipe types allowed for this project will be the following:
 - Service class cast iron soil pipe and fittings, gaskets, and gasketed joints
 - o Hubless cast iron soil pipe and fittings
 - Steel pipe, drainage fittings and threaded joints
 - o Stainless steel pipe and fittings, gaskets and gasketed joints
 - Solid-wall PVC pipe, PVC socket fittings, and solvent-cemented joints (not for use in return air plenums
 - o Required submittals will be product data and shop drawings.

22 13 19 Sanitary Waste Piping Specialties

22 34 00 Fuel-Fired Domestic Water Heaters

- Domestic water heaters will be commercial type, vertical storage tank, small footprint, fire tube, condensing water heater, 96% efficient minimum, with 299,000 BTU/hr input and 100 gallon capacity. Water heaters will be PVI Conquest -299 or approved equal. Water heaters will come with a 15 year factory warranty.
- Required submittals will be product data and shop drawings.

22 40 00 Plumbing Fixtures

- Fixture types will be as follows:
 - Water closets wall hung, sensor-operated flush valves, 1.28 gallon per flush maximum, 1000 MaP rating, white, vitreous china. Both standard and TAS accessible heights.
 - Lavatories undermount, sensor-operated faucets, 0.5 gallon per minute maximum flow, white, vitreous china. TAS accessible.
 - Urinals wall-hung, sensor-operated flush valves, 0.125 gallon per flush maximum, white, vitreous china. Both standard and TAS accessible heights.
 - Breakroom sinks single- or double- compartment, TAS accessible, countertop, stainless steel with single, lever handle and pull-out sprayer. 1.0 gpm maximum flow.
 - Showers TAS accessible and standard. Shower valves will be pressure-balancing type. 1.5 gpm maximum flow.
 - o Commercial kitchen plumbing fixtures will be specified by the kitchen equipment supplier, but will be water-saving type to comply with LEED requirements.
 - Sensor operated fixtures will be either hard-wired or battery-powered, but only if a regenerative battery option is provided (such as the EcoPower option by Toto, in which a turbine recharges the battery)
- Required submittals will be product data.

22 47 00 Drinking Fountains and Water Coolers



- Water coolers will be wall-hung, bi-level, TAS accessible, vandal-resistant, stainless steel with bottle fillers.
- Required submittals will be product data.



HVAC SCOPE NARRATIVE

Design Criteria

- Indoor Design Conditions
 - Cooling: 75.0°F Dry-Bulb / 60.0°F Dew-Point (approx. 50% RH)
 - o Heating: 70.0°F Dry-Bulb
- Outdoor Design Conditions
 - Cooling: 101.6°F Dry-Bulb / 74.0°F Wet-Bulb
 - Heating: 22.6°F Dry-Bulb

Existing Conditions

The facility is currently served by seven (7) split-system air-conditioning units. Six (6) systems provide 5-ton (nominal) cooling capacity and the remaining system adds 4-ton more for a total of 34-ton.

Mechanical Load Estimate

MEPCE has developed a preliminary HVAC load estimate for the project. The load analysis is based on climatic design conditions according to World Meteorological Organization (WMO) station 747390, "Ft. Worth Meacham, TX, USA," and Climate Zone 2A. Building assemblies are assumed to meet 2021 IECC minimum thermal envelope requirments.

HVAC System

Option 1:

The primary HVAC system will be configured as Multiple-Zone (MZ) Variable-Air-Volume (VAV) using packaged, rooftop air-conditioning units (RTU) and single-duct, VAV air terminal units (ATU). The estimated nominal cooling capacity required for the facility is 30-ton. (See attached roof plan) Heating will not be provided at the RTU; instead, the ATUs will include electric-resistance heating coils as required. (See attached zoning plan)

The basis-of-design RTU will be a Carrier 50V series unit and include the following components, options, and accessories:

- Air-Side Economizer
 - o Differential enthalpy with fixed dry-bulb temperature
 - Low-leakage dampers
 - Outdoor air flow measurment for ventilation control
- Relief Fan
 - o 2-stage (minimum), low-static air flow control
 - Barometric dampers
- Air Filtration



- o 2" thick, pleated, panel filter rack
- o Minimum MERV-11 filtration accomodations
- Cooling
 - High-efficiency direct-expansion (DX) refrigerant system
 - Modulating capacity control
 - Variable-speed condenser fans
 - o Condenser hail and vandal guards
- Supply Fan
 - o Factory-mounted variable-speed drive
 - Shaft grounding system
- Roof Curb
 - o Manufacturer's standard, insulated 1'-2" tall curb
 - Acoustic attenuation fill material
- Controls
 - o Stand-alone, manufacturer furnished equipment controller
 - Optimized startup
 - Supply air temperature control with temperature reset
 - Duct-mounted supply air static pressure VAV fan control
 - Demand control ventilation only as needed (if applicable)
- Safeties
 - o Return air smoke detection
 - Condensate overflow
 - o Filter status (differential pressure switch)
 - Economizer fault detection and diagnosites
 - Supply air high-static pressure

The basis-of-design ATUs will be Price SDV units and include the following components, options, and accessories:

- Air flow measurement sensor
- Motorized damper
- Controls
 - o Stand-alone, manufacturer furnished equipment controller
 - Manufacturer furnished space-mounted sensor
- Electric Reheat
 - o Modulating capacity control

Option 2:

The existing split-system air-conditioning units will be replaced with new, comparable equipment. The basis-of-design split-systems will be Carrier Infinity Series condensing units, evaporators (cooling coils), and gas-fired furnaces and include the following components, options, and accessories:

- Air-Side Economizer Kit
- Air Filtration
 - o 2" thick, pleated, panel filter rack



- o Minimum MERV-11 filtration accomodations
- Oudoor Condensing Unit
 - Staged capacity control
- Indoor Evaporator Coil
- Gas-Fired Furnace
 - o High efficiency, condensing furnace
- Supply Fan
 - o Multiple-speed, direct-drive motor
- Controls
 - o Stand-alone, manufacturer furnished thermostatic controller
- Safeties
 - o Condensate overflow
 - o Filter status (differential pressure switch)
 - o Economizer fault detection and diagnositcs

Both Options:

- Ductless Split-System Air-Conditioning Units Electrical and Data/Communications Rooms
 - Carrier Infinity Series High Wall Indoor Unit (Basis-of-Design)
 - o Cooling only
- Concealed, Ducted Split-System Air-Conditions Unit New Connector Addition
 - o Carrier Performance Series Ducted Indoor Unit (Basis-of-Design)
 - Heat pump
- Electric Unit Heaters Fire Riser Room
 - Q-Mark MUH Series (Basis-of-Design)

Air Distribution System

- Supply Air
 - Externally wrapped sheet metal ductwork
 - o Constructed according to current SMACNA Standards
 - o Insulated per 2021 IECC requirements
- Return Air
 - o Open plenum, above ceiling return
 - o Internally-line, transfer-air ducts where plenum is separated with partitions
- Exhaust Air
 - Uninsulated sheet metal ductwork
 - Constructed according to current SMACNA Standards

Ventilation and Exhaust



Outdoor (fresh air) will be supplied, according to 2021 IMC ventilation rate procedure, to each zone with the conditioned air. Outdoor air will be supplied continuously during occupied hours of building operation.

Demand controlled ventilation (DCV) will be provided for spaces larger than 500 square feet and with an average occupant load of 15 people or greater per 1,000 square feet of floor area. Additional criteria and exceptions may be found in 2021 IECC.

Restrooms will be exhausted at a rate of 75 cfm per fixture (water closet or urinal). Exhaust will be continuous during occupied hours of building operation. The basis-of-design exhaust air fans will be Loren Cook ACED roof-mounted, downblast, direct-drive fans with speed controller for balancing.

Outline Specifications

23 05 13	Common Motor Requirements for HVAC Equipment
23 05 17	Sleeves and Sleeve Seals for HVAC Piping
23 05 29	Hangers & Supports for HVAC
23 05 48	Vibration and Seismic Controls for HVAC
23 05 53	Identification for HVAC
23 05 93	Testing, Adjusting, and Balancing for HVAC
23 07 00	HVAC Insulation
23 11 23	Facility Natural-Gas Piping
23 23 00	Refrigerant Piping
23 31 13	Metal Ducts
23 33 00	Air Duct Accessories
23 34 23	HVAC Power Ventilators
23 36 00	Air Terminal Units
23 37 13	Diffusers, Registers, and Grilles
23 41 00	Particulate Air Filtration
23 74 16	Packaged, Rooftop Air-Conditioning Units (Option 1)
23 81 26	Split-Sytem Air-Conditioners
23 82 39	Unit Heaters



ELECTRICAL SCOPE NARRATIVE

Design Criteria

- Applicable Codes and Standards
 - o Refer to Executive Summary section for applicable codes and standards

Existing Conditions

• The existing electrical service is 120/240v, 1ph, 3W. Service entrance feeders are provided by a pole mounted utility transformer and run underground to the building's main service entrance meter and disconnect switch. A feeder is fed from the main disconnect switch to the main distribution panel. The distribution panel serves additional panels downstream to serve the building's electrical distribution system. Based on the proposed renovation portions of the existing electrical distribution system will need to be demolished and replaced with new.

Electrical Load Estimates

• The total square footage of the renovated space is approximately 10,000 square foot (sqft). Based on an estimated 8 Watts/sqft the electrical service needed to serve the space is 100kVA (416 amperes). As the drawings develop a comprehensive electrical load analysis will be developed to determine the exact loads needed to service the building including, lighting, power, HVAC and equipment loads. Load calculations will be based on the NEC 2023 edition. Power density calculations for lighting will be included using Comcheck. Energy calculations will be performed in accordance with the local energy codes and will ensure the building complies with an energy efficiency design.

Main Electrical Service

- The current utility provider for the building is ONCOR.
- Based on the load information above, MEPCE proposes to reuse the existing electrical service size, including the service feeders and meter. If the electrical service needs to be upgraded or modified, MEPCE will coordinate with the utility provider while notifying other disciplines of the impact.



Electrical Distribution equipment

 A new distribution panel and branch panels will he located in the main electrical room to serve the building's electrical distribution system. Owner may elect to salvage the existing electrical equipment for reuse in the building, however some equipment appears be past its useful life. MEPCE will further evaluate the condition of the equipment and provide recommendations for reuse of existing equipment.

Emergency and Standby Power Systems

• A centralized Battery inverter will be in the main electrical room to serve the egress lighting in the corridors, vestibule and building exits.

Electrical Equipment Spatial Allocation, Access and Maintenance

- Based on the newly allocated space for the electrical room, the square footage appears
 to have been decreased. To accommodate the revised space, the electrical panels will be
 arranged and positioned to ensure the proper NEC working clearances in front of all
 electrical equipment. The preliminary design will include 3, surface mounted branch
 panels that will each require a maximum horizontal wall space of roughly 30".
- The centralized battery inverter will be installed in the electrical room. The estimated horizontal wall space needed for installation is 26".
- A lighting control time clock will be installed in the electrical room for exterior lighting controls. The estimated horizontal wall space needed for installation is 8".

Lighting Systems

- Lighting throughout the building will consist of a variety of fixture types to suit individual space needs and applications. All fixtures will be specified as LED type. The majority of lighting in general back of house areas will be 2'x4' lay-in fixtures. Decorative fixtures will be provided in public lobbies and entry areas.
- Various lighting fixtures throughout the path of egress in the building will be connected
 to the centralized battery inverter. The remainder of the lighting will be connected to the
 normal power system.
- Lighting power densities throughout the building will be designed in accordance with the local energy codes. Light levels and fixture types within each space shall be designed in accordance with the latest IESNA guidelines.
- Coordination with the architect for specialty fixture models and locations will be ongoing throughout the project. Preliminary fixture schedules will be provided at Design Development submittal package.



Lighting Controls

- Controls will be provided to control lighting fixtures and loads in accordance with the local energy codes. Lighting controls will consist of vacancy/occupancy sensing devices, daylight photosensors, and timer-based relay panels as required to control lights per code.
- Generally, lighting controls functionality will consist of the following:
 - Vacancy sensors for manual on / auto off in all small rooms, back of house, storage, offices and housekeeping. Vacancy sensors may be integrated into wall switch if room is <200s.f.
 - o Timer based controls for all public lobbies and corridors. Override switches will be provided at various locations for manual ON after normal operating hours.
 - Ceiling mounted vacancy sensors in all larger rooms for manual on / auto off control.
 - Open office areas will be provided with automatic control of not more than 600s.f. zones, with manual override push-button switches.
 - Daylight sensing will provide for automatic dimming of fixtures in daylight zones, where daylight zone exceeds 150W of lighting.
- Exterior building lighting control will be provided to reduce lighting power by not less than 30% after business hours. This will be accomplished be either dimming fixtures to lower output levels or turning off select exterior fixtures.

Outline Specifications

26 05 19 Low-Voltage Electrical Power Conductors

- All branch circuit and feeder conductors within the building will be 98% conductivity copper. Conductors #8 AWG and larger shall be stranded. Type THHN or THWN insulation will be specified for all conductors. The use of metal-clad type MC cable shall be limited to fixture whips and final connection to equipment, lengths not to exceed 6 feet.
- Typical manufacturers who provide basis-of-design quality conductors are Southwire, General Cable, and Encore Wire.

26 05 26 Grounding and Bonding for Electrical Systems

• All ground conductors shall be copper. All ground conductors #8 AWG and larger shall be stranded. Ground rods shall be 3/4" x 10' copper-clad steel. Ground busses shall be rectangular bars of annealed copper, 1/4" x 2" in cross section and shall have lengths as required to accommodate all connected ground conductors. All grounding and bonding materials and equipment shall comply with UL 467.



- A ground ring will be constructed in the basement and crawlspace areas of the building, to provide a solidly grounded system for the lightning protection and electrical distribution systems. At various locations along the perimeter ground ring, the loop conductor will be connected to a triad of ground rods. Grounding busses will be provided within each electrical and telecommunications room. All feeders and branch circuit s shall contain an insulated equipment grounding conductor.
- Grounding system resistance tests shall be performed by a qualified agency or contractor. Grounding resistance shall not exceed 3 ohms at the electrical services.

26 05 29 Hangers and Supports for Electrical Systems

- Hangers and supports for electrical equipment, busways, and conduit systems shall be constructed of slotted galvanized steel support systems. Installation of support systems shall be in strict compliance with the requirements of NECA 1 and NECA 101.
- Manufacturers offering slotted steel support products with the basis-of-design quality include Eaton/Cooper B-Line, Unistrut, and Thomas & Betts.

23 05 29 Hangers & Supports for HVAC Piping and Equipment

Required submittals will include product data.

26 05 33 Raceway and Boxes for Electrical Systems

- Within the building, conduit shall be used for all branch circuits and feeders. Where concealed within ceilings or walls, type EMT shall be used. Where exposed conduit is used, it shall be either type IMC or galvanized rigid steel conduit. Flexible metal conduit will only be acceptable at final connections to light fixtures or vibrating equipment, and shall only be used in lengths of less than 6 feet.
- Wireways and junction / device boxes shall be made of sheet metal. Enclosures and cabinets shall have continuous hinged covers.
- Manufacturers offering conduit that meets the basis-of-design quality include Wheatland Tube, Allied Tube and Conduit, and Republic Conduit.

26 05 53 Identification for Electrical Systems

All equipment, conduit, raceways, boxes, and conductors shall be adequately identified.
Raceways / conduit shall be identified with self-adhesive vinyl labels indicating feeder
voltage, origination, and destination. Conductors shall be either factory color coded or
labeled with color-coding tape. Each phase conductor and ground conductor shall be
color coded in accordance with industry standard color systems. All equipment
(including panelboards, disconnect switches, switchboards, UPS equipment, transfer
switches, transformers, and equipment cabinets) shall be labeled with self adhesive
engraved laminated acrylic or melamine labels. Equipment labels shall include
device/equipment name/tag, voltage, phase, and "fed from" location.

26 05 73 Overcurrent Protective Device Coordination Study

 Project shall include an overcurrent device coordination study, performed by a qualified licensed professional engineer. All distribution system components/breakers shall be properly coordinated to ensure fault isolation to the nearest upstream circuit breaker.



The overcurrent device study shall include time/current curves and settings for all electronic trip and adjustable trip setting breakers/devices.

26 09 23 Lighting Control Devices

- Lighting control devices will include occupancy/vacancy sensors. Ceiling mounted occupant sensing devices shall be dual technology (passive infrared and ultrasonic) type. Combination wall switch sensors shall be passive infrared type, with manual override switches.
- Manufacturers offering products that meet the basis-of-design quality include Wattstopper, Acuity Controls/Sensor Switch, and Leviton.

26 24 16 Panelboards

- Panelboards shall be surface mounted type, with bolt-on, molded case overcurrent protection devices. Panels shall be NEMA 250, Type 1, with tinned aluminum bussing and hinged front cover. All lugs shall be compression type. Each panel shall have an integral/internal power monitoring device with digital display, capable of recording and monitoring voltage levels, and power consumption. Metering devices will assist in verification of electrical power consumption as required by LEED Credit EA5, Measurement and Verification.
- Manufacturers offering products that meet the basis-of-design are Eaton, Square-D/Schneider Electric, or Siemens.

26 27 26 Wiring Devices

- Commercial grade wiring devices shall be used for all receptacles and switches.
- Manufacturers offering products that meet the basis-of-design include Cooper Wiring Devices, Hubbell, Leviton, and Pass & Seymour/Legrand.

26 28 16 Enclosed Switches and Circuit Breakers

- Enclosed switches and circuit breakers shall be heavy-duty type. Fusible and non-fusible switches shall be used where applicable. In dry locations, switches shall be NEMA 250, Type 1. In outdoor areas, switches shall be NEMA 250, Type 4.
- Manufacturers offering products that meet the basis-of-design are Eaton, Square-D/Schneider Electric, or Siemens.

26 33 53 Static Uninterruptible Power Supply

- UPS units shall be battery type (VRLA), with minimum 30 minutes of battery backup at full load. Units shall be full on-line double conversion type, with power quality filtering and internal static bypass functionality.
- Manufacturers offering products that meet the basis-of-design quality are Emerson, APC/Schneider Electric, and Eaton.

26 43 13 Surge Protection Devices for Low-Voltage Electrical Power Circuits

All service entrance switchboards, distribution panels, and branch circuit panels serving
electronic/telecommunication circuits shall have integral/internal surge protection
devices. Devices shall be factory installed by the same manufacturer as the
switchboard/panel.



 Manufacturers offering products that meet the basis-of-design are Eaton, Square-D/Schneider Electric, or Siemens.

26 51 00 Interior Lighting

- All interior lighting fixtures shall be LED type, selected in accordance with general requirements outlined above. All light fixtures shall have a minimum of 5 year warranty against defects. Drivers for LED fixtures shall be dimmable where required, with 0-10v dimming capability.
- Manufacturers offering products that meet the basis-of-design quality are Emerson, APC/Schneider Electric, and Eaton.

26 36 00 Transfer Switches

- Transfer switches shall be contactor type, open/programmed transition, with 4-pole contacts. Neutral pole shall be switched with phase contacts. Switches shall be automatic type, with fault current closing and withstand ratings adequate for fault conditions at switch location. Switch shall have silver or silver alloy composition.
- Manufacturer of switches shall be the same as the generator manufacturer.

26 41 13 Lightning Protection for Structures

• Lightning protection system shall be installed on the building in accordance with NFPA 780 requirements. Provide aluminum air terminals and aluminum main and bonding conductors. Building shall have approximately 12 down conductors, connecting to the ground loop in accordance with the requirements.

26 43 13 Surge Protection Devices for Low-Voltage Electrical Power Circuits

- All service entrance switchboards, distribution panels, and branch circuit panels serving electronic/telecommunication circuits shall have integral/internal surge protection devices. Devices shall be factory installed by the same manufacturer as the switchboard/panel.
- Manufacturers offering products that meet the basis-of-design are Eaton, Square-D/Schneider Electric, or Siemens.

26 51 00 Interior Lighting

 All interior lighting fixtures shall be LED type, selected in accordance with general requirements outlined above. All light fixtures shall have a minimum of 5 year warranty against defects. Drivers for LED fixtures shall be dimmable where required, with 0-10v dimming capability.



LOW VOLTAGE SCOPE NARRATIVE

Design Criteria

- Applicable Codes and Standards
 - o Refer to Executive Summary section for applicable codes and standards.

General Conditions

The Structured Cabling System (SCS) will be designed to applicable Telecommunication Industry Standards

 Association (TIA) standards. The SCS design will consist of horizontal links (Category 6) to designated workstations/device outlets and a fiber optic and copper backbone to each technology room.

The owner will provide the network equipment and programming for the Project's Local Area Network (LAN) and, as such, provide communications connectivity for the following systems:

- Network switches and port configuration
- Voice over Internet Protocol (VoIP)
- Wireless Local Area Network (WLAN)
- Security camera subnets
- Audiovisual subnets (if applicable)

Main Telecommunication Equipment Room

As it is currently configured, each facility has a single Equipment Room/Entrance Facility where site fiber and utility will be terminated. All local structured cabling will be terminated in this room.

MEPCE suggests utilizing a combination 4-post racks and cabinets to house the owner's server equipment. For local structured cabling distribution, 4-post racks are recommended.

Owner requested that each facilities Equipment Room be interconnected with conduit pathways for a future fiber loop.

All facility headend equipment will be located in this room including:

- Video Surveillance System
- Paging System
- Intrusion Detection System
- Access Control Server

Telecommunication Rooms

The Training facility will include a small TR supporting the Virtual Reality area and the AV for the Training and Multi-purpose rooms. The room will be configured similarly to the Main Equipment Room with racks and pathways into the room. Fiber will be utilized to connect the TR to the Main Equipment Room.

Backbone Cabling

The primary utility feed for the facility will be supplied by the local internet service provider. Two 2" conduits are to be routed underground from an ISP coordinated location to the Entrance Facility/Equipment Room.

All fiber cabling to be tight buffer for all indoor applications and loose tube for outdoor applications. The grade index shall be multi-mode, armored, at 50/125 micron fiber. All end connections for all fiber strands to be 'LC' connections. All fiber pathways will consist of inner-duct, conduit, or a combination of both. Each fiber run will be labeled with number of fibers and cable type.



Horizontal Cabling

Blue Cat6 cabling will be the facility standard and will be utilized for all voice/data cabling, patch panel connections, connectors, patch cords, and faceplate connections. High-density 48 port patch panels to be utilized for final terminations from work area outlets. Patch panels will be split from the owner provided switch with a horizontal cable manager. Secondary horizontal cabling for accessible ceiling space to utilize single outlet cable hangers from the cable tray to the device or outlet termination point. For nonaccessible ceiling spaces, conduit to be utilized to device or outlet termination point. Larger offices to include (2) 2-data locations and all standard or smaller offices to have single 2-data location. All cabling to be terminated in "keystone" style jack. Owner will procure VOIP phones with network passthrough, no separate voice outlets will be required. Copper cabling not to exceed 295-feet.

Pathway Distribution

The structured cabling system design will include primary and branch pathways to support and protect the horizontal link and backbone cabling within the scope of the project. These pathways will be designed with a 50% fill rate capacity. J-hook or similar supports will only be allowed for branch distribution. EMT conduit will be required above all ceilings that do not have removal access panels or lay-in ceiling tiles. Mechanical and non-mechanical firestopping systems will be specified for all double and single membrane penetrations of fire rated walls and floors.

Telecommunications Grounding System

Busbars will be provided in each Equipment Room/Entrance Facility rooms.

Racks, cable tray, and other metal telecommunications equipment will be grounded to the building grounding system.

Wireless System

Wireless LAN coverage (Wi-Fi) is to be provided throughout the interior of the Training Center and Gun range. The structured cable design will provide (1) data outlet to each access point (AP) location. The access point data outlet will include (1) CAT-6 cables with 15'-0" of cable slack. The owner will provide the Wi-Fi antennas.

Distributed Antenna System

Owner confirmed a DAS system will not be required for this project.

Outline Specifications

27 05 26 Communications Grounding and Bonding

> A grounding system composed of busbars, grounding conductors, bonding conductors, and connecting devices, will create a low impedance grounding system.

27 05 28 Communications Building Pathways

> The structured cabling system design will include primary and branch pathways of cable tray to support and protect the horizontal link and backbone cabling within the scope of the project. These pathways will be design with a 50% fill rate capacity. J-hook or similar support will only be allowed for branch distribution. EMT conduit will be required above all ceilings that do not have removal access panels or lay-in ceiling tiles. Mechanical and non-mechanical firestopping systems will be specified for all double and single membrane penetrations of fire rated walls and floors.

27 08 11 Communications Twisted Pair Testing



The testing requirements shall be in accordance with EIA-568 standards and will test continuity, opens, shorts, crossed pairs, and split pairs. 27 08 21 Communications Fiber Optic Testing The testing requirements shall be in accordance with EIA-526 standards to verify integrity of fiber connections between devices. 27 11 00 Communications Equipment Rooms The equipment rooms will be comprised of a server cabinets and 4-post racks. All owner switches to be placed in 4-post racks and will include a N+1 power solution. PDU's to be vertically installed on back of racks and will be coordinated with electrical for power requirements. Racks to be separated by vertical wire managers, 8" in between racks, and 4" managers on the ends. Copper will be landed into the room on a horizontal ladder system that will be routed around the room and over the racks. 27 13 13 Communications Twisted Pair Cabling The project standard cable will consist of 4-pair Category 6 UTP plenum rated cable. At the station end of the location, CAT 6 white jack inserts should be terminated on a single or multi-port double gang faceplates. Cables will be terminated in patch panels and will be separated between General, Wireless Access Points, and Security. Basis for design will be Panduit. City of Weatherford to provide cable and outlet labeling standards. Category 3 cabling shall be provided in between each TR for traditional analog systems. Communications Fiber Optic Cabling 27 13 23 Fiber optics will be used as the backbone connecting the facility Technology Rooms to the Entrance Facility. Multimode fiber is expected basis for design for owner provided switches. 27 41 16 Communications Integrated Audiovisual Systems

The AV systems will be coordinated on a room-by-room basis per the owner's needs. Each room will have an intuitive control system with clearly marked buttons. The contractor will be required to train the owner on the system.

DEMOLITION GENERAL NOTES

- 1. COMPLY WITH GOVERNING EPA NOTIFICATION REGULATIONS BEFORE BEGINNING SELECTIVE DEMOLITION. COMPLY WITH HAULING AND DISPOSAL REGULATIONS OF AUTHORITIES HAVING JURISDICTION.
- 2. MAINTAIN FIRE-PROTECTION FACILITIES IN SERVICE DURING SELECTIVE DEMOLITION OPERATIONS.
- 3. REMOVE, REPLACE, PATCH, AND REPAIR MATERIALS AND SURFACES CUT OR DAMAGED DURING SELECTIVE DEMOLITION, BY METHODS AND WITH MATERIALS SO AS NOT TO VOID EXISTING WARRANTIES.
- 4. VERIFY THAT UTILITIES HAVE BEEN DISCONNECTED AND CAPPED BEFORE PROCEEDING TO DEMOLITION.
- 5. MAINTAIN SYSTEMS TO REMAIN AND PROTECT THEM AGAINST DAMAGE DURING SELECTIVE DEMOLITION OPERATIONS.
- 6. LOCATE, IDENTIFY, DISCONNECT, AND SEAL OR CAP OFF SERVICES AND MECHANICAL/ELECTRICAL SYSTEMS SERVING AREAS TO BE SELECTIVELY DEMOLISHED.
- 7. IF SERVICES/SYSTEMS ARE REQUIRED TO BE REMOVED, RELOCATED, OR ABANDONED, BEFORE PROCEEDING WITH SELECTIVE DEMOLITION PROVIDE TEMPORARY SERVICES/SYSTEMS THAT BYPASS AREA OF SELECTIVE DEMOLITION AND THAT MAINTAIN CONTINUITY OF SERVICES/SYSTEMS TO OTHER PARTS OF BUILDING.
- 8. REMOVE AIR-CONDITIONING EQUIPMENT WITHOUT RELEASING REFRIGERANTS.
- 9. ANY WORK INVOLVING A SERVICE SUSPENSION SHALL BE SCHEDULED IN ADVANCE WITH THE OWNER. OBTAIN WRITTEN APPROVAL FROM THE OWNER WHEN INTERRUPTION OF SERVICES IS UNAVOIDABLE.
- 10. PERFORM NO WORK IN ANY BUILDING WHICH WOULD INTERFERE WITH ITS USE DURING NORMAL HOURS OF OCCUPANCY, UNLESS SPECIAL PERMISSION IS GRANTED BY THE OWNER. INCLUDED ARE OPERATIONS WHICH WOULD CAUSE OBJECTIONABLE NOISE OR SERVICE INTERRUPTIONS.
- 11. DO NOT CUT ANY STRUCTURAL MEMBER UNLESS SPECIFIC WRITTEN PERMISSION IS PROVIDED BY THE ARCHITECT AND STRUCTURAL
- 12. WHERE OPENINGS ARE CUT IN FIRE-RATED WALLS OR FLOORS, SEAL THE ANNULAR SPACE BETWEEN THE WORK INSTALLED AND THE FIRE-RATED CONSTRUCTION. SEALANT, AS APPLIED, SHALL BE FIRE-RATED TO MAINTAIN THE FIRE RATING OF THE CONSTRUCTION PENETRATED, AND SHALL BE APPROVED BY THE ARCHITECT.

ABBREVIATIONS

	ABBREV	IAHO	NS .
A/C	AIR CONDITIONING	HD	HEAD
ACH	AIR CHANGE PER HOUR	HP	HORSEPOWER
AD	ACCESS DOOR	HPS	HIGH PRESSURE STEAM
AFF	ABOVE FINISHED FLOOR	HVAC	HEATING, VENTILATION & AIR CONDITIONING
AFMS	AIR FLOW MEASURING STATION	HWP	HYDRONIC HEATING WATER PUMP
AFUE	ANNUAL FUEL UTILIZATION EFFICIENCY	НХ	HEAT EXCHANGER
AHU	AIR HANDLING UNIT	KW	KILOWATT
AHJ	AUTHORITY HAVING	KWH	KILOWATT HOUR
АПЈ	JURISDICTION	LAT	LEAVING AIR TEMPERATURE
APD	AIR PRESSURE DROP	LBS	POUNDS
AS	AIR SEPARATOR	LPS	LOW PRESSURE STEAM
BAS	BUILDING MANAGEMENT	MBH	THOUSAND BTU PER HOUR
	SYSTEM	MCA	MINIMUM CIRCUIT AMPACITY
BD	BALANCING DAMPER	MFG	MANUFACTURER
BFF BHP	BELOW FINISH FLOOR BRAKE HORSEPOWER	MOCP	MAXIMUM OVERCURRENT PROTECTION
BTUH	BRITISH THERMAL UNITS PER HOUR	(N)	NEW
CAV	CONSTANT AIR VOLUME	N/A	NOT APPLICABLE
CFM	CUBIC FEET PER MINUTE	NC	NOISE CRITERIA
CHWP	CHILLED WATER PUMP	NIC	NOT IN CONTRACT
CLG	CEILING	NTS	NOT TO SCALE
CO	CLEAN OUT	OA	OUTSIDE AIR
CD	CONDENSATE DRAIN	OBD	OPPOSED BLADE DAMPER
CP	CONDENSATE PUMP	PD	PRESSURE DROP
CRAC	COMPUTER ROOM A/C UNIT	PH	PHASE (ELECTRICAL)
OT		PLBG	PLUMBING
CT	COOLING TOWER	PSI	POUNDS PER SQUARE INCH
CU	CONDENSING UNIT	QTY	QUANTITY
CV	CONSTANT VOLUME/ CONTROL VALVE	RA	RETURN AIR
(D)	DEMO	RH	RELATIVE HUMIDITY
dB	DECIBELS	RTU	ROOF TOP UNIT
DDC	DIRECT DIGITAL CONTROL	SA	SUPPLY AIR
DEG	DEGREES	SD	SMOKE DAMPER
DN	DOWN	SF	SUPPLY FAN
DX	DIRECT EXPANSION	SP	STATIC PRESSURE
(E)	EXISTING	Т	THERMOSTAT/ THERMOMETER
EA	EXHAUST AIR	TYP	TYPICAL
EAT	ENTERING AIR TEMPERATURE	UH	UNIT HEATER
EER	ENERGY EFFICIENCY RATIO	VAV	VARIABLE AIR VOLUME
EF	EXHAUST FAN	VFD	VARIABLE FREQUENCY DRIVE
ET	EXPANSION TANK	WB	WET BULB
EUH	ELECTRIC UNIT HEATER	W.G.	WATER GAUGE
FCU	FAN COIL UNIT	W.P.D.	WATER PRESSURE DROP
FD	FIRE DAMPER	WSHP	WATER-SOURCE HEAT PUMP
FLA	FULL LOAD AMPS	WT	WEIGHT
FPI	FINS PER INCH		
FSD	FIRE-SMOKE DAMPER		
G	GAS		
GPM	GALLONS PER MINUTE		
01/	CDAVITY VENTUATOR		

GRAVITY VENTILATOR

MECHANICAL GENERAL NOTES

- 1. ALL DUCTWORK DIMENSIONS SHOWN REPRESENT INSIDE CLEAR DIMENSIONS.
- 2. THE MECHANICAL LAYOUT SHOWN ON THIS DRAWING IS FOR GENERAL ARRANGEMENT ONLY. THE CONTRACTOR SHALL COORDINATE ALL WORK WITH THE CONDITIONS AT THE JOB SITE AND ALL THE OTHER TRADES INVOLVED.
- 3. THE CONTRACTOR SHALL FURNISH AND INSTALL ALL THE NECESSARY PIPING, FITTINGS, VALVES, HARDWARE, SUPPORTS AND ACCESSORIES REQUIRED FOR THE PROPER INSTALLATION AND OPERATION OF THE NEW MECHANICAL SYSTEM(S).
- 4. DO NOT SCALE LOCATIONS OR PARTITIONS FROM THIS DRAWING. THE CONTRACTOR SHALL REFER TO THE MANUFACTURER'S CUT-SHEETS, ROUGHING-IN DIMENSIONS, DETAILS, SPECIFICATIONS AND ALL OTHER INFORMATION RELATED TO THIS PROJECT, AS REQUIRED.
- 5. THE CONTRACTOR SHALL COORDINATE ALL THE FLOOR AND PARTITION PENETRATIONS WITH THE FIELD CONDITIONS AND STRUCTURAL DESIGN BEFORE DRILLING OR CORE-BORING.
- 6. THE CONTRACTOR SHALL SEAL ALL PENETRATIONS WITH A CODE APPROVED FIRE RATED MATERIAL AS REQUIRED TO MAINTAIN THE FIRE SEPARATION BETWEEN FLOORS/ROOF REQUIRED BY THE ARCHITECTURAL DRAWINGS. REFER TO THE ARCHITECTURAL DRAWINGS FOR ADDITIONAL INFORMATION AND FIRE BARRIER LOCATIONS.
- THE CONTRACTOR SHALL SUBMIT MANUFACTURER'S SPECIFICATIONS AND CUT-SHEETS FOR ALL THE EQUIPMENT, FITTINGS AND COMPONENTS AS REQUIRED FOR FINAL APPROVAL BY THE ENGINEER BEFORE PURCHASING OR INSTALLING THEM. REFER TO SPECIFICATIONS FOR MORE COMPLETE INFORMATION ABOUT THE FOURMENT SCHEDULED.
- COMPLETE INFORMATION ABOUT THE EQUIPMENT SCHEDULED.
- 8. THE CONTRACTOR SHALL TEST ALL NEW PIPING AND NEW EQUIPMENT FOR PROPER OPERATION AND SHALL MAKE ALL NECESSARY REPAIRS AS REQUIRED TO PROVIDE A COMPLETE WORKING SYSTEM.
- THE CONTRACTOR SHALL BE RESPONSIBLE FOR RESTORING ALL THE AREAS AFFECTED BY THE WORK REQUIRED IN THESE DRAWINGS TO THEIR ORIGINAL CONDITION AS REQUIRED BY THE OWNER/ARCHITECT.
- 10. THE CONTRACTOR SHALL BE RESPONSIBLE FOR REMOVING ALL DEBRIS FROM THE JOB-SITE AS REQUIRED BY THIS CONTRACT IN COMPLIANCE WITH ALL LOCAL, STATE AND FEDERAL REGULATIONS.
- 11. THE CONTRACTOR SHALL BE RESPONSIBLE FOR SCHEDULING, PERMITTING, AND CONDUCTING ALL THE INSPECTIONS AND TESTS REQUIRED BY THE LOCAL AUTHORITY HAVING JURISDICTION. CONTRACTOR SHALL PROVIDE 48 HOURS NOTICE OF COMMISSIONING INSPECTION TO THE
- 12. ALL WORK AND INSTALLATION SHALL BE DONE BY A LICENSED CONTRACTOR WITH EXPERIENCE IN THE WORK REQUIRED FOR THIS PROJECT.
- 13. ALL WORK SHALL COMPLY WITH THE 2021 INTERNATIONAL BUILDING CODE (2021 IBC), 2021 INTERNATIONAL MECHANICAL CODE (2021 IMC), 2021 INTERNATIONAL PLUMBING CODE (2021 IPC), 2021 INTERNATIONAL FUEL GAS CODE (2021 IFGC), 2021 INTERNATIONAL ENERGY CONSERVATION CODE (2021 IECC), AND THE NATIONAL FIRE PROTECTION ASSOCIATION AND ALL OTHER CODES AND STANDARDS AS MAY BE APPLICABLE WITHIN THE CITY OF SAGINAW.
- 15. ALL PIPING, CLAMPS, SUPPORTS, ETC. SHALL BE FASTENED TO JOISTS OR BEAMS. DO NOT ATTACH ANYTHING DIRECTLY TO THE DECK, CEILING SUPPORT SYSTEM, PIPING, CONDUIT OR DUCTWORK ABOVE.

14. ALL EQUIPMENT SHALL BE SUPPORTED FROM STRUCTURAL MEMBERS. NO WEIGHT CAN BE PLACED ON THE ROOFING MATERIALS OR


- 16. CONTRACTOR SHALL BRING TO THE ATTENTION OF THE ENGINEER ANY CODE ISSUES NOT ALREADY ADDRESSED.
- 17. THESE DRAWINGS DO NOT INDICATE OR SHOW ALL EXISTING PIPING, EQUIPMENT, DUCTWORK, ETC. THESE DRAWINGS ARE NOT A SUBSTITUTE FOR FIELD VERIFICATION
- FOR FIELD VERIFICATION.

18. ALL NEW ROOF PENETRATIONS SHALL BE PER THE ARCHITECTURAL DRAWINGS AND SPECIFICATIONS.


- 19. ALL NEW EQUIPMENT SUPPORTS SHALL BE INSTALLED PER THE ARCHITECTURAL DRAWINGS AND SPECIFICATIONS.
- 20. ALL NEW CURB CAPS SHALL BE INSTALLED PER THE ARCHITECTURAL DRAWINGS AND SPECIFICATIONS.
- 21. ALL ROOF MOUNTED EQUIPMENT LOCATIONS SHALL BE VERIFIED AND APPROVED BY A TEXAS REGISTERED STRUCTURAL ENGINEER.
- 22. DUCTWORK SHOP DRAWINGS SHALL BE PROVIDED TO, REVIEWED BY, AND APPROVED BY THE ENGINEER PRIOR TO ANY DUCTWORK FABRICATION AND OR INSTALLATION. DUCTWORK SHOP DRAWINGS SHALL INDICATE THE ACTUAL SIZE OF EACH SECTION OF DUCT AND ALL REQUIRED FITTINGS AND TRANSITIONS.
- 23. CONTRACTOR SHALL PROVIDE UL LISTED FIRE DAMPERS AT ALL FIRE WALL PENETRATIONS. REFER TO ARCHITECTURAL FOR FIRE WALL RATING. REFER TO MECHANICAL FLOOR PLANS FOR DAMPER SIZING.
- 24. PROVIDE DUCTWORK TRANSITIONS AS REQUIRED FOR ALL AIR DEVICE AND EQUIPMENT CONNECTIONS.
- 25. REMOVE: DETACH ITEMS FROM EXISTING CONSTRUCTION AND LEGALLY DISPOSE OF THEM OFF-SITE, UNLESS INDICATED TO BE REMOVED AND SALVAGED OR REMOVED AND REINSTALLED.
- 26. REMOVE AND SALVAGE: DETACH ITEMS FROM EXISTING CONSTRUCTION AND DELIVER THEM TO OWNER OR OWNER'S REPRESENTATIVE READY FOR REUSE.
- 27. REMOVE AND REINSTALL: DETACH ITEMS FROM EXISTING CONSTRUCTION, PREPARE THEM FOR REUSE, AND REINSTALL THEM WHERE INDICATED.
- REMOVED, REMOVED AND SALVAGED, OR REMOVED AND REINSTALLED.

28. EXISTING TO REMAIN: EXISTING ITEMS OF CONSTRUCTION THAT ARE NOT TO BE REMOVED AND THAT ARE NOT OTHERWISE INDICATED TO BE

- 29. CONTRACTOR SHALL BID EQUIPMENT IN SCHEDULE AS BASIS OF DESIGN. ALTERNATE EQUIPMENT BY ACCEPTABLE MANUFACTURERS MEETING PERFORMANCE REQUIREMENTS MAY BE REVIEWED BY DESIGN TEAM AND OWNER RESULTING IN A CREDIT IF USED.
- 30. IN THESE DOCUMENTS, "FURNISH" SHALL MEAN TO SUPPLY AND DELIVER TO PROJECT SITE, READY FOR UNLOADING, UNPACKING, ASSEMBLY, INSTALLATION AND SIMILAR OPERATIONS. "INSTALL" SHALL MEAN TO UNLOAD, TEMPORARILY STORE, UNPACK, ASSEMBLE, ERECT, PLACE, ANCHOR, APPLY, WORK TO DIMENSION, FINISH, CURE, PROTECT, CLEAN, AND SIMILAR OPERATIONS AT THE PROJECT SITE. "PROVIDE" SHALL MEAN TO FURNISH AND INSTALL, COMPLETE AND READY FOR INTENDED USE.

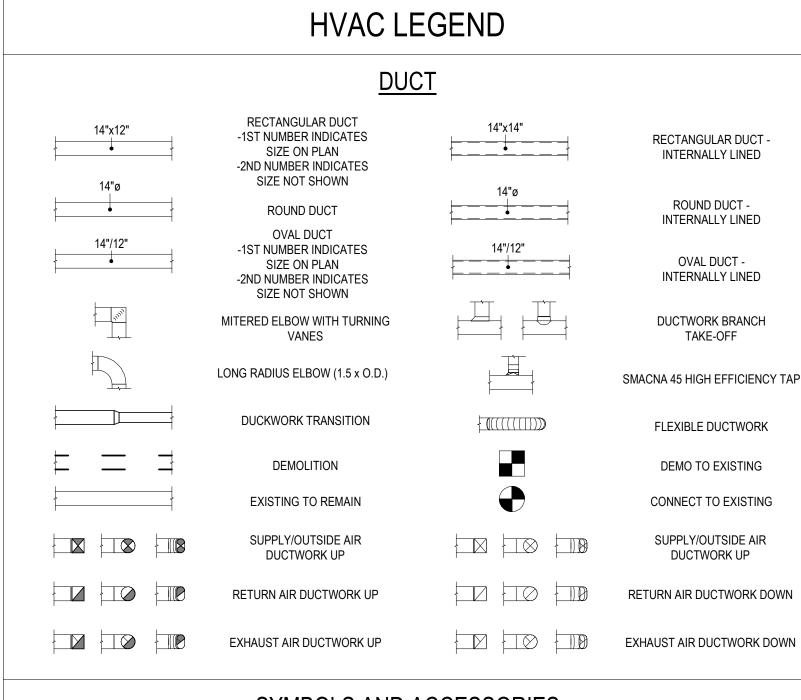

SYMBOLS AND ACCESSORIES

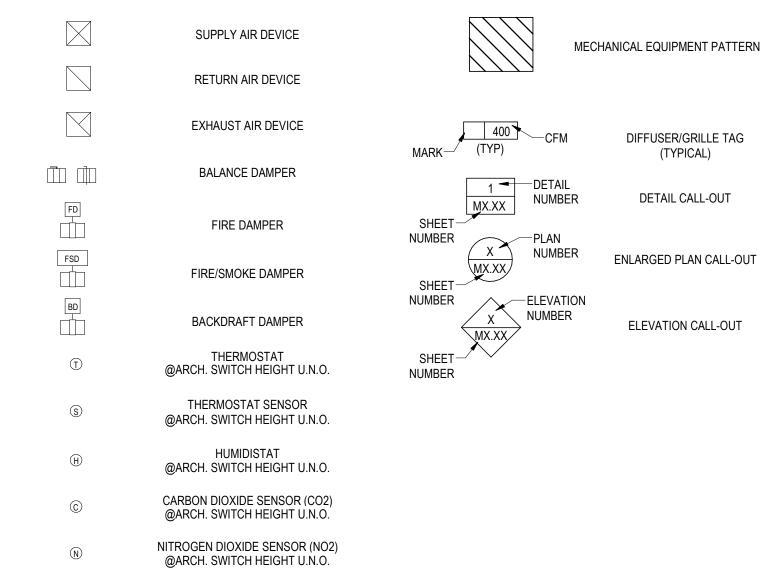

HYDRONIC PIPING SYSTEMS

CHS	CHILLED WATER SUPPLY	HWS	HEATING WATER SUPPLY	
CHR	CHILLED WATER RETURN	HWR	HEATING WATER RETURN	
CWS	CONDENSER WATER SUPPLY	RP	REFRIGERANT	
CWR	CONDNESER WATER RETURN	SP	STEAM	
CD	CONDENSATE DRAIN	SC	STEAM CONDENSATE	
	PIPE UP	£	PIPE DOWN	
	ISOLATION VALVE			

SAGINAW

ARCHITECT



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MEP CONSULTING ENGINEERS
ENGINEER: TANNER BRADLEY
TEXAS REGISTRATION NO: 115518

REGISTRATION

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DRAWING HISTORY

No.	DATE	DESCRIPTION
A	08/30/2024	SCHEMATIC DESIGN
Control	Control	
Co		

PROJECT NAME
SAGINAW
KEETER
BUILDING
RENOVATION

PROJECT LOCATION

355 W McLeroy Blvd.
Saginaw, TX 76179

PROJECT NUMBER 1006633.02

SHEET TITLE

MECHANICAL

GENERAL NOTES &

LEGEND

SHEET NUMBER

M-001

1 MECHANICAL ZONE PLAN
1/8" = 1'-0"



SAGINAW

ARCHITECT



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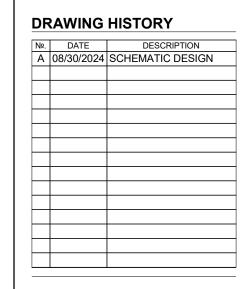
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PROJECT NAME
SAGINAW
KEETER
BUILDING
RENOVATION

PROJECT LOCATION

355 W McLeroy Blvd.
Saginaw, TX 76179

PROJECT NUMBER 1006633.02


SHEET TITLE

LEVEL 01

MECHANICAL PLAN

SHEET NUMBER

M-101

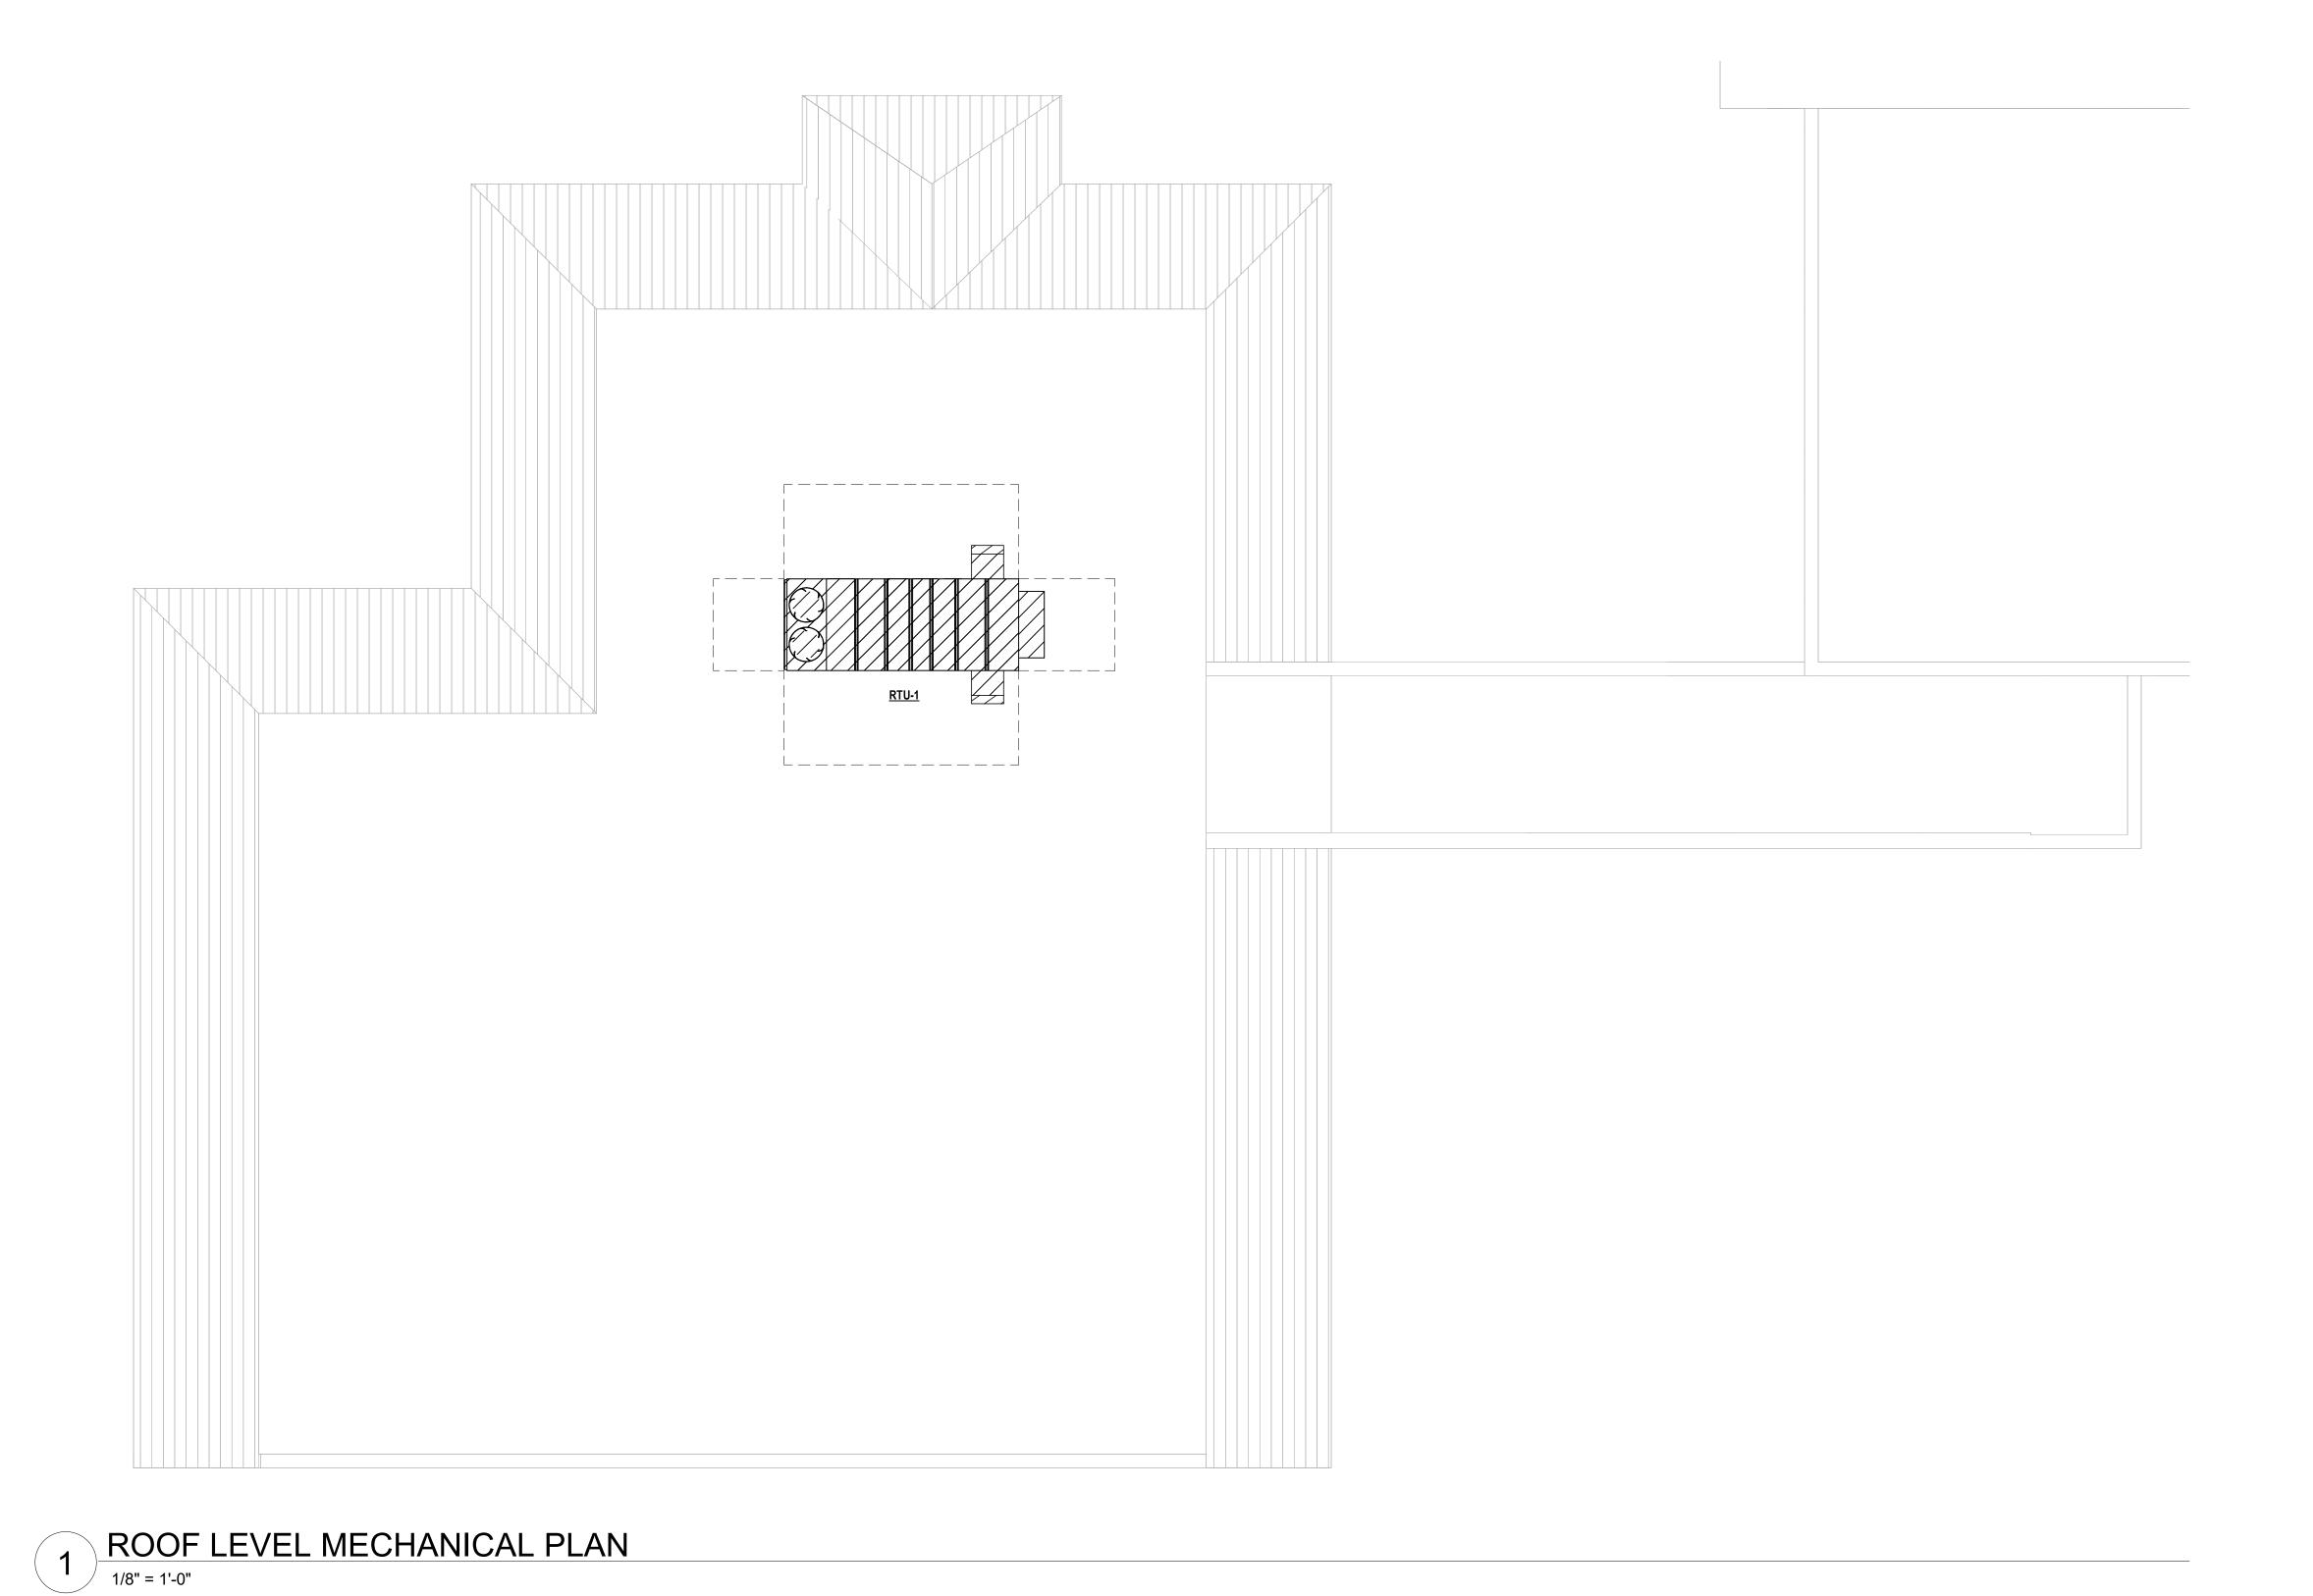

CLIENT

ARCHITECT



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Ιο.	DATE	DESCRIPTION
4	08/30/2024	SCHEMATIC DESIGN

PROJECT NAME
SAGINAW
KEETER
BUILDING RENOVATION

PROJECT LOCATION 355 W McLeroy Blvd. Saginaw, TX 76179

PROJECT NUMBER 1006633.02

SHEET TITLE ROOF LEVEL MECHANICAL PLAN

SHEET NUMBER

M-102



Estimate Report

Saginaw Keeter Bldg. Renovation

Saginaw, TX

AACEi Class 4: Concept

September 06, 2024

Version 2.00

Prepared for:



Prepared by:





Table of Contents



Saginaw Keeter Bldg. Renovation

Sections

Table of Contents
Estimate Version History
Basis of Estimate
Estimate Component Summary
Project Cost Summary
Project Escalation
Estimate Uniformat Summary
Estimate Details



Estimate Version History



Estimate Ver. #	Comments/Modifications			
1.00	Initial Delivered Version			
	Updates based on client comments - Phone Conversation with Raynaldo Herreros 9/4/24			
2.00 Updates based on client comments - E-mail from Linsey Barta dated 9/4/24				
	Updates based on client comments - E-mail from Brady Buckles dated 9/5/24			







01 EXECUTIVE SUMMARY

The total project cost for the scope of this project:

SUBTOTAL DIRECT COST (COST OF WORK)	\$	3,640,248
SUBTUTAL DIRECT COST (COST OF WORK)	ې	3,040,246
DESIGN EVOLUTION	\$	728,050
SUBTOTAL GMP (No Fee)	\$	4,368,297
CMAR FEE	\$	218,415
ESTIMATED CONSTRUCTION COST (ECC) W/FEE	\$	4,586,712
CONSTRUCTION CONTINGENCY	\$	458,671
ESTIMATED CONSTRUCTION COSTS (Final)	\$	5,045,383
ESCALATION \$	\$	321,946
TOTAL PROJECT COSTS	\$	5,367,329

02 PROJECT DESCRIPTION

Renovation of the existing Keeter Building including an approx. 1,000 S.F. addition and associated sitework.

03 QUANTITY TABULATION

See Estimate Details section for quantities.

04 BASIS OF ESTIMATE

Within the Aviation sector, APR has adapted from best practices and lessons learned to apply the collective method and approach to meet the purpose from which the owner/agency will use the estimate. This opinion of probable construction cost is based on files/drawing(s): Saginaw Keeter Bldg - Preliminary Cost Estimate Issue.pdf dated 8./23/24 produced by PGAL. Therefore, the estimators have applied an approach to developing this estimate that uses AACEi Class 4 methodologies.

05 BASIS OF PRICING

This Opinion of Probable Construction Cost reflects the fair market value for the construction of this project and should not be construed as a prediction of low bid. The unit costs include labor, material, and equipment costs plus subcontractors' overhead and profit costs. In parts of this Opinion of Probable Construction Cost, scope of work was measured to a discrete item from the drawings provided, or otherwise conceptualized. Construction costs, labor and equipment rates, and installation effort from R.S. Means were used as a general reference in addition to APR's construction cost libraries of historical cost information. However, the APR estimators adjusted line item costs for productivity (installation manhours) to account for job-site conditions and cost indices.

Taxes

0.0% Sales Tax on Material was applied to this Opinion of Probable Construction Cost.

Wage Rates

This Opinion of Probable Construction Cost is priced on the basis of fully burdened localized wage rates in the Fort Worth, TX area.

Duration

The anticipated duration of construction for this project is assumed as follows:

Construction Award Year: 2025 Construction Finish Year: 2026

Phasing

Phasing has been anticipated and taken into account for this project scope.

Access and Security

The Opinion of Probable Construction Cost anticipates and has taken into account potential constraints to site access or security.







06 ESCALATION

Cost Basis Year of 2024

Initial Escalation Rate: 4.50% beginning in 2025 and Compounding Annually per table below.

Overall Project Escalation: 6.38%, \$321,946

				Escalation
		Escalation Rate	Compounding	\$'s Per
		Applied Per Year	Escalation	Year
Cost Basis Year	2024	4.50%	0.00%	\$0
Construction Award Year	2025	4.50%	4.50%	\$136,225
Construction Finish Year	2026	4.50%	9.20%	\$185,721

07 MARK-UPS

DESIGN EVOLUTION 20.00%

BID ALLOWANCE Not part of this Estimate.

CMAR FEE 5.00%
CONSTRUCTION CONTINGENCY 10.00%

DESIGN Not part of this Estimate.

CONSTRUCTION MANAGEMENT Not part of this Estimate.

PM/CM Not part of this Estimate.

PLANNING Not part of this Estimate.

TESTING Not part of this Estimate.

Prime Contractor

 General Requirements
 15.0%

 Overhead
 5.0%

 Profit
 0.0%

 Bond & Insurance
 1.5%

 Mob/Demob
 1.0%

Sub Contractor

General Conditions 5.0% Overhead 10.0% Profit 5.0%

The 20.00% DESIGN EVOLUTION allowance on construction costs included in this Opinion of Probable Construction Cost is a budgeting value used to compensate for the lack of detail and definition during preliminary phases of design, as well as assumptions and allowances made with reference to quantities and pricing. This percentage is provided to cover scope which is not yet defined within the provided documents or narratives. These are monies which are expected to be absorbed into the line item detail as the design evolves.

AACE COST ESTIMATING CLASSIFICATION SYSTEM

Estimate Class	MATURITY LEVEL OF PROJECT DEFINITION DELIVERABLES	END USAGE	METHODOLOGY	DESIGN DEVEL ESTIMAT CONTINGE	ING
	(Expressed as % of complete definition)	(Typical purpose of estimate)	(Typical purpose of estimate)	(Typical estimating method)	(Typical allowance)
Class 5	0% to 2%	Functional area, or concept screening	Program or Rough order of Magnitude (ROM)	SF or m2 factoring, parametric models, judgment, or analogy	20% +
Class 4	1% to 15%	Schematic design or concept study	Concept or Feasibility	Parametric models, assembly driven models	15% to 20%
Class 3	10% to 40%	Design development, budget authorization, feasibility	Schematic Design	Semi-detailed unit costs with assembly level line items	10% to 15%
Class 2	30% to 75%	Control or bid/tender, semi-detailed	Design Development	Detailed unit cost with forced detailed take-off	5% to 10%
Class 1	65% to 100%	Check estimate or pre bid/tender, change order	Construction Documents	Detailed unit cost with detailed take-off	0% to 5%







The cost estimator makes the determination of the estimate class based upon the maturity level of project definition (design % complete). While the determination of the estimate class is somewhat subjective, the design input data, completeness and quality of the design deliverables serve to make the determination more objective. The cost estimator will make the final determination based on the actual detail provided, which may vary from the AACE Cost Estimating Classification System listed above.

08 BID ALLOWANCE

Not part of this Estimate.

09 APR PROJECT TEAM

Principal Estimator C. Aguirre Estimating Project Manager B. Reisinger

Estimators B. Reisinger, C. Reisinger, Z. Pavlic, E. Kruel

Cost Analyst, Coordination C. Watson, L. Smith

Quality Review C. Aguirre

10 <u>ASSUMPTIONS</u> / <u>CLARIFICATIONS</u>

System D	escription	Typical Sub Systems (Not all sub systems are necessarily included in project scope)
Α	Substructure	
A10	Foundations	Standard and special foundations, floor slabs on grade
В	Shell	
B10	Superstructure	Above grade structural frames, floors, roofs, exterior stairs and ladders
B20	Exterior Closure	Exterior skin and walls, insulation and vapor barriers, curtain wall, soffits, parapets, clerestory, windows and openings, doors, louvers and screens, exterior sun control devices, railings
B30	Roofing	Roof covering systems, fascia, insulation, skylights, roof access hatches, gutters and downspouts
С	Interiors	
C10	Interior Construction	Fixed, demountable and retractable walls and partitions, ceiling systems, personnel and specialty doors, specialties, compartments, signage, lockers, casework, countertops, interior windows, glazed partitions and storefronts, balustrades and screens, toilet and bath accessories
C30	Interior Finishes	Finishes for walls, partitions, floors, ceilings
D	Services	
D20	Plumbing	Storm Drain piping system, top level area drains, trench drains @ entry/exits
D20	Plumbing	Fixtures and related equipment, domestic water systems, sanitary waste and conveyance, storm water collection, natural gas, and special systems
D30	HVAC	Heating and cooling energy supply equipment, hydronic piping, air distribution, ventilation and exhaust, control systems and devices, testing and balancing, commissioning, refrigeration systems, grease and fume hoods and ducts
D40	Fire Protection	Water supply, sprinkler heads and release devices, stand-pipes and fire department connections, fire extinguishers, special application suppression systems
D50	Electrical	Power distribution equipment, transformers, motor-controls, stand-by/emergency power equipment, lighting fixtures and devices, communications, data, security and access control, fire safety systems, public address, grounding, lightning protection







System D	escription	Typical Sub Systems (Not all sub systems are necessarily included in project scope)						
E	Equipment & Furnishi	ngs						
E20	Furnishings	Fixed and movable modular furniture, artwork, window treatments, seating, rugs and floor mats, planters						
F	Special Construction 8	& Demo						
F20	Demolition	Structure removal, demolition, abatement of hazardous materials						
G	Building Sitework							
G10	Site Preparation	Earthwork, soil stabilization, clearing of vegetation, exterior demolition or relocations of pavements and surfaces, remediation or removal of hazardous soils						
G20	Site Improvements	Roadways, parking surfaces and pedestrian pavements, site developments, landscaping, flag poles, exterior seating						
G30	Site Mechanical Systems	Water supply, sanitary and storm water sewers and collection, heating and cooling distribution, fuel and gas distribution and storage						
G40	Site Electrical Utilities	Power distribution, substations, site lighting, grounding, communications, security and alarm systems, cathodic protection, CCTV monitoring, emergency power generators						

11 **EXCLUSIONS**

Hazardous Materials Design Fees Owner Soft costs Owner Contingency Building Permit





Estimate Component Summary



Delivery Method: CMAR Estimate Type: AACEi Class 4 WBS: Component/Uniformat

				ECC
Line #	Description	Qty.	UoM	w/Escalation
2	SITE	1	LS	\$458,278
3	SPECIAL CONSTRUCTION AND DEMOLITION	1	LS	\$81,316
20	SITEWORK	1	LS	\$376,962
79	BUILDING	1	LS	\$4,421,112
80	SUBSTRUCTURE	1	LS	\$79,285
107	SHELL	1	LS	\$413,225
161	INTERIORS	1	LS	\$859,680
225	SERVICES	1	LS	\$2,343,819
394	EQUIPMENT AND FURNISHINGS	1	LS	\$467,387
415	SPECIAL CONSTRUCTION AND DEMOLITION	1	LS	\$257,716
464	ALTERNATES	1	LS	-\$40,516
465	HVAC OPTION #2	1	LS	-\$40,516





Project Cost Summary



Saginaw Keeter Bldg. Renovation

WBS: Component/Uniformat Estimate Type: AACEi Class 4
Delivery Method: CMAR Estimate Date: 09/06/2024

				Component Scope of Work						
Project Component	Direct Cost	Primary	Unit of		Desig	n Evolu	ıtion	Subtotal GMP	Subtotal GMP	
	CY 2024 \$'s	Quantity	Measure	Α	В	С	Amount	Unescalated	Escalated	
SITE	341,896	1	LS	10%	0%	10%	68,379	410,276	436,455	
BUILDING	3,298,351	1	LS	10%	0%	10%	659,670	3,958,022	4,210,583	
SUBTOTAL DIRECT COST (COST OF WORK)	3,640,248	1	LS	Design Evolution Factors A. Scope Understanding to meet requirements B. Allowances provided in Direct Cost C. Confidence level of pricing in Direct Cost						This subtotal includes all contractor overheads, profits, bonds, and insurance.
DESIGN EVOLUTION	728,000	20.00%								a.k.a Design Growth Allowance
SUBTOTAL GMP (No Fee)	4,368,000	1	LS					4,368,000	4,647,000	Estimated cost at time of bid (Award).
CMAR FEE	218,000	5.00%						218,000	232,000	
ESTIMATED CONSTRUCTION COST (ECC) W/FEE	4,587,000							4,587,000	4,879,390	ECC with CMAR Fee
CONSTRUCTION CONTINGENCY	459,000	10.00%	LS					459,000	488,000	Construction Contingency (Change Orders) - Not included in ECC.
ESTIMATED CONSTRUCTION COSTS (Final)	5,045,000	1	LS					5,045,000	5,367,329	Estimated Final Contract
ESCALATION %	6.38%									
ESCALATION \$	322,000	1	LS							
TOTAL PROJECT COSTS	5,367,000	1	LS						5,367,000	

NOTE: With the exception of the Subtotal GMP (No Fee) Escalated column, and the ESCALATION \$ and TOTAL PROJECT COSTS rows, all cost values are displayed in 2024 dollars.

Alternates/Options	Direct Cost	Primary	Unit of		Desig	n Evolu	ıtion	Subtotal GMP	Subtotal GMP
	CY 2024 \$'s	Quantity	Measure	Α	В	С	Amount	Unescalated	Escalated
HVAC OPTION #2	(31,738)	1	LS	10%	0%	10%	-6,348	-38,086	-40,516






Project Escalation



Saginaw Keeter Bldg. Renovation

WBS: Component/Uniformat Estimate Type: AACEi Class 4
Delivery Method: CMAR Estimate Date: 09/06/2024

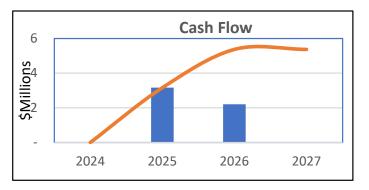

			Project Summ	ary		Estimate				
	Start	End	\$ Millions	Primary	Unit of	YR 1	YR 2	YR 3	YR 4	Escalated
Project Component	CY	CY	Total CY24	Quantity	Measure	2024	2025	2026	2027	Total
SITE	2025	2026	0.342	1	LS	-	0.205	0.137	-	0.364
BUILDING	2025	2026	3.298	1	LS	-	1.979	1.319	-	3.509
SUBTOTAL DIRECT COST	2025	2026	3.640	1	LS	-	2.184	1.456	-	3.873
DESIGN EVOLUTION			0.728	20.00%		-	0.437	0.291	-	0.775
SUBTOTAL GMP (No Fee)			4.368	1	LS	-	2.621	1.747	-	4.647
CMAR FEE			0.218	5.00%		-	0.131	0.087	-	0.232
ESTIMATED CONSTRUCTION COST (ECC) W/FI	EE		4.587	1	LS	-	2.752	1.835	-	4.879
CONSTRUCTION CONTINGENCY			0.459	10.00%		-	0.275	0.183	-	0.488
ESTIMATED CONSTRUCTION COSTS (Final)			5.045	1	LS	-	3.027	2.018	-	5.367
ESCALATION %			6.38%			0.00%	4.50%	9.20%	0.00%	
ESCALATION \$			0.322			\$0.00	\$0.14	\$0.19	\$0.00	
TOTAL PROJECT COSTS			5.367	1	LS	-	3.163	2.204	-	5.367

NOTE: With the exception of the Escalated Total column, and the ESCALATION \$ and TOTAL PROJECT COSTS rows, all cost values are displayed in 2024 dollars.





Estimate Uniformat Summary



Delivery Method: CMAR Estimate Type: AACEi Class 4 WBS: Component/Uniformat

	Saginaw Keeter Bidg Keno Conce	·ρι		FCC.	FCC II II
				ECC	ECC Unit
Line #	Description	Qty.	UoM	w/Escalation	Cost
2	SITE	1	LS	\$458,278	
3	SPECIAL CONSTRUCTION AND DEMOLITION	1	LS	\$81,316	
4	DEMOLITION	1	LS	\$81,316	
20	SITEWORK	1	LS	\$376,962	
21	SITE PREPARATION	1	LS	\$16,665	
34	SITE IMPROVEMENTS	1	LS	\$96,813	
49	LIQUID AND GAS SITE UTILITIES	1	LS	\$81,007	
69	ELECTRICAL SITE IMPROVEMENTS	1	LS	\$182,478	
79	BUILDING	1	LS	\$4,421,112	
80	SUBSTRUCTURE	1	LS	\$79,285	
81	DEEP FOUNDATIONS	1,003	S.F.	\$79,285	\$79.05
107	SHELL	1	LS	\$413,225	
108	SUPERSTRUCTURE	1	LS	\$116,734	
118	EXTERIOR VERTICAL ENCLOSURES	1	LS	\$184,811	
154	EXTERIOR HORIZONTAL ENCLOSURES	1	LS	\$111,681	
161	INTERIORS	1	LS	\$859,680	
162	INTERIOR CONSTRUCTION	1	LS	\$334,988	
185	INTERIOR FINISHES	1	LS	\$524,693	
225	SERVICES	1	LS	\$2,343,819	
226	PLUMBING	1	LS	\$397,074	
272	HEATING, VENTILATION, AND AIR CONDITIONING (HVAC)	1	LS	\$673,051	
330	FIRE SUPPRESSION - LIBRARY	1	LS	\$243,232	
332	FIRE SUPPRESSION - CITY HALL	1	LS	\$251,339	
335	ELECTRICAL	1	LS	\$405,087	
361	COMMUNICATIONS	1	LS	\$57,356	
369	ELECTRONIC SAFETY AND SECURITY	1	LS	\$118,503	
389	INTEGRATION AUTOMATION	1	LS	\$198,176	
394	EQUIPMENT AND FURNISHINGS	1	LS	\$467,387	
395	FURNISHINGS	1	LS	\$417,081	
410	EQUIPMENT	1	LS	\$50,306	
415	SPECIAL CONSTRUCTION AND DEMOLITION	1	LS	\$257,716	
416	SPECIAL CONSTRUCTION	1	LS	\$124,598	
419	DEMOLITION	1	LS	\$133,118	
464	ALTERNATES	1	LS	-\$40,516	
465	HVAC OPTION #2	1	LS	-\$40,516	
466	PLUMBING	1	LS	\$6,311	
514	HVAC	10,073	GSF	-\$46,827	-\$4.65







Delivery Method: CMAR Estimate Type: AACEi Class 4 WBS: Component/Uniformat

Saginaw Keeter Bldg Reno Concept

Patter Deem Mechanised Peth		Saginaw Keeter Bldg F	Reno Cor	ncept						
STE							Prime	Total	ECC	ECC Unit
SPECIAL CONSTRUCTION AND DEMOCRATION 1	Line #	Description	Qty.	UoM	Subtotal	Sub %	%	Direct Cost	w/Escalation	Cost
Part	2	SITE	1	LS	\$227,745	21.3%	23.8%	\$341,896	\$458,278	
Company Comp	3	SPECIAL CONSTRUCTION AND DEMOLITION	1	LS	\$40,410	21.3%	23.8%	\$60,665	\$81,316	
Description of the control of the			1	LS						
Protect Protection Company C										644.20
Description content generated Aux for terms accorded to referred out of "thick, enclodes healing and disposal fiers 1.5				L.F.						\$11.28
				S.Y.						\$39.42
1 Note Deem Mechanical treat exercing 0.00										
Penning demolities, premoce beach list goods, R. Briton, E. P. 10 Pages 52.00 50				S.Y.						\$39.42
1.5 December Security 1.5				I F						\$7.00
Institute Standard Standard				L.II .						Ş7.00
1	14		2,906.00	S.F.	\$9,944.88	21.3%	23.8%	\$14,929.50	\$20,012	\$6.89
17 Proc. Published Disposal 0.00					\$0.00		0.0%	\$0.00		
18 1.17 C. hauset, leading and/or greating, above 1.00 c.				S.F.						\$43.19
33 STEWORK 1.5 1				D.C.V						¢E 03
STEWORK 1 15 \$187,384 21,386 22,886 \$281,221 \$376,582 \$285 \$224,585 \$26,685 \$22 \$2000 \$200		Cycle hauling (wait, load, travel, unload or dump & return) time per cycle, excavated or borrow, loose cubic yards, 20								\$5.03 \$11.65
22 Interpretation 1.0 1.5 \$5,200 21.0% 23.0% 53.0.45 53.0.65 53.0.0 53.	20		1	10	¢107 224	24 20/	22.00/	¢201 221	¢27C 0C2	
22 Concentrating public harm resource, 5-172 CV, capacity = 235 CV, first bandone, hydraulic, careler mounted, excluding trust 22,70 E.V. 550,00 20,90 2			1							
22 Court May Date			0.00	LS						
25 Cyck balling (low), road, variety unload of dump & return) time per cycle, excavated or borrow, loose cubic yards, 25 275.00 LCY 51,572.23 22,80 23,80 23,50.07 33,156 511.45 515.25 515.				B.C.Y.						\$4.91
25 Cyck balling (low), road, variety unload of dump & return) time per cycle, excavated or borrow, loose cubic yards, 25 275.00 LCY 51,572.23 22,805 23,500.27 33,156 512.45 22,500.27 22,500.27 23,500.	24	1-1/2 C.Y. bucket, loading and/or spreading, shovel	212.70	B.C.Y.	\$531.24	21.3%	23.8%	\$797.51	\$1,069	\$5.03
26 Note Crashing	25		276.50	L.C.Y.	\$1,572.23	21.3%	23.8%	\$2,360.27	\$3,164	\$11.44
27 Fine grading finish grading 28 Fine grading finish grading 39 Rotz Aggregate Size 39 Rotz Aggregate Size 30 Rotz Aggregate Size 31 Rotz Rotz Rotz Size 32 Rotz Aggregate Size 32 Rotz Aggregate Size 32 Rotz Aggregate Size 33 Rotz Size 34 Rotz Rotz Rotz Size 35 Rotz Rotz Rotz Size 35 Rotz Rotz Rotz Size 36 Rotz Rotz Size 37 Rotz Rotz Rotz Size 37 Rotz Rotz Rotz Rotz Rotz Rotz Rotz Rotz	26		0.00		\$0.00	0.0%	0.0%	\$0.00	\$0	
29 Agregate for earthwork, crushed stone, 140 tons per CV., 172", spread with 200 HP dozer, includes load at pit and hall 2 miles round from percifice commonstron. 30 Compaction, walk behind, whrating plate 83.0 B.CV, 517.18 23.95 53.00 0.00 0.00 0.00 0.00 0.00 0.00 0.0	27	Fine grading, finish grading	764.33	S.Y.		21.3%	23.8%	\$858.84	\$1,151	\$1.51
30 Compaction, wash behind, whereing plate				L.C.Y.						\$60.80
33 Note: Topool Dorwow, weed free, spread with 200 HP dozer, includes load at pit and haul, 2 miles round 5,470 C.Y. \$55.40 21.3% 23.8% \$2,441.45 \$5.272 \$59.81 for excludes compaction with the compaction of the	30		85 30	BCY	\$71.78	21 3%	23.8%	\$107.75	\$144	\$1.69
32 Solis for earthwork, topical borrow, weed free, spread with 200 HP dozer, includes load at pit and haul, 2 miles round frie, excludes compaction 54.70 C.Y. \$1,86.29 21.376 23.88 \$52,41.43 \$3.272 \$59.81 \$33.000 \$33.000 \$33.000 \$4.000 \$33.				D.C.T.						Ģ1.03
33 Concrete pavement, 4500 ps.; fixed form, unreinforced, 12 ps.s, 6" thick, includes joints, finishing, and curing 36 Note: New Parking Pavement 37 Concrete pavement, 4500 ps.; fixed form, unreinforced, 12 ps.s, 6" thick, includes joints, finishing, and curing 38 Concrete pavement, 4500 ps.; fixed form, unreinforced, 12 ps.s, 6" thick, includes joints, finishing, and curing 39 Note: Sidewalks 30 Concrete pavement, 4500 ps.; fixed form, unreinforced, 12 ps.s, 6" thick, includes joints, finishing, and curing 41 August 20 St. \$2,565.50 21.33 \$2.38\$ \$3.56.65 \$11.441 \$774.45 \$3.90 to 10.00 \$1.00 \$		Soils for earthwork, topsoil borrow, weed free, spread with 200 HP dozer, includes load at pit and haul, 2 miles round	54.70	C.Y.	\$1,626.29	21.3%	23.8%	\$2,441.43	\$3,272	\$59.83
1	33		42.10	B.C.Y.	\$35.43	21.3%	23.8%	\$53.18	\$71	\$1.69
36 Note: New Parking Pawement 4500 pd. fixed form, unreinforced, 12 pass, 6" thick, includes joints, finishing, and curing 144.00 5.V. 55,885.80 21.3% 23.8% 583.53.56 51.14.41 579.45 38 Concrete pawement, reinforcing steel for rigid pawing, 12 bs, fs' 570.62 51.38 68.00 1.3% 23.8% 583.53.56 51.14.41 579.45 38 Concrete pawement, reinforcing steel for rigid pawing, 12 bs, fs' 579.64 51.38 68.00 1.3% 23.8% 583.53.56 51.14.41 579.45 579.64 51.38 68.00 1.3% 52.08 51.38 52.08 52.08 52.08 51.38 52.08 52.			1	LS	\$48,112	21.3%	23.8%	\$72,227	\$96,813	
37 Concrete pawement, 4500 psi, fixed form, unreinforced, 12° pass, 6" thick, includes joints, finishing, and curing 38 Concrete pawement, reinforing steel for rigid paving, 12 bs/57 1340, 05.7 13			1	LS						
38 Concrete pawement, reinforcing steel for rigid pawing, 12 lbs/SY 144.00 SY 51,384 68 21.3% 23.8% 52,078.71 52,786 513.33 40 Sidewalks, driveways, and patios, sidewalk, concrete, cast-in-place with 6 x 6 - W1.4 x W1.4 mesh, broomed finish, 3,312.00 SF \$20,627.40 21.3% 23.8% \$30,966.37 \$41,507 \$12.53 41 Note: Curbs Curbs Spatial Concrete, cast-in-place with 6 x 6 - W1.4 x W1.4 mesh, broomed finish, 3,312.00 SF \$20,627.40 21.3% 23.8% \$30,966.37 \$41,507 \$12.53 42 Cast-in-place concrete curbs & gutters, concrete, machine formed, 6"x 18", includes concrete 28.200 LF \$31,335 21.3% 23.8% \$5,760.68 \$6,388 \$52,265 42 Painted pawement markings, write or yellow, 4" wide 3,000.00 LF \$31,335 21.3% 23.8% \$2,005 \$5,287 43 Painted pawement markings, write or yellow, arrows or handicap 300.00 LF \$34,914 21.3% 23.8% \$22,005 \$5,287 44 Indicationing allowance 2,272.00 SF \$48,617 21.3% 23.8% \$729.98 \$579.85 \$578 \$3.24 45 Indicationing allowance 2,272.00 SF \$13,504 21.3% 23.8% \$52,805 \$50,405				6.14						470.45
39 Note: Sidewalks 0.00 5.00 0.0% 0.0% 5.00 5.0 5.0										
3,000 psi, 5" hick, excludes base				5.11						Ų13.55
41 Note: Curbs 20		Sidewalks, driveways, and patios, sidewalk, concrete, cast-in-place with 6 x 6 - W1.4 x W1.4 mesh, broomed finish,	3,312.00	S.F.	\$20,627.40	21.3%	23.8%	\$30,966.37	\$41,507	\$12.53
APACEMENT STRIPING		Note: Curbs								
44 Painted pavement markings, acrylic waterborne, white or yellow, 4" wide 3,000.00 LF. \$849.14 21.3% 23.8% \$1,274.74 \$1,709 \$0.55 45 Painted pavement markings, white or yellow, arrows or handicap 300.00 SF. \$486.17 21.3% 23.8% \$52,2875 \$32,003 46 LANDSCAPING ADD IRRIGATION 1 LS \$15,904 21.3% 23.8% \$23,875 \$32,003 47 Landscaping allowance 2,272.00 SF. \$11,360.00 21.3% 23.8% \$17,053.92 \$22,859 \$10.00 48 Irrigation allowance 2,272.00 SF. \$45,440 02.13% 23.8% \$60,435 \$81,007 49 LIQUID AND GAS SITE UTILITIES 1 LS \$40,257 21.3% 23.8% \$60,435 \$81,007 50 Note: Excavation & Backfill - 1651 \t			282.00							\$22.65
45 Sainted pavement markings, white or yellow, arrows or handicap 300,00 S.F. \$486.17 21.38 23.88 \$772.85 \$32,003 47 LandSCAPING AND IRRIGATION 1 LS \$15,904 21.38 23.88 \$73.875 \$32,003 48 Irrigation allowance 2,272.00 S.F. \$11,360,00 21.38 23.88 \$50,3875 \$32,003 49 LuQID AND GAS SITE UTILITIES 1 LS \$40,275 21.38 23.88 \$60,435 \$81,007 50 Notice Excavation & Backfill 155°L x 4°W x 10°D 0.00 \$0.00 0.0% \$0.00 0.0% \$0.00 \$0.00 51 Excavationity greech or continuous footing, common earth, 3/4 CY, excavator, to 14' deep 48.89 B.C.Y. \$11,1260 21.38 23.88 \$1,670.26 \$52.23 \$545.75 52 Sackfill, haul from existing stockpile, excludes compaction 63.56 L.C.Y. \$846.86 21.3% 23.8% \$5,621.35 \$51,004 \$26.88 53 Compaction, vibrating plate 63.56 L.C.Y. \$176.88 21.38 23.85 \$545.74 \$55.64 54 Fill, gravel embed in pipe trench, compacted, to 9" deep 149.00 S.F. \$2,765.49 21.38 23.88 \$415.15 \$55.65 \$57.75 55 Note: Domestic water main 2-1/2" 50.00 50.00 50.00 50.00 50.00 50.00 50 Water supply distribution pliping, copper tubing, 20' joints, 2-1/2" diameter, type K, excludes excavation or backfill 150.00 L.F. \$5,181.20 21.38 23.88 \$377.81 \$10.426 \$63.14 \$10.426 \$1.38 \$2.88 \$373.92 \$50.10 \$1.28			2,000,00							ć0 F7
47 LANDSCAPING AND IRRIGATION 47 Landscaping allowance 2,272.00 S.F. 511,360.00 21.3% 23.8% 517,033.92 522,859 \$10.00 48 Irrigation allowance 2,272.00 S.F. 511,360.00 21.3% 23.8% 55,821.57 59,142 \$4.00 49 LIQUID AND GAS SITE UTILITIES 1 LS \$40,257 21.3% 23.8% 56,0435 \$81,007 50 Note: Excavation, 8 Backfill. 1:65't. x3 'wx. 4'0 50't. x4 'wx. 10'D 0.00 \$5.00 0.0% 0.0% 0.0% 50.00 \$5.0 51 Excavating, trench or continuous footing, common earth, 3/4 C.Y. excavator, to 14' deep 48.89 B.C.Y. \$1,112.60 21.3% 23.8% \$1,670.26 \$2,239 \$45.79 52 Backfill, haul from existing stockplie, excludes compaction 63.56 L.C.Y. \$486.86 21.3% 23.8% \$1,271.33 \$1,704 \$25.88 53 Compaction, vibrating plate 63.56 L.C.Y. \$468.86 21.3% 23.8% \$415.15 \$55.6 54 Fill, gravel embed in pipe trench, compacted, to 9' deep 149.00 S.F. \$276.54 21.3% 23.8% \$415.15 \$55.6 53.77 55 Note: Domestic water main 2-1/2" 0.00 0.00 0.00 0.0% 0.00 0.0% 0.00 0.0% 50.00 55 Water supply distribution piping, copper tubing, 20' joints, 2-1/2" diameter, type K, excludes excavation or backfill 165.00 L.F. \$518.12 21.3% 23.8% \$23.8% \$23.37.92 \$50.1 58 Water supply meter, detector, serves dual systems such as fire and domestic or process water, wide range capacity, 400 GFM, 3' mainline x 2' by-pass, Ut and FM approved 59 Water supply meter, detector, serves dual systems such as fire and domestic or process water, wide range capacity, 400 GFM, 3' mainline x 2' by-pass, Ut and FM approved 59 Water supply meter, detector, serves dual systems such as fire and domestic or process water, wide range capacity, 400 GFM, 3' mainline x 2' by-pass, Ut and FM approved 50 Water supply meter, detector, serves dual systems such as fire and domestic or process water, wide range capacity, 400 GFM, 3' mainline x 2' by-pass, Ut and FM approved 50 Water supply meter, detector, serves dual systems such as fire and domestic or process water, wide range capacity, 400 GFM, 3' mainline x 2' by-pass, Ut and FM approved 50 Water supply meter, detector, serves dual systems such as fire and domestic or			_							
48 LIQUID AND GAS SITE UTILITIES 1			1							73.20
1							23.8%	\$17,053.92	\$22,859	\$10.06
50 Note: Excavation & Backfill - 165'L x3'W x 4'D 50'L x 4'W x 10'D 51 Excavating, trench or continuous footing, common earth, 3/4 C.Y. excavator, to 14' deep 48.89 B.C.Y. 51,112.60 21.3% 23.8% 51,670.26 52,239 \$45.75 52 Backfill, flush ulfrom existing stockpile, excludes compaction 53 Compaction, vibrating plate 53 Compaction, vibrating plate 53 Compaction, vibrating plate 54 September 1990 September			2,272.00							\$4.02
Sizeavating, trench or continuous footing, common earth, 3/4 C.Y. excavator, to 14' deep 48.89 B.C.Y. \$1,112.60 21.3% 23.8% \$1,670.26 \$2,239 \$45.75 \$25 Backfill, haul from existing stockpile, excludes compaction 63.56 L.C.Y. \$484.86 21.3% 23.8% \$1,271.33 \$1,704 \$26.81 \$35.60 \$35.60 \$35.60 \$1.60 \$1.20			1	LS						
52 Backfill, haul from existing stockpile, excludes compaction 63.56 L.C.Y. \$846.86 21.3% 23.8% \$1,271.33 \$1,704 \$26.85 \$1,271.33 \$1,2704 \$1,275				BCV						\$45.70
53 Compaction, vibrating plate 63.56 E.C.Y. \$176.85 21.3% 23.8% \$265.49 \$356 \$5.60 54 Fill, gravel embed in pipe trench, compacted, to 9" deep \$356 \$5.60 55 Note: Domestic water main 2-1/2" 0.00 \$0.00 0.0% \$0.00 \$0.00 50 0.0% \$0.00 \$0.00 \$0.00 50 0.0% \$0.00 \$0.00 \$0.00 50 0.0% \$0.00 \$0.00 \$0.00 50 0.0% \$0.00 \$0.00 \$0.00 50 0.0% \$0.00 \$0.00 \$0.00 50 0.0% \$0.00 \$0.00 \$0.00 50 0.0% \$0.00 \$0.00 \$0.00 50 0.0% \$0.00 \$0.00 \$0.00 50 0.0% \$0.00 \$0.00 \$0.00 50 0.0% \$0.00 \$0.00 50 0.0% \$0.00 \$0.00 \$0.00 50 0.0% \$0.00 \$0.00 50 0.0% \$0.00 \$0.00 50 0.0% \$0.00 \$0.00 50 0.0% \$0.00 \$0.00 50 0.0% \$0.00 \$0.00 50 0.0% \$0.00 \$0.00 50 0.0% \$0.00 \$0.00 50 0.0% \$0.00 \$0.00 50 0.0% \$0.00 \$0.00 50 0.0% \$0.00 \$0.00 50 0.0% \$0.00 \$0.00 50 0.0% \$0.00 \$0.00 50 0.0% \$0.00 \$0.00 50 0.0% \$0.00 50 0.0% \$0.00 \$0.00 50 0.0% \$0.00 50										\$26.81
55 Mote: Domestic water main 2-1/2" 0.00 \$0.00 0.0% 50.00 \$0.00								\$265.49		\$5.60
Section Sect				S.F.						\$3.73
57 Valves, bronze, ball, 150 lb., 2-1/2", soldered 1.00 Ea. \$249.08 21.3% 23.8% \$373.92 \$501				1.5						ćc2 10
58 Water supply meter, detector, serves dual systems such as fire and domestic or process water, wide range capacity, 400 GPM, 3" mainline x.2" by-pass, UL and FM approved 9 Water supply meter, detector, serves dual systems such as fire and domestic or process water, wide range capacity, 400 GPM, 3" mainline x.2" by-pass, UL and FM approved 1.00 Ea. \$2,605.53 21.3% 23.8% \$3,911.48 \$5,243 \$60 Backflow preventer, reduced pressure principle, bronze, automatic operation, OS&Y valves, flanged, 2-1/2" pipe size, includes valves and four test cocks filterior domestic water service piping, copper, tubing, solder, 2-1/2" diameter, type L, includes coupling & clevis 1.00 Ea. \$1,874.94 21.3% 23.8% \$7,934.77 \$10,636 includes valves and four test cocks filterior domestic water service piping, copper, tubing, solder, 2-1/2" diameter, type L, includes coupling & clevis 1.00 Ea. \$1,874.94 21.3% 23.8% \$2,814.71 \$3,773 hanger assembly 10' OC \$0.00 0.00 0.00 0.00 0.00 \$0.00										\$63.19
59 Water supply meter, domestic/commercial, bronze, threaded/flanged, 2-1/2" diameter 60 Backflow preventer, reduced pressure principle, bronze, automatic operation, OS&Y valves, flanged, 2-1/2" pipe size, includes valves and flour test cocks. 61 Interior domestic water service piping, copper, tubing, solder, 2-1/2" diameter, type L, includes coupling & clevis 61 Interior domestic water service piping, copper, tubing, solder, 2-1/2" diameter, type L, includes coupling & clevis 62 Note: Natural gas main 1-1/2" 63 Natural gas piping, service & distribution, bimodal yellow MDPE, pipe, SDR 11, 80psi, 500ft coils, IPS, 1-1/2" dia, ASTM D2513, PE 2406/PE2708, socket fusion coupling @ 100ft, excludes excavation & backfill 64 Natural gas metering, risers, fixed, anodeless, MDPE x epoxy CS, SDR 11, 125 psi, 1-1/2" IPS x 1-1/2" MPT, 36" x 26", fusion joints, ASTM D2513/F1973, excluding excavation & backfill, no cathodic protection required 65 Sleeve, pipe, steel with water stop, 12" long, a" diam. for 1-1/2" carrier pipe, includes link seal 66 Natural gas metering, lubricated semi-steel plug valve, 1-1/2" diameter, excludes excavation or backfill 76 Natural gas metering, lubricated semi-steel plug valve, 1-1/2" diameter, excludes excavation or backfill 77 Meter, gas, commercial: 1-1/2", 1-1/2" pipe size 78 Substance Scandal Sca		Water supply meter, detector, serves dual systems such as fire and domestic or process water, wide range capacity,								
60 Backflow preventer, reduced pressure principle, bronze, automatic operation, OS&Y valves, flanged, 2-1/2" pipe size, includes valves and four test cocks 61 Interior domestic water service piping, copper, tubing, solder, 2-1/2" diameter, type L, includes coupling & clevis 1.00 Ea. \$1,874.94 21.3% 23.8% \$2,814.71 \$3,773 hanger assembly 10' OC 62 Note: Natural gas main 1-1/2" 63 Natural gas piping, service & distribution, bimodal yellow MDPE, pipe, SDR 11, 80psi, 500ft coils, IPS, 1-1/2" dia, ASTM D2513, PE 2406/PE2708, socket fusion coupling @ 100ft, excludes excavation & backfill 64 Natural gas metering, risers, fixed, anodeless, MDPE x epoxy CS, SDR 11, 125 psi, 1-1/2" IPS x 1-1/2" MPT, 36" x 26", fusion pionts, ASTM D2513/F1973, excluding executation & backfill, no cathodic protection required 65 Sleeve, pipe, steel with water stop, 12" long, 4" diam. for 1-1/2" carrier pipe, includes link seal 66 Natural gas metering, insertated semi-steel plug valve, 1-1/2" diameter, excludes excavation or backfill 76 Meter, gas, commercial-11/2", 1-1/2" pipe size 1.00 Ea. \$3,06.68 21.3% 23.8% \$449.05 \$602.00 23.8% \$5,429.76 \$5,7278	59		1.00	Ea.	\$2.605.53	21.3%	23.8%	\$3.911.48	\$5.243	
includes valves and four test cocks 61 Interior domestic water service piping, copper, tubing, solder, 2-1/2" diameter, type L, includes coupling & clevis hanger assembly 10' OC 62 Note: Natural gas main 1-1/2" 63 Natural gas piping, service & distribution, bimodal yellow MDPE, pipe, SDR 11, 80psi, 500ft coils, IPS, 1-1/2" dia, ASTM D2513, PE 2406/PE2708, socket fusion coupling @ 100ft, excludes excavation & backfill 64 Natural gas metering, risers, fixed, anodeless, MDPE x epoxy CS, SDR 11, 127 PS x 1-1/2" MPT, 36" x 26", fusion joints, ASTM D2513/F1973, excluding excavation & backfill, no cathodic protection required 65 Sleeve, pipe, steel with water stop, 12" long, 4" diam. for 1-1/2" carrier pipe, includes link seal 66 Natural gas metering, lubricated semi-steel plug valve, 1-1/2" diameter, excludes excavation or backfill 1.00 Ea. \$308.24 21.3% 23.8% \$440.05 \$67 Meter, gas, commercial: 1,1/2", 1,1/2" pipe size 1.00 Ea. \$336.688 21.3% 23.8% \$549.05 \$602 67 Meter, gas, commercial: 1,1/2", 1,1/2" pipe size 1.00 Ea. \$336.688 21.3% 25.8% \$54.90.76 \$7.778										
hanger assembly 10' OC		includes valves and four test cocks								
63 Natural gas piping, service & distribution, bimodal yellow MDPE, pipe, SDR 11, 80psi, 500ft coils, IPS, 1-1/2" dia, ASTM D2513, PE 2406/PEZ708, socket fusion coupling @ 100ft, excludes excavation & backfill of Natural gas metering, risers, fixed, anodeless, MDPE x epoxy CS, SDR 11, 125 psi, 1-1/2" IPS x 1-1/2" MPT, 36" x 26", fusion joints, ASTM D2513/F1973, excluding excavation & backfill, no cathodic protection required 65 Sleeve, pipe, steel with water stop, 12" long, 4" diam. for 1-1/2" carrier pipe, includes link seal 1.00 Ea. \$308.24 21.3% 23.8% \$460.74 \$620 66 Natural gas metering, lubricated semi-steel plug valve, 1-1/2" diameter, excludes excavation or backfill 1.00 Ea. \$308.24 21.3% 23.8% \$449.05 \$602 67 Meter, gas, commercial: 1-1/2", 1-1/2" pipe size 1.00 Ea. \$3,361.688 21.3% 23.8% \$5,429.76 \$7,778		hanger assembly 10' OC								
D2513, PE 2406/PE2708, socket fusion coupling @ 100ft, excludes excavation & backfill 64 Natural gas metering, risers, fixed, anotdeless, MDPE x epoxy CS, SDR 11, 125 psi, 1-1/2" IPS x 1-1/2" MPT, 36" x 26", fusion joints, ASTM D2513/F1973, excluding excavation & backfill, no cathodic protection required 56 Sleeve, pipe, steel with water stop, 12" long, 4" diam. for 1-1/2" carrier pipe, includes link seal 1.00 Ea. \$308.24 21.3% 23.8% \$462.74 \$620 66 Natural gas metering, lubricated semi-steel plug valve, 1-1/2" diameter, excludes excavation or backfill 1.00 Ea. \$299.12 21.3% 23.8% \$49.05 \$602 67 Meter, gas, commercial-11/2", 1-1/2" pipe size 1.00 Ea. \$3,616.88 21.3% 23.8% \$5,429.76 \$7,278										4
fusion joints, ASTM D2513/F1973, excluding excavation & backfill, no cathodic protection required 65 Sleeve, pipe, steel with water stop, 12" long, 4" diam. for 1-1/2" carrier pipe, includes link seal 1.00 Ea. \$308.24 21.3% 23.8% \$462.74 \$620 66 Natural gas metering, lubricated semi-steel plug valve, 1-1/2" diameter, excludes excavation or backfill 1.00 Ea. \$3,616.88 21.3% 23.8% \$449.05 \$602 67 Meter, gas, commercial: 1-1/2", 1-1/2" pipe size 1.00 Ea. \$3,616.88 21.3% 23.8% \$5,429.76 \$7,278		D2513, PE 2406/PE2708, socket fusion coupling @ 100ft, excludes excavation & backfill								\$7.87
66 Natural gas metering, lubricated semi-steel plug valve, 1-1/2" diameter, excludes excavation or backfill 1.00 Ea. \$299.12 21.3% 23.8% \$449.05 \$602 67 Meter, gas, commercial1-1/2", 1-1/2" pipe size 1.00 Ea. \$3,616.88 21.3% 23.8% \$5,429.76 \$7,278		fusion joints, ASTM D2513/F1973, excluding excavation & backfill, no cathodic protection required							·	
67 Meter, gas, commercial1-1/2" , 1-1/2" pipe size 1.00 Ea. \$3,616.88 21.3% 23.8% \$5,429.76 \$7,278										
					\$3,616.88	21.3%	23.8%	\$3,035.52	\$7,278 \$4,069	

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Delivery Method: CMAR Estimate Type: AACEi Class 4 WBS: Component/Uniformat

	Saginaw Keeter Bldg F	Reno Cor	ncept						
						Prime	Total	ECC	ECC Unit
Line #	Description	Qty.	UoM	Subtotal	Sub %	%	Direct Cost	w/Escalation	Cost
69	ELECTRICAL SITE IMPROVEMENTS	1	LS	\$90,684	21.3%	23.8%	\$136,137	\$182,478	
	Grounding rod, copper clad, 8' long, 3/4" diameter	9.00	Ea.	\$1,125.01	21.3%	23.8%	\$1,688.90	\$2,264	\$251.53
	Exothermic weld, cadweld exothermic welding kit, multi vertical Copper electrolytic ground rod system, L-shaped, 2" diameter, 4' vertical x 10' horizontal, incl exothermic weld	9.00	Ea. Ea.	\$10,640.22 \$5,252.16	21.3% 21.3%	23.8%	\$15,973.37 \$7,884.67	\$21,411 \$10,569	\$2,378.97 \$3,522.87
, _	connection	5.00		Ų3,232.10	21.570	25.070	ψ,,οο,	\$10,503	ψ3,322.07
	Insulated ground wire, copper, stranded, #4	10.00	C.L.F.	\$2,336.04	21.3%	23.8%	\$3,506.93	\$4,701	\$470.07
	Ground wire, copper wire, bare solid, #6	10.00	C.L.F.	\$1,322.62	21.3%	23.8%	\$1,985.56	\$2,661	\$266.14
	Trench duct, steel with cover, standard adjustable, straight, single compartment, depths to 4", 24" wide Rigid galvanized steel conduit, 4" diameter, to 10' high, includes 11 couplings per 100'	75.00 150.00	L.F.	\$53,647.38 \$8,236.46	21.3% 21.3%	23.8% 23.8%	\$80,536.80 \$12,364.78	\$107,952 \$16,574	\$1,439.35 \$110.49
	Wire, copper, stranded, 600 volt, 500 kcmil, type THWN-THHN, normal installation conditions in wireway, conduit,	4.50	C.L.F.	\$6,607.73	21.3%	23.8%	\$9,919.70	\$13,296	\$2,954.75
	cable tray								
78	Wire, copper, stranded, 600 volt, 250 kcmil, type THWN-THHN, normal installation conditions in wireway, conduit,	1.60	C.L.F.	\$1,516.21	21.3%	23.8%	\$2,276.17	\$3,051	\$1,906.86
79	cable tray	1	LS	\$2,197,106	21.3%	22 00/	¢2 200 2E1	¢4 421 112	
80	BUILDING SUBSTRUCTURE	1	LS	\$39,401	21.3%	23.8%	\$3,298,351 \$59,150	\$4,421,112 \$79,285	
81	DEEP FOUNDATIONS	1,003	S.F.	\$39,401	21.3%	23.8%	\$59,150	\$79,285	\$79.05
	Note: Excavation & Grading	0.00	3.1.	\$0.00	0.0%	0.0%	\$0.00	\$13,283	Ş79.03
	Excavating, trench or continuous footing, common earth, 1/2 C.Y. excavator, 4' to 6' deep, excludes sheeting or	14.84	B.C.Y.	\$105.85	21.3%	23.8%	\$158.91	\$213	\$14.35
	dewatering								
	Borrow, common earth, 1 C.Y. bucket, loading and/or spreading, shovel	14.84	B.C.Y.	\$359.09	21.3%	23.8%	\$539.08	\$723	\$48.68
85	Cycle hauling (wait, load, travel, unload or dump & return) time per cycle, excavated or borrow, loose cubic yards, 15	19.76	L.C.Y.	\$140.96	21.3%	23.8%	\$211.62	\$284	\$14.36
86	min load/wait/unload, 20 C.Y. truck, cycle 20 miles, 40 MPH, excludes loading equipment Disposal Fees	19.76	L.C.Y.	\$395.18	21.3%	23.8%	\$593.26	\$795	\$40.24
87	Fine grading, fine grade for slab on grade, machine	111.43	S.Y.	\$242.11	21.3%	23.8%	\$363.46	\$487	\$4.37
	Note: Drilled Piers	0.00		\$0.00	0.0%	0.0%	\$0.00	\$0	
	Fixed end caisson piles, for mobilization, 50 mile radius, rig to 36"	1.00	Ea.	\$1,707.95	21.3%	23.8%	\$2,564.02	\$3,437	ĆE 4 00
90	Fixed end caisson piles, open style in stable ground, to 50' deep, 18" diameter, 0.065 CY/LF, machine drilled, includes excavation, concrete, 50 lb. reinforcing/C.Y., excludes mobilization, boulder removal, disposal, casings or ground water	300.00	V.L.F.	\$8,196.78	21.3%	23.8%	\$12,305.21	\$16,494	\$54.98
91	Fixed end caisson piles, for rock excavation, sockets, add, average	53.00	C.F.	\$5,283.00	21.3%	23.8%	\$7,930.97	\$10,631	\$200.58
	Fixed end caisson piles, for other than 50 lb. reinforcing per C.Y., add or deduct	975.00	Lb.	\$1,176.46	21.3%	23.8%	\$1,766.13	\$2,367	\$2.43
	Fixed end caisson piles, load and haul excess excavation, 2 miles	20.00	L.C.Y.	\$204.96	21.3%	23.8%	\$307.69	\$412	\$20.62
	Fixed end caisson piles, bottom inspection, add Note: Grade Beams	6.00 0.00	Ea.	\$2,591.57 \$0.00	21.3%	23.8%	\$3,890.53 \$0.00	\$5,215 \$0	\$869.15
	C.I.P. concrete forms, grade beam, plywood, 1 use, includes erecting, bracing, stripping and cleaning	100.30	SFCA	\$1,158.57	21.3%	23.8%	\$1,739.28	\$2,331	\$23.24
	Reinforcing steel, in place, beams and girders, #3 to #7, A615, grade 60, incl labor for accessories, excl material for	1.11	Ton	\$2,720.60	21.3%	23.8%	\$4,084.23	\$5,475	\$4,917.24
	accessories								
98	Structural concrete, ready mix, heavyweight, 4000 psi, includes local aggregate, sand, Portland cement (Type I) and	14.84	C.Y.	\$2,717.05	21.3%	23.8%	\$4,078.90	\$5,467	\$368.31
90	water, delivered, excludes all additives and treatments Structural concrete, placing, grade beam, pumped, includes leveling (strike off) & consolidation, excludes material	14.84	C.Y.	\$330.31	21.3%	23.8%	\$495.87	\$665	\$44.78
	Note: 8" Slab-On-Grade	0.00	C.11.	\$0.00	0.0%	0.0%	\$0.00	\$0	Ş-14.70
101	C.I.P. concrete forms, slab on grade, edge, wood, 7" to 12" high, 4 use, includes erecting, bracing, stripping and	26.78	SFCA	\$145.94	21.3%	23.8%	\$219.08	\$294	\$10.97
	cleaning								
102	Reinforcing steel, in place, beams and girders, #3 to #7, A615, grade 60, incl labor for accessories, excl material for	2.51	Ton	\$6,127.48	21.3%	23.8%	\$9,198.73	\$12,330	\$4,917.24
103	Structural concrete, ready mix, heavyweight, 4000 psi, includes local aggregate, sand, Portland cement (Type I) and	24.77	C.Y.	\$4,534.53	21.3%	23.8%	\$6,807.36	\$9,125	\$368.31
	water, delivered, excludes all additives and treatments			, ,			,	, . ,	
104	Structural concrete, placing, elevated slab, pumped, 6" to 10" thick, includes leveling (strike off) & consolidation,	24.77	C.Y.	\$619.39	21.3%	23.8%	\$929.85	\$1,246	\$50.31
105	excludes material	1 002 00	c r	Ć402.47	24 20/	22.00/	¢c04.30	Ć010	Ć0.01
105	Concrete finishing, specified Random Access Floors ACI Classes 1, 2, 3 & 4, for Composite Overall Floor Flatness & Levelness to FF35/FL25, power screed, bull float, machine float & steel trowel (ride-on), excl placing, striking off &	1,003.00	S.F.	\$402.47	21.3%	23.8%	\$604.20	\$810	\$0.81
	consolidating								
106	Concrete surface treatment, curing, sprayed membrane compound	10.03	C.S.F.	\$241.01	21.3%	23.8%	\$361.81	\$485	\$48.35
107	SHELL	1	LS	\$205,356	21.3%	23.8%	\$308,285	\$413,225	
108	SUPERSTRUCTURE	1	LS	\$58,012	21.3%	23.8%	\$87,089	\$116,734	
109	STRUCTURAL STEEL FRAMING	7.50		\$46,019	21.3%	23.8%	\$69,085	\$92,602	\$12,346.90
110	Structural steel project, A992 steel, shop fabricated, incl shop primer	7.50	Ton	\$46,019.17	21.3%	23.8%	\$69,085.13	\$92,602	\$12,346.90
111	ROOF DECK Metal roof decking, steel, open type B wide rib, galvanized, under 50 Sq, 1-1/2" D, 18 gauge	1,003 1,003.00	S.F.	\$ 6,368 \$6,367.69	21.3% 21.3%	23.8%	\$9,559 \$9,559.33	\$12,813 \$12,813	\$12.78 \$12.78
113	DUNNAGE	1,003.00	LS	\$3,625	21.3%	23.8%	\$5,442	\$7,294	J12./0
	Note: Existing Roof Steel Reinforcement	0.00		\$0.00	0.0%	0.0%	\$0.00	\$0	
115	Dunnage allowance	0.50		\$3,625.00	21.3%	23.8%	\$5,441.94	\$7,294	\$14,588.76
116	ROOF TIE-IN	1		\$2,000		23.8%	\$3,002	\$4,024	
	Roof tie-in at library and addition	1.00	LS	\$2,000.00	21.3%	23.8%	\$3,002.45	\$4,024	
118 119	EXTERIOR VERTICAL ENCLOSURES CMU WALL	1,023	LS S.F.	\$91,843 \$37,931	21.3% 21.3%	23.8%	\$137,877 \$56,942	\$184,811 \$76,326	\$74.61
113	CITIO VVALL	1,023	C.S.F.	\$1,908.38	21.3%	23.8%	\$2,864.91	\$ 76,326 \$3,840	\$375.38
120	Scaffolding, steel tubular, regular, labor only to erect & dismantle, building exterior, wall face, 6'-4" x 5' frames 1 to 5		1	, _,,500.50	_1.570	_5.570	,0051	\$3,040	25, 5,50
	Scaffolding, steel tubular, regular, labor only to erect & dismantle, building exterior, wall face, 6'-4" x 5' frames, 1 to 5 stories, excludes planks	10:25							\$192.61
	stories, excludes planks Scaffolding, steel tubular, regular, rent/month only for complete system for face of walls, 6' -4" x 5' frames, excludes	10.23	C.S.F.	\$979.21	21.3%	23.8%	\$1,470.02	\$1,970	
121	stories, excludes planks Scaffolding, steel tubular, regular, rent/month only for complete system for face of walls, 6'-4" x 5' frames, excludes planks	10.23							
121	stories, excludes planks Scaffolding, steel tubular, regular, rent/month only for complete system for face of walls, 6' -4" x 5' frames, excludes planks Concrete block, exterior, tooled joints both sides, normal weight, 2000 psi, 12" x 8" x 16", includes mortar and		C.S.F.	\$979.21 \$16,832.15	21.3%	23.8%	\$1,470.02	\$1,970 \$33,870	
121	stories, excludes planks Scaffolding, steel tubular, regular, rent/month only for complete system for face of walls, 6'-4" x 5' frames, excludes planks	10.23							\$33.11
121 122 123	stories, excludes planks Scaffolding, steel tubular, regular, rent/month only for complete system for face of walls, 6'-4" x 5' frames, excludes planks Concrete block, exterior, tooled joints both sides, normal weight, 2000 psi, 12" x 8" x 16", includes mortar and horizontal joint reinforcing every other course, excludes scaffolding, grout and vertical reinforcing Concrete block, bond beam, normal weight, 2000 psi, 12" x 8" x 16", includes mortar, excludes scaffolding, horizontal reinforcing, vertical reinforcing and grout	10.23 1,023.00 40.92	S.F. L.F.	\$16,832.15 \$497.41	21.3%	23.8%	\$25,268.85	\$33,870 \$1,001	\$33.11 \$24.46
121 122 123	stories, excludes planks Scaffolding, steel tubular, regular, rent/month only for complete system for face of walls, 6'-4" x 5' frames, excludes planks Concrete block, exterior, tooled joints both sides, normal weight, 2000 psi, 12" x 8" x 16", includes mortar and horizontal joint reinforcing every other course, excludes scaffolding, grout and vertical reinforcing Concrete block, bond beam, normal weight, 2000 psi, 12" x 8" x 16", includes mortar, excludes scaffolding, horizontal reinforcing, vertical reinforcing and grout Masonry reinforcing bars, #5 and #6 reinforcing steel bars, placed vertically, ASTM A615	10.23 1,023.00 40.92 239.18	S.F. L.F.	\$16,832.15 \$497.41 \$380.40	21.3% 21.3% 21.3%	23.8% 23.8% 23.8%	\$25,268.85 \$746.73 \$571.07	\$33,870 \$1,001 \$765	\$33.11 \$24.46 \$3.20
121 122 123 124 125	stories, excludes planks Scaffolding, steel tubular, regular, rent/month only for complete system for face of walls, 6'-4" x 5' frames, excludes planks Concrete block, exterior, tooled joints both sides, normal weight, 2000 psi, 12" x 8" x 16", includes mortar and horizontal joint reinforcing every other course, excludes scaffolding, grout and vertical reinforcing Concrete block, bond beam, normal weight, 2000 psi, 12" x 8" x 16", includes mortar, excludes scaffolding, horizontal reinforcing, vertical reinforcing and grout Massonry reinforcing bars, #5 and #6 reinforcing steel bars, placed vertically, ASTM A615 Masonry reinforcing bars, #5 and #6 reinforcing steel bars, placed horizontally, ASTM A615	10.23 1,023.00 40.92 239.18 444.19	S.F. L.F. Lb. Lb.	\$16,832.15 \$497.41 \$380.40 \$641.40	21.3% 21.3% 21.3% 21.3%	23.8% 23.8% 23.8% 23.8%	\$25,268.85 \$746.73 \$571.07 \$962.88	\$33,870 \$1,001 \$765 \$1,291	\$33.11 \$24.46 \$3.20 \$2.91
121 122 123 124 125 126	stories, excludes planks Scaffolding, steel tubular, regular, rent/month only for complete system for face of walls, 6'-4" x 5' frames, excludes planks Concrete block, exterior, tooled joints both sides, normal weight, 2000 psi, 12" x 8" x 16", includes mortar and horizontal joint reinforcing every other course, excludes scaffolding, grout and vertical reinforcing Concrete block, bond beam, normal weight, 2000 psi, 12" x 8" x 16", includes mortar, excludes scaffolding, horizontal reinforcing, vertical reinforcing and grout Masonry reinforcing bars, #5 and #6 reinforcing steel bars, placed vertically, ASTM A615 Grout, bond beams and lintels, 8" deep, 12" thick, 0.30 C.F./L.F., pumped, excludes blockwork	10.23 1,023.00 40.92 239.18 444.19 40.92	S.F. L.F. Lb. Lb. Lb. Lr.	\$16,832.15 \$497.41 \$380.40 \$641.40 \$150.21	21.3% 21.3% 21.3% 21.3% 21.3%	23.8% 23.8% 23.8% 23.8% 23.8%	\$25,268.85 \$746.73 \$571.07 \$962.88 \$225.50	\$33,870 \$1,001 \$765 \$1,291 \$302	\$33.11 \$24.46 \$3.20 \$2.91 \$7.39
121 122 123 124 125 126 127	stories, excludes planks Scaffolding, steel tubular, regular, rent/month only for complete system for face of walls, 6'-4" x 5' frames, excludes planks Concrete block, exterior, tooled joints both sides, normal weight, 2000 psi, 12" x 8" x 16", includes mortar and horizontal joint reinforcing every other course, excludes scaffolding, grout and vertical reinforcing Concrete block, bond beam, normal weight, 2000 psi, 12" x 8" x 16", includes mortar, excludes scaffolding, horizontal reinforcing, vertical reinforcing and grout Massonry reinforcing bars, #5 and #6 reinforcing steel bars, placed vertically, ASTM A615 Masonry reinforcing bars, #5 and #6 reinforcing steel bars, placed horizontally, ASTM A615	10.23 1,023.00 40.92 239.18 444.19	S.F. L.F. Lb. Lb.	\$16,832.15 \$497.41 \$380.40 \$641.40	21.3% 21.3% 21.3% 21.3%	23.8% 23.8% 23.8% 23.8%	\$25,268.85 \$746.73 \$571.07 \$962.88	\$33,870 \$1,001 \$765 \$1,291	\$33.11 \$24.46 \$3.20 \$2.91
121 122 123 124 125 126 127 128	stories, excludes planks Scaffolding, steel tubular, regular, rent/month only for complete system for face of walls, 6'-4" x 5' frames, excludes planks Concrete block, exterior, tooled joints both sides, normal weight, 2000 psi, 12" x 8" x 16", includes mortar and horizontal joint reinforcing every other course, excludes scaffolding, grout and vertical reinforcing Concrete block, bond beam, normal weight, 2000 psi, 12" x 8" x 16", includes mortar, excludes scaffolding, horizontal reinforcing, vertical reinforcing and grout Masonry reinforcing bars, #5 and #6 reinforcing steel bars, placed vertically, ASTM A615 Masonry reinforcing bars, #5 and #6 reinforcing steel bars, placed horizontally, ASTM A615 Grout, bond beams and lintels, 8" deep, 12" thick, 0.30 C.F./L.F., pumped, excludes blockwork Grout, concrete masonry unit (CMU) cores, 12" thick, 0.422 C.F./S.F., pumped, excludes blockwork	10.23 1,023.00 40.92 239.18 444.19 40.92 1,023.00	S.F. L.F. Lb. Lb. LF. S.F. S.F.	\$16,832.15 \$497.41 \$380.40 \$641.40 \$150.21 \$5,701.44	21.3% 21.3% 21.3% 21.3% 21.3% 21.3%	23.8% 23.8% 23.8% 23.8% 23.8% 23.8%	\$25,268.85 \$746.73 \$571.07 \$962.88 \$225.50 \$8,559.15	\$33,870 \$1,001 \$765 \$1,291 \$302 \$11,473	\$33.11 \$24.46 \$3.20 \$2.91 \$7.39 \$11.21







Delivery Method: CMAR Estimate Type: AACEi Class 4 WBS: Component/Uniformat

		Saginaw Keeter Bldg I	Reno Cor	icept						
Section 1965 1975							Prime	Total	ECC	ECC Unit
15 Convent bloom, printing, consult performs and provided performs and performs an	Line #	Description	Qty.	UoM	Subtotal	Sub %	%	Direct Cost	w/Escalation	Cost
Description of Control Activity Control (1997) 1997										\$87.74
10 Control blook, both bloom, percent and applications, designed prices and percent an	131		100.00	S.F.	\$2,336.48	21.3%	23.8%	\$3,507.58	\$4,702	\$47.02
Institution Company	132		4.00	I F	\$62.16	21 3%	23.8%	\$93.31	\$125	\$31 27
100 March production 100	102		1.00	2	\$02.10	21.570	25.070	Ų33.31	Ų123	ψ01.E7
100 100										\$4.26
146 Feet Concent means youth (CMD) corn. 17* Biol. 6212 (7.77 pages) and 15 more with 1. 15 more										
1.0 The New York Service, Proposed, 17, 16, 17, 18, 17, 19, 19, 10, 10, 10, 10, 10, 10, 10, 10, 10, 10										
10 Dec 10 Process 10 Pro										\$19.51
ADM PARKED 1.5										
100 CAT PRINTED 100 CATEGORY 1.10 1.										¢c0.27
STORFERONT 1.39 23.00 53.00 53.00 50.00										
100 100										\$83.38
1-90 100										700.00
15 Sterrifor systems, alternative forms, controlled from the form (1997) 51 51				S.F.						\$83.51
EXTENDED ROOM 1 Es \$1,202 21.79 23.96 55,499 77.70 100										402.54
147 Peners, seel, Intelle Sooms, Intelle Sooms, Commons, steel, Sandel Sooms, Commons, Sandel Sooms, Common			232.00							\$83.51
185 DOCK Configure Configure (1 197			1.00							
MAINTENANCE OF EXTERIORS										
151 Dever wash enterin ACM papers and brick masony 6,25.00 57. 54,883.14 21.34 22.86 53,260.00 52.00			1.00							
122 Dissource for regionsing of traits as needed 4,185.00 57. 51,466.80 2,136 2,236 2,236 2,236 2,236 2,376 5,566 5,168 5,368 5,			1							
150										
STRENOR HORIZONTAL ENCLOSURES 1 15 585,501 21.3% 23.8% 583,319 511,681										
15 PROFING 1,050 5.F. 23,100 21.85 23.85 531,676 542,586 540,000 10.95 PREFAB TRELLS AND CANOPIES 1 15 534,401 21.35 23.85 551,643 569,222 10.000 10.0			1							75.5.
1 1 1 1 1 1 1 1 1 1	155	ROOFING	1,055	S.F.		21.3%	23.8%	\$31,676	\$42,458	\$40.24
158 INTERIOR S 1 15 15 15 15 15 15 1			1,055.00			21.3%				\$40.24
150 Sunthate lowers, aluminum, 30° projection, includes mounting brackets, hardware, outriggers, paint 43.00 17. 527.46.44 21.36 23.86 51.48.48 51.40.56 51.59.7			1	LS						
150 INTERIOR STRUCTION 1				1.5						ć1 202 00
INTERIORS										
Interior Construction			1							Q133.70
164 Partition wall, interior, tandard, laped both sides, installed on 8 incl. 25 ga, NLB metal studs, 3-5/8" wide, 16" Oc. 8" 13,143.00 S.F. \$67,164-70 1.15% \$2.88% \$310,0829.33 \$135,122 \$10.00	162		1						. ,	
Do 12 hgb, 58° gpcsm drywall Si	163	PARTITIONS	13,143	S.F.	\$67,165	21.3%	23.8%	\$100,829	\$135,152	\$10.28
INTERIOR DOORS 37	164		13,143.00	S.F.	\$67,164.70	21.3%	23.8%	\$100,829.33	\$135,152	\$10.28
166 Frames, steel, knock down, hollow metal, soulpte, 15g. a., up to \$-3/4" deep, 3-0" x 0" y 1.00 5a \$15,085.79 21.13% 23.8% \$53,013.20 \$53,000 \$50,000 \$50,000 \$10,000 \$	100				450.004	24 20/	22.00/	4.00.00	4400 -0-	40.740.00
167 Frames, steek, knock down, hollow metal, commercial, skeel, flush, full panel, hollow core, 1-3/8" thick, 20 ga, 31-0" x 7-0" 38.00 5.0 5.58.0 5.778 5.88.0 5.974 5.98.0 5.88.4 5.90.0 5.89.4 5.90.0										
188 Doors, hollow metal, commercial, steef, flush, full panel, hollow core, 1.3/8" thick, 20 ga, 3'.0" x 7'.0" 38.00 Es. \$12,200.00 21.3% 23.8% \$31,940.96 \$26,010 \$588.44 \$1.00										3801.28
170 Door hardware, double, extendro, Ind., paine device 1.00 Pair \$4,692.43 21.3% 23.8% \$5,004.39 \$9,442 \$1.78 \$1.78 \$1.78 \$1.78 \$1.00 \$1.00 \$1.78 \$1.00 \$			38.00						\$26,010	\$684.48
173 Supports for ceiling hung units										\$1,985.26
172 Supports for celling hung units 8.00 fa. \$2,000.00 7.1 38 \$2.88 \$3,00.245 \$4,040 \$50.01 173 Tolet coubles, celling hung, phenoic 8.00 fa. \$1,541.717 2.13 \$2.38 \$2.88 \$21,794.5 \$59.213 \$3,851.6 174 Partitions, tollet, plastic, cubicles, celling hung, for handicap units, add 4.00 fa. \$558.057 2.13 \$2.38 \$2.784.5 \$59.213 \$3,851.6 175 Partitions, tollet, plastic, cubicles, celling hung, for handicap units, add 4.00 fa. \$558.057 2.13 \$2.38 \$571.21 \$51.65 \$59.21 176 Tollet accessories, disperser units, towel disperser & waste receptacle, 18 gallon capacity 4.00 fa. \$52.505.76 2.13 \$2.38 \$571.01 \$5.042 \$1.260.5 177 Tollet accessories, gab bars, straight, stanless steel, 3-10 forg 4.00 fa. \$57.648 2.13 \$2.38 \$3.55.70 \$5.443 \$35.65 178 Tollet accessories, gab bars, straight, stanless steel, 3-2 forg 4.00 fa. \$527.648 2.13 \$2.38 \$3.55.70 \$5.443 \$35.65 179 Tollet accessories, gab bars, straight, stanless steel, 3-2 forg 4.00 fa. \$527.648 2.13 \$2.38 \$3.51.50 \$5555 \$130.0 179 Tollet accessories, sub bars, straight, stanless steel, 3-2 forg 4.00 fa. \$527.648 2.13 \$2.38 \$415.05 \$5555 \$130.0 181 Tollet accessories, barrier and a \$6.00 fa. \$1,521.11 \$1.33 \$2.38 \$2.28 \$415.05 \$5555 \$130.0 181 Tollet accessories, barrier and a \$6.00 fa. \$1,521.11 \$1.33 \$2.38 \$2.28 \$41.50 \$5555 \$130.0 181 Tollet accessories, barrier and a \$6.00 fa. \$1,521.11 \$1.33 \$2.38 \$2.28 \$3.67 \$3.361 \$59.21 181 Tollet accessories, barrier and a \$6.00 fa. \$1,521.11 \$1.33 \$2.38 \$2.28 \$3.67 \$3.361 \$59.21 181 Tollet accessories, barrier and a \$6.00 fa. \$1,521.11 \$1.33 \$2.38 \$2.38 \$1.53.35 \$2.38 \$1.33 \$2.38 \$1.33 \$2.38 \$1.33 \$2.38 \$1.33 \$2.38 \$2.33 \$2.33 \$2.33 \$2.33 \$2.33 \$2.33 \$2.33 \$2.33 \$2.33 \$2.33 \$2.33 \$2.33 \$2.			1.00							
173 Tollet cubicles, celling hung, phenolic 8.00			8.00							\$503.06
174 Partitions, tollet, plastic, cubicles, ceiling hung, for handicap units, add 175 Partitions, tollet, units across new, pollery plastic, cubicles, ceiling hung, for handicap units, and 100 Ea. 54790.5 21.3% 23.8% 5719.15 5964 176 Tollet accessories, grab bars, straight, stainless steel, 1.1/4" (annual real real real real real real real re										\$3,651.66
176 Tollet accessories, given bare, straight, stainess steel, 124" distances x 18" long 4.00 Ea. 52,505.76 21.3% 23.8% \$3,761.71 \$5,042 \$1,260.5 \$178 Tollet accessories, grab bars, straight, stainess steel, 136" long 4.00 Ea. 5276.48 21.3% 23.8% \$415.05 \$555 \$139.0 \$179 Tollet accessories, grab bars, straight, stainless steel, 42" long 4.00 Ea. \$276.48 21.3% 23.8% \$415.05 \$555 \$139.0 \$179 Tollet accessories, grab bars, straight, stainless steel, 42" long 4.00 Ea. \$276.48 21.3% 23.8% \$415.05 \$555 \$139.0 \$179 Tollet accessories, grab bars, straight, stainless steel, 42" long 4.00 Ea. \$276.47 21.3% 23.8% \$415.05 \$555 \$139.0 \$179 Tollet accessories, grab bars, straight, stainless steel, 42" long 4.00 Ea. \$278.47 21.3% 23.8% \$415.05 \$555 \$139.0 \$179 Tollet accessories, grab bars, straight, stainless steel, 42" long 4.00 Ea. \$134.199 21.3% 23.8% \$415.05 \$555 \$139.0 \$179 Tollet accessories, grab bars, straight, stainless steel, 42" long 4.00 Ea. \$1,345.199 21.3% 23.8% \$415.05 \$555 \$139.0 \$180 \$181 Tollet accessories, solid test accessories, stainless steel 42" long 4.00 Ea. \$1,512.12 21.3% 23.8% \$2,283.67 \$3,061 \$51.00 \$181 Tollet accessories, solid test accessories, solid t										\$292.11
177 Toilet accessories, grab bars, straight, stainless steel, 1-1/4" diameter x 18" long 4.00 Ea. 5170.33 21.3% 23.8% 5255.70 5343 585.6 5178 5108t accessories, grab bars, straight, stainless steel, 42" long 4.00 Ea. 5276.48 21.3% 23.8% 5418.04 5560 5140.01 5108 5108 5120 5108 5120 5108 5120 5108 5120 5108 5120 5108 5120 5108 5120 512										4
178 Tollet accessories, grab bars, straight, stainless steel, 36" long										
179 Toilet accessories, grab bars, straight, stainless steel, 42" long										\$139.08
1811 Toilet accessories, sanitary napkin receptacle 5.00 Ea. 51,521.21 21.3% 23.8% 52,283.67 \$3,061 \$512.2 \$12.3% 23.8% 52,283.67 \$3,061 \$512.2 \$12.3% \$2.3% 52.93.7.5 \$3,938 \$492.2 \$183 \$10ilet accessories, toilet seat cover dispenser, stainless steel 8.00 Ea. 51,024.73 21.3% 23.8% 52,937.75 \$3,938 \$492.2 \$257.7 \$184 \$10ilet accessories, soap dispenser, stainless steel, automatic, liquid 8.00 Ea. 51,024.73 21.3% 23.8% 55,457.49 57,315 \$914.4 \$185 \$10 \$15 \$260,750 \$2.336 \$3,938 \$52,062 \$257.7 \$184 \$10ilet accessories, soap dispenser, stainless steel, automatic, liquid 8.00 Ea. 53,655.36 21.3% 23.8% \$53,945 \$524,693 \$73.15 \$914.4 \$15 \$260,750 \$2.336 \$3.934.45 \$524,693 \$73.15 \$914.4 \$15 \$260,750 \$2.336 \$3.934.45 \$524,693 \$73.15 \$914.4 \$15 \$260,750 \$2.336 \$3.934.45 \$524,693 \$73.15 \$914.4 \$15 \$260,750 \$2.336 \$3.934.45 \$524,693 \$301,510 \$187										\$140.09
182 Tollet accessories, tollet seat cover dispenser, stainless steel 8.00 Ea. \$1,956.91 21.3% 23.8% \$2,937.76 \$3,938 \$492.2 \$1,837 \$2,38% \$1,538.35 \$2,062 \$257.7 \$1,87 \$1,000 \$2,000 \$2,000 \$2,000 \$3,000										\$360.19
183 Tollet accessories, tollet tissue dispenser, stainless steel, double roll 8.00 Ea. \$1,024,73 21.3% 23.8% \$1,538.35 \$2,062 \$257.7 184 Tollet accessories, soap dispenser, stainless steel, automatic, liquid 8.00 Ea. \$3,635.36 21.3% 23.8% \$55,457.49 \$73,315 \$914.41 185 INTERIOR FINISHES 1 IS \$260,750 21.3% 23.8% \$391,445 \$5524,693 186 CEILINGS 1 IS \$149,838 21.3% 23.8% \$391,445 \$5524,693 187 Note: Ceiling Tile 0.00 50.00 0.0% 50.00 0.0% 50.00 50.00 187 Note: Geiling File suspended ceilings, fiberglass ceiling board, plain faced, offices, 2' x 2' x 3/4", include standard suspension x,733.00 5.F. \$76,108.48 21.3% 23.8% \$114,255.97 \$153,149 \$19.8 188 Omplete suspended ceiling system, 1-1/2" carrier channels 1,729.00 5.F. \$4,975.20 21.3% 23.8% \$7,468.90 \$10,011 \$5.7 191 Gypsum wallboard, on ceilings, standard, taped & finished (level 4 finish), 5/8" thick 1,729.00 5.F. \$3,159.24 21.3% 23.8% \$4,742.73 \$5,357 \$3.6 193 Allowance - Complete suspended ceilings, siberglass ceiling board, plain faced, offices, 2' x 2' x 3/4", include standard 6,662.00 GSF \$52,930.87 21.3% 23.8% \$7,468.90 \$10,011 \$5.7 194 Note: Ceiling Replacement in City Hall: ACT 0.00 \$0.00 0.0% 0.0% 50.00 50 195 Suspended ceiling system, 1-1/2" carrier channels 0.00 \$0.00										
184 Toilet accessories, soap dispenser, stainless steel, automatic, liquid 8.00 Ea. \$3,635.36 21.3% 23.8% \$5,457.49 \$7,315 \$914.41										
1										\$914.40
187 Note: Ceiling Tile			1		\$260,750	21.3%	23.8%	\$391,445		
188 Complete suspended ceilings, fiberglass ceiling board, plain faced, offices, 2' x 2' x 3/4", include standard suspension ystem, excl. 1-1/2" carrier channels 1,000 5,000 0,0% 5,000	100	CEILINGS		LS					\$301,510	
system, excl. 1-1/2" carrier channels 0.00 \$0.00 0.0% \$0.00							0.0%	\$0.00	\$0	
189 Note: Gypsum	187							Ć114 255 07	C1E2 140	
191 Gypsum wallboard, on ceilings, standard, taped & finished (level 4 finish), 5/8" thick 1,729.00 S.F. \$3,159.24 21.3% 23.8% \$4,742.73 \$6,357 \$3.60	187	Complete suspended ceilings, fiberglass ceiling board, plain faced, offices, 2' x 2' x 3/4", include standard suspension		S.F.				\$114,255.97	\$153,149	\$19.80
192 Note: Ceiling Replacement in City Hall: ACT 193 Allowance - Complete suspended ceilings, fiberglass ceiling board, plain faced, offices, 2' x 2' x 3/4", include standard suspension system, excl. 1-1/2" carrier channels 194 Note: Ceiling Replacement in City Hall: GWB 195 Suspended ceiling system, 1-1/2" carriers, 24" Oc with 1-5/8" channels, 16" OC, incl. carriers 196 Gypsum wallboard, on ceilings, standard, w/compound skim coat (level 5 finish), 5/8" thick 197 FLORING 1 LS 198 Sto,605 199 Note: Carpet 199 Note: Carpet 199 Carpet tile, tufted nylon, hard back, 26 oz., 18" x 18" 200 Note: Tile 201 Ceramic tile, floors, glazed, porcelain type 100 S.F.	187 188 189	Complete suspended ceilings, fiberglass ceiling board, plain faced, offices, 2' x 2' x 3/4", include standard suspension system, excl. 1-1/2" carrier channels Note: Gypsum	7,733.00	S.F.	\$76,108.48	21.3%	23.8%			\$19.80
193 Allowance - Complete suspended ceilings, fiberglass ceiling board, plain faced, offices, 2' x 2' x 3/4", include standard 6,662.00 GSF \$52,930.87 21.3% 23.8% \$79,461.15 \$106,510 \$15.9 suspension system, excl. 1-1/2" carrier channels 194 Note: Ceiling Replacement in City Hall: GWB 0.00 \$0.0	187 188 189 190	Complete suspended ceilings, fiberglass ceiling board, plain faced, offices, 2' x 2' x 3/4", include standard suspension system, excl. 1-1/2" carrier channels Note: Gypsum Suspended ceiling system, 1-1/2" carriers, 24" OC with 7/8" channels, 16" OC, incl. carriers	7,733.00 0.00 1,729.00	S.F.	\$76,108.48 \$0.00 \$4,975.20	21.3% 0.0% 21.3%	23.8% 0.0% 23.8%	\$0.00 \$7,468.90	\$0 \$10,011	\$5.79
suspension system, excl. 1-1/2" carrier channels 0.00 \$0.00 0.0% \$0.00 \$0.0	187 188 189 190 191	Complete suspended ceilings, fiberglass ceiling board, plain faced, offices, 2' x 2' x 3/4", include standard suspension system, excl. 1-1/2" carrier channels Note: Gypsum Suspended ceiling system, 1-1/2" carriers, 24" OC with 7/8" channels, 16" OC, incl. carriers Gypsum wallboard, on ceilings, standard, taped & finished (level 4 finish), 5/8" thick	7,733.00 0.00 1,729.00 1,729.00	S.F.	\$76,108.48 \$0.00 \$4,975.20 \$3,159.24	21.3% 0.0% 21.3% 21.3%	23.8% 0.0% 23.8% 23.8%	\$0.00 \$7,468.90 \$4,742.73	\$0 \$10,011 \$6,357	\$19.80 \$5.79 \$3.68
194 Note: Celling Replacement in City Hall: GWB 0.00 \$0.00 0.0% 0.0% 50.00 \$0.	187 188 189 190 191 192	Complete suspended ceilings, fiberglass ceiling board, plain faced, offices, 2' x 2' x 3/4", include standard suspension system, excl. 1-1/2" carrier channels Note: Gypsum Suspended ceiling system, 1-1/2" carriers, 24" OC with 7/8" channels, 16" OC, incl. carriers Gypsum wallboard, on ceilings, standard, taped & finished (level 4 finish), 5/8" thick Note: Ceiling Replacement in City Hall: ACT	7,733.00 0.00 1,729.00 1,729.00 0.00	S.F. S.F.	\$76,108.48 \$0.00 \$4,975.20 \$3,159.24 \$0.00	21.3% 0.0% 21.3% 21.3% 0.0%	23.8% 0.0% 23.8% 23.8% 0.0%	\$0.00 \$7,468.90 \$4,742.73 \$0.00	\$0 \$10,011 \$6,357 \$0	\$5.79 \$3.68
196 Gypsum wallboard, on ceilings, standard, w/compound skim coat (level 5 finish), 5/8" thick 1,665.00 S.F. \$4,805.74 21.3% 23.8% \$7,214.50 \$9,670 \$5.8 197 FLOORING 1 LS \$50,605 21.3% 23.8% \$7,214.50 \$9,670 \$5.8 198 Note: Carpet 0.00 \$0.00 \$0.00 0.0% \$0.00 <td>187 188 189 190 191 192</td> <td>Complete suspended ceilings, fiberglass ceiling board, plain faced, offices, 2' x 2' x 3/4", include standard suspension system, excl. 1-1/2" carrier channels Note: Sypsum Suspended ceiling system, 1-1/2" carriers, 24" OC with 7/8" channels, 16" OC, incl. carriers Gypsum wallboard, on ceilings, standard, taped & finished (level 4 finish), 5/8" thick Note: Ceiling Replacement in City Hall: ACT Allowance - Complete suspended ceilings, fiberglass ceiling board, plain faced, offices, 2' x 2' x 3/4", include standard</td> <td>7,733.00 0.00 1,729.00 1,729.00 0.00</td> <td>S.F. S.F.</td> <td>\$76,108.48 \$0.00 \$4,975.20 \$3,159.24 \$0.00</td> <td>21.3% 0.0% 21.3% 21.3% 0.0%</td> <td>23.8% 0.0% 23.8% 23.8% 0.0%</td> <td>\$0.00 \$7,468.90 \$4,742.73 \$0.00</td> <td>\$0 \$10,011 \$6,357 \$0</td> <td>\$5.79</td>	187 188 189 190 191 192	Complete suspended ceilings, fiberglass ceiling board, plain faced, offices, 2' x 2' x 3/4", include standard suspension system, excl. 1-1/2" carrier channels Note: Sypsum Suspended ceiling system, 1-1/2" carriers, 24" OC with 7/8" channels, 16" OC, incl. carriers Gypsum wallboard, on ceilings, standard, taped & finished (level 4 finish), 5/8" thick Note: Ceiling Replacement in City Hall: ACT Allowance - Complete suspended ceilings, fiberglass ceiling board, plain faced, offices, 2' x 2' x 3/4", include standard	7,733.00 0.00 1,729.00 1,729.00 0.00	S.F. S.F.	\$76,108.48 \$0.00 \$4,975.20 \$3,159.24 \$0.00	21.3% 0.0% 21.3% 21.3% 0.0%	23.8% 0.0% 23.8% 23.8% 0.0%	\$0.00 \$7,468.90 \$4,742.73 \$0.00	\$0 \$10,011 \$6,357 \$0	\$5.79
197 FLOGRING 1 LS \$50,605 21.3% 23.8% \$75,969 \$101,829 198 Note: Carpet 0.00 \$0.00 0.0% 0.0% 50.00 \$0.00 \$0.00 \$0.00 \$0.00 \$0.00 \$23.8% \$23.8% \$20,399.55 \$27,344 \$38.1 200 Note: Tile 0.00 \$0.00 \$0.00 0.0% 0.0% \$0.00 \$0 201 Ceramic tile, floors, glazed, porcelain type 1,089.00 \$F. \$15,335.27 21.3% 23.8% \$23,01.69 \$30,858 \$28.3 202 Ceramic tile, cove base, thin set, 6" x 4-1/4" h 393.00 LF. \$55,908.94 21.3% 23.8% \$8,870.64 \$11,890 \$30.2 203 Note: VCT 0.00 \$0.00 \$0.00 0.0% 0.0% 50.00 \$0.00	187 188 189 190 191 192 193	Complete suspended ceilings, fiberglass ceiling board, plain faced, offices, 2' x 2' x 3/4", include standard suspension system, excl. 1-1/2" carrier channels Note: Gypsum Suspended ceiling system, 1-1/2" carriers, 24" OC with 7/8" channels, 16" OC, incl. carriers Gypsum wallboard, on ceilings, standard, taped & finished (level 4 finish), 5/8" thick Note: Ceiling Replacement in City Hall: ACT Allowance - Complete suspended ceilings, fiberglass ceiling board, plain faced, offices, 2' x 2' x 3/4", include standard suspension system, excl. 1-1/2" carrier channels Note: Ceiling Replacement in City Hall: GWB	7,733.00 0.00 1,729.00 1,729.00 0.00 6,662.00	S.F. S.F. GSF	\$76,108.48 \$0.00 \$4,975.20 \$3,159.24 \$0.00 \$52,930.87	21.3% 0.0% 21.3% 21.3% 0.0% 21.3% 0.0%	23.8% 0.0% 23.8% 23.8% 0.0% 23.8% 0.0%	\$0.00 \$7,468.90 \$4,742.73 \$0.00 \$79,461.15	\$0 \$10,011 \$6,357 \$0 \$106,510	\$5.79 \$3.68 \$15.99
198 Note: Carpet 0.00 \$0.00 0.0% 0.0% \$0.00 \$0 199 Carpet tile, tufted nylon, hard back, 26 oz., 18" x 18" 717.22 \$Y. \$13,588.60 21.3% 23.8% \$20,399.55 \$27,344 \$38.1 200 Note: Tile 0.00 \$0.00 0.0% 0.0% \$0.00 \$0 201 Ceramic tile, floors, glazed, porcelain type 1,089.00 \$F. \$15,335.27 21.3% 23.8% \$23,021.69 \$30,858 \$28.3 202 Ceramic tile, cove base, thin set, 6" x 4-1/4" h 393.00 L.F. \$5,908.94 21.3% 23.8% \$8,870.64 \$11,890 \$30.2 203 Note: VCT 0.00 \$0.00 0.0% 0.0% \$0.00 \$0.00 \$0.00	187 188 189 190 191 192 193 194 195	Complete suspended ceilings, fiberglass ceiling board, plain faced, offices, 2' x 2' x 3/4", include standard suspension system, excl. 1-1/2" carrier channels Note: Sypsum Suspended ceiling system, 1-1/2" carriers, 24" OC with 7/8" channels, 16" OC, incl. carriers Gypsum wallboard, on ceilings, standard, taped & finished (level 4 finish), 5/8" thick Note: Ceiling Replacement in City Hall: ACT Allowance - Complete suspended ceilings, fiberglass ceiling board, plain faced, offices, 2' x 2' x 3/4", include standard suspension system, excl. 1-1/2" carrier channels Note: Ceiling Replacement in City Hall: GWB Suspended ceiling system, 1-1/2" carriers, 24" OC with 1-5/8" channels, 16" OC, incl. carriers	7,733.00 0.00 1,729.00 1,729.00 0.00 6,662.00 0.00 1,665.00	S.F. S.F. GSF	\$76,108.48 \$0.00 \$4,975.20 \$3,159.24 \$0.00 \$52,930.87 \$0.00 \$7,858.13	21.3% 0.0% 21.3% 21.3% 0.0% 21.3% 0.0% 21.3%	23.8% 0.0% 23.8% 0.0% 23.8% 0.0% 23.8%	\$0.00 \$7,468.90 \$4,742.73 \$0.00 \$79,461.15 \$0.00 \$11,796.83	\$0 \$10,011 \$6,357 \$0 \$106,510 \$0 \$15,812	\$5.79 \$3.68 \$15.99 \$9.50
199 Carpet tile, tufted nylon, hard back, 26 oz., 18" x 18" 717.22 S.Y. \$13,588.60 21.3% 23.8% \$20,399.55 \$27,344 \$38.1 200 Note: Tile 0.00 \$0.00 0.0% 0.0% 50.00 \$0 201 Ceramic tile, floors, glazed, porcelain type 1,089.00 S.F. \$15,335.27 21.3% 23.8% \$23,021.69 \$30,085 \$28.3 202 Ceramic tile, cove base, thin set, 6" x 4-1/4" h 393.00 L.F. \$5,908.94 21.3% 23.8% \$8,870.64 \$11,890 \$30.2 203 Note: VCT 0.00 \$0.00 \$0.00 0.0% \$0.00 \$0.00 \$0	187 188 189 190 191 192 193 194 195	Complete suspended ceilings, fiberglass ceiling board, plain faced, offices, 2' x 2' x 3/4", include standard suspension system, excl. 1-1/2" carrier channels Note: Gypsum Suspended ceiling system, 1-1/2" carriers, 24" OC with 7/8" channels, 16" OC, incl. carriers Gypsum wallboard, on ceilings, standard, taped & finished (level 4 finish), 5/8" thick Note: Ceiling Replacement in City Hall: ACT Allowance - Complete suspended ceilings, fiberglass ceiling board, plain faced, offices, 2' x 2' x 3/4", include standard suspension system, excl. 1-1/2" carrier channels Note: Ceiling Replacement in City Hall: GWB Suspended ceiling system, 1-1/2" carrier channels Gypsum wallboard, on ceilings, standard, w/compound skim coat (level 5 finish), 5/8" thick	7,733.00 0.00 1,729.00 1,729.00 0.00 6,662.00 0.00 1,665.00	S.F. S.F. GSF S.F.	\$76,108.48 \$0.00 \$4,975.20 \$3,159.24 \$0.00 \$52,930.87 \$0.00 \$7,858.13 \$4,805.74	21.3% 0.0% 21.3% 21.3% 0.0% 21.3% 0.0% 21.3%	23.8% 0.0% 23.8% 23.8% 0.0% 23.8% 0.0% 23.8% 23.8%	\$0.00 \$7,468.90 \$4,742.73 \$0.00 \$79,461.15 \$0.00 \$11,796.83 \$7,214.50	\$0 \$10,011 \$6,357 \$0 \$106,510 \$0 \$15,812 \$9,670	\$5.79 \$3.68 \$15.99 \$9.50
200 Note: Tile 0.00 \$0.00 0.0% 0.0% \$0.00 \$0 201 Ceramic tile, floors, glazed, porcelain type 1,089.00 \$F. \$15,335.27 21.3% 23.3% \$23,021.69 \$30,858 \$28.3 202 Ceramic tile, cove base, thin set, 6" x 4-1/4" h 393.00 LF. \$5,908.94 21.3% \$38,870.64 \$11,890 \$30.2 203 Note: VCT 0.00 \$0.00 0.0% 0.0% \$0.00 \$0 \$0	187 188 189 190 191 192 193 194 195 196	Complete suspended ceilings, fiberglass ceiling board, plain faced, offices, 2' x 2' x 3/4", include standard suspension system, excl. 2-1/2" carrier channels Note: Gypsum Suspended ceiling system, 1-1/2" carriers, 24" OC with 7/8" channels, 16" OC, incl. carriers Gypsum wallboard, on ceilings, standard, taped & finished (level 4 finish), 5/8" thick Note: Ceiling Replacement in City Hall: ACT Allowance - Complete suspended ceilings, fiberglass ceiling board, plain faced, offices, 2' x 2' x 3/4", include standard suspension system, excl. 1-1/2" carrier channels Note: Ceiling Replacement in City Hall: GWB Suspended ceiling system, 1-1/2" carriers, 24" OC with 1-5/8" channels, 16" OC, incl. carriers Gypsum wallboard, on ceilings, standard, w/compound skim coat (level 5 finish), 5/8" thick	7,733.00 0.00 1,729.00 1,729.00 0.00 6,662.00 0.00 1,665.00 1,665.00	S.F. S.F. GSF S.F.	\$76,108.48 \$0.00 \$4,975.20 \$3,159.24 \$0.00 \$52,930.87 \$0.00 \$7,858.13 \$4,805.74 \$50,605	21.3% 0.0% 21.3% 21.3% 0.0% 21.3% 0.0% 21.3% 21.3% 21.3%	23.8% 0.0% 23.8% 23.8% 0.0% 23.8% 0.0% 23.8% 23.8% 23.8%	\$0.00 \$7,468.90 \$4,742.73 \$0.00 \$79,461.15 \$0.00 \$11,796.83 \$7,214.50 \$75,969	\$0 \$10,011 \$6,357 \$0 \$106,510 \$0 \$15,812 \$9,670 \$101,829	\$5.79 \$3.68 \$15.99 \$9.50
202 Ceramic tile, cove base, thin set, 6" x 4-1/4" h 393.00 L.F. \$5,908.94 21.3% 23.8% \$8,870.64 \$11,890 \$30.2 203 Note: VCT 0.00 \$0.00 0.0% 0.0% \$0.00 \$0	187 188 189 190 191 192 193 194 195 196 197	Complete suspended ceilings, fiberglass ceiling board, plain faced, offices, 2' x 2' x 3/4", include standard suspension system, excl. 1-1/2" carrier channels Note: Syspum Suspended ceiling system, 1-1/2" carriers, 24" OC with 7/8" channels, 16" OC, incl. carriers Gypsum wallboard, on ceilings, standard, taped & finished (level 4 finish), 5/8" thick Note: Ceiling Replacement in City Hall: ACT Allowance - Complete suspended ceilings, fiberglass ceiling board, plain faced, offices, 2' x 2' x 3/4", include standard suspension system, excl. 1-1/2" carrier channels Note: Ceiling Replacement in City Hall: GWB Suspended ceiling system, 1-1/2" carriers, 24" OC with 1-5/8" channels, 16" OC, incl. carriers Gypsum wallboard, on ceilings, standard, w/compound skim coat (level 5 finish), 5/8" thick FLOORING Note: Carpet	7,733.00 0.00 1,729.00 1,729.00 0.00 6,662.00 1,665.00 1,665.00 0.00	S.F. S.F. S.F. LS	\$76,108.48 \$0.00 \$4,975.20 \$3,159.24 \$0.00 \$52,930.87 \$0.00 \$7,858.13 \$4,805.74 \$50,605	21.3% 0.0% 21.3% 21.3% 0.0% 21.3% 21.3% 21.3% 21.3%	23.8% 0.0% 23.8% 23.8% 0.0% 23.8% 0.0% 23.8% 23.8% 23.8%	\$0.00 \$7,468.90 \$4,742.73 \$0.00 \$79,461.15 \$0.00 \$11,796.83 \$7,214.50 \$75,969 \$0.00	\$0 \$10,011 \$6,357 \$0 \$106,510 \$15,812 \$9,670 \$101,829	\$5.79 \$3.68 \$15.99 \$9.50 \$5.81
203 Note: VCT 0.00 \$0.00 0.0% \$0.00 \$0	187 188 189 190 191 192 193 194 195 196 197 198 199 200	Complete suspended ceilings, fiberglass ceiling board, plain faced, offices, 2' x 2' x 3/4", include standard suspension system, excl. 1-1/2" carrier channels Note: Gypsum Suspended ceiling system, 1-1/2" carriers, 24" OC with 7/8" channels, 16" OC, incl. carriers Gypsum wallboard, on ceilings, standard, taped & finished (level 4 finish), 5/8" thick Note: Ceiling Replacement in City Hall: ACT Allowance - Complete suspended ceilings, fiberglass ceiling board, plain faced, offices, 2' x 2' x 3/4", include standard suspension system, excl. 1-1/2" carrier channels Note: Ceiling Replacement in City Hall: GWB Suspended ceiling system, 1-1/2" carriers, 24" OC with 1-5/8" channels, 16" OC, incl. carriers Gypsum wallboard, on ceilings, standard, w/compound skim coat (level 5 finish), 5/8" thick FLOORING Note: Carpet Carpet tile, tufted nylon, hard back, 26 oz., 18" x 18"	7,733.00 0.00 1,729.00 1,729.00 0.00 6,662.00 1,665.00 1,665.00 1 0.00 717.22 0.00	S.F. S.F. GSF S.F. S.F. S.F. S.F.	\$76,108.48 \$0.00 \$4,975.20 \$3,159.24 \$0.00 \$52,930.87 \$0.00 \$7,858.13 \$4,805.74 \$50,605 \$0.00 \$13,588.60 \$0.00	21.3% 0.0% 21.3% 21.3% 0.0% 21.3% 0.0% 21.3% 21.3% 21.3% 0.0% 21.3%	23.8% 0.0% 23.8% 23.8% 0.0% 23.8% 0.0% 23.8% 23.8% 0.0% 23.8%	\$0.00 \$7,468.90 \$4,742.73 \$0.00 \$79,461.15 \$0.00 \$11,796.83 \$7,214.50 \$75,969 \$0.00 \$20,399.55 \$0.00	\$0 \$10,011 \$6,357 \$0 \$106,510 \$0 \$15,812 \$9,670 \$101,829 \$0 \$27,344	\$5.79 \$3.68 \$15.99 \$9.50 \$5.81
	187 188 190 191 192 193 194 195 196 197 198 199 200	Complete suspended ceilings, fiberglass ceiling board, plain faced, offices, 2' x 2' x 3/4", include standard suspension system, excl. 1-1/2" carrier channels Note: Syspum Suspended ceiling system, 1-1/2" carriers, 24" OC with 7/8" channels, 16" OC, incl. carriers Gypsum wallboard, on ceilings, standard, taped & finished (level 4 finish), 5/8" thick Note: Ceiling Replacement in City Hall: ACT Allowance - Complete suspended ceilings, fiberglass ceiling board, plain faced, offices, 2' x 2' x 3/4", include standard suspension system, excl. 1-1/2" carrier channels Note: Ceiling Replacement in City Hall: GWB Suspended ceiling system, 1-1/2" carriers, 24" OC with 1-5/8" channels, 16" OC, incl. carriers Gypsum wallboard, on ceilings, standard, w/compound skim coat (level 5 finish), 5/8" thick FLOORING Note: Carpet Carpet tile, tufted nylon, hard back, 26 oz., 18" x 18" Note: Tile Ceramic tile, floors, glazed, porcelain type	7,733.00 0.00 1,729.00 1,729.00 0.00 6,662.00 1,665.00 1,665.00 1 0.00 717.22 0.00 1,089.00	S.F. S.F. GSF S.F. S.F. S.F. S.F. S.F. S	\$76,108.48 \$0.00 \$4,975.20 \$3,159.24 \$0.00 \$52,930.87 \$0.00 \$7,858.13 \$4,805.74 \$50,605 \$0.00 \$13,588.60 \$0.00 \$15,335.27	21.3% 0.0% 21.3% 0.0% 21.3% 21.3% 21.3% 21.3% 21.3% 21.3% 21.3% 21.3% 21.3%	23.8% 0.0% 23.8% 0.0% 23.8% 0.0% 23.8% 23.8% 0.0% 23.8% 0.0% 23.8% 0.0% 23.8%	\$0.00 \$7,468.90 \$4,742.73 \$0.00 \$79,461.15 \$0.00 \$11,796.83 \$7,214.50 \$75,969 \$0.00 \$20,399.55 \$0.00 \$23,021.69	\$0 \$10,011 \$6,357 \$0 \$106,510 \$0 \$15,812 \$9,670 \$101,829 \$0 \$27,344 \$0	\$5.79 \$3.68 \$15.99 \$9.50 \$5.81 \$38.12
	187 188 189 190 191 192 193 194 195 196 197 198 199 200 201 202	Complete suspended ceilings, fiberglass ceiling board, plain faced, offices, 2' x 2' x 3/4", include standard suspension system, excl. 1-1/2" carrier channels Note: Sypsum Suspended ceiling system, 1-1/2" carriers, 24" OC with 7/8" channels, 16" OC, incl. carriers Gypsum wallboard, on ceilings, standard, taped & finished (level 4 finish), 5/8" thick Note: Ceiling Replacement in City Hall: ACT Allowance - Complete suspended ceilings, fiberglass ceiling board, plain faced, offices, 2' x 2' x 3/4", include standard suspension system, excl. 1-1/2" carrier channels Note: Ceiling Replacement in City Hall: GWB Suspended ceiling system, 1-1/2" carriers, 24" OC with 1-5/8" channels, 16" OC, incl. carriers Gypsum wallboard, on ceilings, standard, w/compound skim coat (level 5 finish), 5/8" thick FLOORING Note: Carpet Carpet tile, tufted nylon, hard back, 26 oz., 18" x 18" Note: Tile Ceramic tile, floors, glazed, porcelain type Ceramic tile, cove base, thin set, 6" x 4-1/4" h	7,733.00 0.00 1,729.00 1,729.00 0.00 6,662.00 1,665.00 1,665.00 717.22 0.00 1,089.00 393.00	S.F. S.F. GSF S.F. S.F. S.F. S.F. S.F. S	\$76,108.48 \$0.00 \$4,975.20 \$3,159.24 \$0.00 \$52,930.87 \$0.00 \$7,858.13 \$4,805.74 \$50,605 \$0.00 \$13,588.60 \$0.00 \$13,588.60 \$51,335.27 \$5,908.94	21.3%	23.8% 0.0% 23.8% 0.0% 23.8% 0.0% 23.8% 23.8% 0.0% 23.8% 23.8% 23.8% 23.8% 23.8%	\$0.00 \$7,468.90 \$4,742.73 \$0.00 \$79,461.15 \$0.00 \$11,796.83 \$7,214.50 \$75,969 \$0.00 \$20,399.55 \$0.00 \$23,021.69 \$8,870.64	\$0 \$10,011 \$6,357 \$0 \$106,510 \$106,510 \$15,812 \$9,670 \$101,829 \$0 \$27,344 \$0 \$30,858 \$11,890	\$5.79 \$3.68 \$15.99 \$9.50 \$5.81







Delivery Method: CMAR Estimate Type: AACEi Class 4 WBS: Component/Uniformat

	Saginaw Keeter Bldg F	Reno Cor	ncept						
						Prime	Total	ECC	ECC Unit
Line #	Description	Qty.	UoM	Subtotal	Sub %	%	Direct Cost	w/Escalation	Cost
205	Note: Walk-off	0.00		\$0.00	0.0%	0.0%	\$0.00	\$0	
	Carpet, commercial grades, direct cement, nylon, plush, 42 oz., medium to heavy traffic	13.00	S.Y.	\$375.03	21.3%	23.8%	\$563.01	\$755	\$58.05
	Note: Concrete Polished concrete floors, processing of interior floors, spray on penetrating densifier/hardener, 2 coats	0.00	M.S.F.	\$0.00 \$140.95	0.0% 21.3%	0.0% 23.8%	\$0.00 \$211.60	\$0 \$284	\$920.88
	Note: Resilient Base	0.00	IVI.S.F.	\$0.00	0.0%	0.0%	\$0.00	\$284	\$920.00
	Wall base, vinyl, straight or cove, standard colors, 6" high, 1/8" thick	2,288.00	L.F.	\$9,737.89	21.3%	23.8%	\$14,618.77	\$19,595	\$8.56
211	WALLS	1	LS	\$38,765	21.3%	23.8%	\$58,195	\$78,005	
	Note: Acoustic Panel	0.00		\$0.00	0.0%	0.0%	\$0.00	\$0	
	Sound absorbing panels, fiberboard panels, sound deadening, 1/2" thick	883.00	S.F.	\$1,011.68	21.3%	23.8%	\$1,518.76	\$2,036	\$2.31
	Note: FRP Panel Fiberglass reinforced plastic panel, on walls, adhesive mounted, smooth surface, .090" thick	0.00 215.00	S.F.	\$0.00 \$943.06	0.0% 21.3%	0.0% 23.8%	\$0.00 \$1,415.75	\$0 \$1,898	\$8.83
	Note: Tile	0.00	5.1.	\$0.00	0.0%	0.0%	\$0.00	\$0	70.03
	Ceramic tile, walls, glazed, porcelain type	2,614.00	S.F.	\$36,810.28	21.3%	23.8%	\$55,260.52	\$74,071	\$28.34
218	PAINTING	1	LS	\$21,543	21.3%	23.8%	\$32,341	\$43,350	
_	Note: Dryfall	0.00		\$0.00	0.0%	0.0%	\$0.00	\$0	
	Dry fall painting, ceilings, concrete or textured plaster, two coat, spray Note: Ceilings and Walls	307.00 0.00	S.F.	\$159.51 \$0.00	21.3% 0.0%	23.8%	\$239.46 \$0.00	\$321 \$0	\$1.05
	Paints & coatings, walls & ceilings, interior, concrete, drywall or plaster, zero voc latex, primer or sealer coat, smooth	28,457.00	S.F.	\$5,501.93	21.3%	23.8%	\$8,259.64	\$11,071	\$0.39
	finish, spray								
	Paints & coatings, walls & ceilings, interior, concrete, drywall or plaster, zero voc latex, 2 coats, smooth finish, spray	28,457.00	S.F.	\$9,620.80	21.3%	23.8%	\$14,442.99	\$19,359	\$0.68
224	Backroll finish coats of paint	28,457.00	S.F.	\$6,260.72	21.3%	23.8%	\$9,398.76	\$12,598	\$0.44
	SERVICES	1	LS	\$1,164,779	21.3%	23.8%	\$1,748,596	\$2,343,819	
226 227	PLUMBING DOMESTIC WATER PIPING	10,071	LS S.F.	\$197,329 \$99,422	21.3% 21.3%	23.8%	\$296,235 \$149,254	\$397,074 \$200,061	\$19.87
	DOMESTIC WATER PIPING Domestic distribution piping, type L copper, solder joints	10,071.00	S.F.	\$85,603.50	21.3%	23.8%	\$149,254	\$200,061	\$19.87 \$17.10
	Domestic distribution piping, type E copper, solder Joints Domestic water piping insulation, fiberglass with all service jacket. 1" thick	10,071.00	S.F.	\$12,588.75	21.3%	23.8%	\$18,898.55	\$25,332	\$2.52
	Pump, domestic recirculating	1.00	Ea.	\$1,229.49	21.3%	23.8%	\$1,845.74	\$2,474	•
231	COMMERCIAL PLUMBING FIXTURES	1	LS	\$50,846	21.3%	23.8%	\$76,332	\$102,315	
	Water closet, wall mount, IR sensor flush valve, carrier	8.00	Ea.	\$20,942.95	21.3%	23.8%	\$31,440.08	\$42,142	\$5,267.79
	Urinal, wall mount, IR sensor flush valve, carrier Lavatory, wall mount, IR sensor faucet, carrier	2.00 8.00	Ea. Ea.	\$4,551.80 \$13,407.21	21.3% 21.3%	23.8% 23.8%	\$6,833.28 \$20,127.25	\$9,159 \$26,979	\$4,579.67 \$3,372.32
	Breakroom sink, ss double comp, manual faucet	1.00	Ea.	\$1,775.90	21.3%	23.8%	\$2,666.03	\$3,574	33,372.32
	Mop sink, floor mount, manual faucet	1.00	Ea.	\$2,567.87	21.3%	23.8%	\$3,854.95	\$5,167	
	Floor drain, mech room	1.00	Ea.	\$727.46	21.3%	23.8%	\$1,092.08	\$1,464	
	Floor drain, bathroom	4.00	Ea.	\$2,509.84	21.3%	23.8%	\$3,767.83	\$5,050	\$1,262.60
	Water cooler, electric, bi-level, with bottle filler Coffee maker connection with backflow preventer	1.00	Ea. Ea.	\$3,885.74 \$477.46	21.3% 21.3%	23.8%	\$5,833.37 \$716.77	\$7,819 \$961	
240	SANITARY WASTE & VENT PIPING	1.00	LS.	\$28,482	21.3%	23.8%	\$42,758	\$57,312	
	Note: Sawcutting, removal and pour back	350.00	S.F.	\$0.00	0.0%	0.0%	\$0.00	\$0	\$0.00
	Concrete sawing, concrete slabs, rod reinforced, up to 3" deep, includes blade cost, layout and set up time	255.00	L.F.	\$700.37	21.3%	23.8%	\$1,051.41	\$1,409	\$5.53
244	Concrete sawing, concrete, existing slab, rod reinforced, for each additional inch of depth over 3", includes blade cost,	765.00	L.F.	\$736.12	21.3%	23.8%	\$1,105.08	\$1,481	\$1.94
245	layout and set up time	6.48	C.Y.	61 672 01	21.3%	23.8%	62 544 26	\$3,366	\$519.46
245	Selective concrete demolition, reinforcing more than 2% cross-sectional area, break up into small pieces, excludes shoring, bracing, saw or torch cutting, loading, hauling, dumping	6.48	C.Y.	\$1,672.81	21.3%	23.8%	\$2,511.26	\$3,300	\$519.46
246	1-1/2 C.Y. bucket, loading and/or spreading, shovel	6.48	B.C.Y.	\$16.18	21.3%	23.8%	\$24.30	\$33	\$5.03
	Cycle hauling (wait, load, travel, unload or dump & return) time per cycle, excavated or borrow, loose cubic yards, 25	6.48	L.C.Y.	\$82.08	21.3%	23.8%	\$123.22	\$165	\$25.49
	min wait/load/unload, 8 C.Y. truck, cycle 4 miles, 15 MPH, excludes loading equipment								
248	Structural concrete, in place, slab on grade (3500 psi), 6" thick, includes forms(4 uses), Grade 60 rebar, concrete (Portland cement Type I), and placing	6.48	C.Y.	\$1,687.97	21.3%	23.8%	\$2,534.03	\$3,397	\$524.17
249	Note: Excavation & backfill	0.00		\$0.00	0.0%	0.0%	\$0.00	\$0	
	Excavating, trench or continuous footing, common earth, 3/4 C.Y. excavator, to 14' deep	51.11	B.C.Y.	\$1,038.50	21.3%	23.8%	\$1,559.02	\$2,090	\$40.89
	Backfill, haul from existing stockpile, excludes compaction	66.44	L.C.Y.	\$790.39	21.3%	23.8%	\$1,186.55	\$1,590	\$23.94
	Compaction, vibrating plate	66.44	E.C.Y.	\$165.06	21.3%	23.8%	\$247.79	\$332	\$5.00
	Fill, gravel embed in pipe trench, compacted, to 9" deep Note: New sanitary waste & vent piping	345.00 0.00	S.F.	\$601.68 \$0.00	21.3%	23.8%	\$903.26 \$0.00	\$1,211 \$0	\$3.51
	Sanitary waste vent piping Sanitary waste piping, below grade, Sch 40 PVC	400.00	L.F.	\$6,000.00	21.3%	23.8%	\$9,007.35	\$12,073	\$30.18
	Sanitary vent piping, above grade, no hub cast iron	320.00	L.F.	\$11,200.00	21.3%	23.8%	\$16,813.72	\$22,537	\$70.43
	Drain, floor, medium duty, cast iron, deep flange, with polished bronze top, 7" diameter top	4.00	Ea.	\$2,102.73	21.3%	23.8%	\$3,156.67	\$4,231	\$1,057.80
	Note: Concrete pour back Structural concrete, in place, slab on grade (3500 psi), 6" thick, includes forms(4 uses), Grade 60 rebar, concrete	0.00 6.48	C.Y.	\$0.00 \$1,687.97	0.0% 21.3%	0.0% 23.8%	\$0.00 \$2,534.03	\$0 \$3,397	\$524.17
259	(Portland cement Type I), and placing	0.48	C.1.	/ 91,007.97	41.3%	43.0%	22,354.U3	\$3,397	7324.17
260	NATURAL GAS PIPING	1	LS	\$4,949	21.3%	23.8%	\$7,430	\$9,959	
261	Note: Natural gas piping	0.00		\$0.00	0.0%	0.0%	\$0.00	\$0	
262	Pipe, steel, black, threaded, 1" diameter, schedule 40, A-106, grade A/B seamless, includes coupling and clevis hanger	100.00	L.F.	\$3,091.63	21.3%	23.8%	\$4,641.24	\$6,221	\$62.21
262	assembly sized for covering, 10' OC Elbow, 90 Deg., steel, malleable iron, black, straight, threaded, 150 lb., 1"	24.00	Ea.	\$1,490.66	21.3%	23.8%	\$2,237.81	\$3,000	\$124.98
	Tee, steel, malleable iron, black, straight, threaded, 150 lb., 1"	3.00	Ea.	\$300.08	21.3%	23.8%	\$450.49	\$604	\$201.28
	Pressure regulator, gas appliance, main burner and pilot applications, rubber seat poppet type, threaded, 3/4" pipe	1.00	Ea.	\$66.85	21.3%	23.8%	\$100.35	\$135	,
	size								
266	COMMERCIAL GAS DOMESTIC WATER HEATER	1	LS	\$13,630	21.3%	23.8%	\$20,461	\$27,427	
	Note: New domestic water heater -100 Gallon Water heater, gas fired, 120 MBH input, includes standard controls, excludes vent	0.00 1.00	Ea.	\$0.00 \$7,080.03	0.0% 21.3%	0.0% 23.8%	\$0.00 \$10,628.72	\$0 \$14,247	
	Domestic water piping connection, specialties & accessories	1.00	Ea.	\$4,799.87	21.3%	23.8%	\$7,205.68	\$14,247	
270	Water heater flue/vent	1.00	Ea.	\$633.31	21.3%	23.8%	\$950.74	\$1,274	
	Natural gas piping connection	1.00	Ea.	\$1,116.62	21.3%	23.8%	\$1,676.30	\$2,247	
272	HEATING, VENTILATION, AND AIR CONDITIONING (HVAC)	1	LS	\$334,478	21.3%	23.8%	\$502,127	\$673,051	
273	HVAC OPTION #1	10,073		\$334,478	21.3%	23.8%	\$502,127	\$673,051	\$66.82
274	PACKAGED OUTDOOR HVAC EQUIPMENT Peoffee air conditioner, multi-zone du coal, 20 ton coaling, includes, standard controls, such and coanomizer.	10,073		\$60,414	21.3%	23.8%	\$90,695	\$121,568	\$12.07
	Rooftop air conditioner, multi-zone, dx cool, 30 ton cooling, includes, standard controls, curb and economizer Crane crew, daily use for small jobs, 40-ton truck-mounted hydraulic crane, portal to portal	1.00	Ea. Day	\$56,242.47 \$4,171.48	21.3% 21.3%	23.8%	\$84,432.61 \$6,262.32	\$113,174 \$8,394	
2/0	erance area, adain, ade for amount population track mounted flydraulic traffe, portal to portal	1.00	Day	, γ , 1/1.40	0/ر.12	23.070	¥U,ZUZ.3Z	ا94درەد	







Delivery Method: CMAR Estimate Type: AACEi Class 4 WBS: Component/Uniformat

	Saginaw Keeter Bldg Reno Concept								
						Prime	Total	ECC	ECC Unit
Line #	Description	Qty.	UoM	Subtotal	Sub %	%	Direct Cost	w/Escalation	Cost
277	HVAC DUCTWORK	10,073	GSF	\$76,145	21.3%	23.8%	\$114,311	\$153,223	\$15.21
	Note: Supply air ductwork (return air is open ceiling return)	0.00		\$0.00	0.0%	0.0%	\$0.00	\$0	
	Supply ductwork, medium pressure, galv. Supply ductwork, low pressure, galv.	3,021.90 7,051.10	Lb. Lb.	\$18,131.40 \$28,204.40	21.3% 21.3%	23.8%	\$27,219.31 \$42,341.16	\$36,485 \$56,754	\$12.07 \$8.05
	Duct Insulation	5,036.50	S.F.	\$28,204.40	21.3%	23.8%	\$42,341.16	\$40,539	\$8.05
	Note: Bathroom exhaust ductwork	0.00	5	\$0.00	0.0%	0.0%	\$0.00	\$0	\$0.03
	Exhaust ductwork, galv.	800.00	Lb.	\$6,400.00	21.3%	23.8%	\$9,607.84	\$12,878	\$16.10
	Note: Connector corridor split system ductwork	0.00	-	\$0.00	0.0%	0.0%	\$0.00	\$0	42.202.57
285 286	Split system air conditioner, subassembly for assembly systems, duct work per ton single unit AIR TERMINAL UNITS	2.00 10,073	Ton GSF	\$3,263.59 \$33,185	21.3% 21.3%	23.8% 23.8%	\$4,899.39 \$49,818	\$6,567 \$66,775	\$3,283.57 \$6.63
	Note: VAV boxes, assumes 500 CFM average size	0.00	ЧЭГ	\$0.00	0.0%	0.0%	\$0.00	\$00,773	30.03
	Duct accessories, variable air volume, electric reheat coil, direct digital control, 500 CFM, no hydronic coils	20.00	Ea.	\$33,184.58	21.3%	23.8%	\$49,817.52	\$66,775	\$3,338.77
289	AIR INLETS AND OUTLETS	10,073	GSF	\$32,550	21.3%	23.8%	\$48,864	\$65,498	\$6.50
	Diffusers, grilles, transfers	150.00	Ea.	\$28,200.00	21.3%	23.8%	\$42,334.55	\$56,745	\$378.30
291	Ductwork, flexible coated fiberglass fabric on corrosion resistant metal helix, insulated, P.E. jacket, 1" thick HVAC FANS	450.00 10,073	L.F.	\$4,349.54 \$2,596	21.3% 21.3%	23.8% 23.8%	\$6,529.64 \$3,897	\$8,752 \$5,223	\$19.45 \$0.52
	Fans, down blast, motor and drive complete, 900 CFM, with curb	1.00	Ea.	\$2,595.73	21.3%	23.8%	\$3,896.77	\$5,223	JU.JZ
294	DECENTRALIZED UNITARY HVAC EQUIPMENT	10,073	GSF	\$11,332	21.3%	23.8%	\$17,011	\$22,802	\$2.26
295	Note: Electrical & MDF room cooling only split systems - 1 ton	0.00		\$0.00	0.0%	0.0%	\$0.00	\$0	
	Split ductless system, cooling only, single zone, wall mount, 1 ton cooling	2.00	Ea.	\$3,975.55	21.3%	23.8%	\$5,968.20	\$8,000	\$3,999.89
	Split ductless system, accessories for all split ductless systems, for tube / wiring kit, 50' kit Curbs/pads prefabricated, pad, condenser, fiberglass reinforced concrete with polystyrene foam core, 2" thick, 24" x	2.00 1.00	Ea. Ea.	\$975.60 \$159.66	21.3% 21.3%	23.8%	\$1,464.60 \$239.69	\$1,963 \$321	\$981.57
290	Corbs/pads prefabricated, pad, condenser, indergrass reinforced concrete with polystyrene roam core, 2 - thick, 24 - x - 36"	1.00	Ed.	\$159.00	21.5%	23.0%	\$259.09	\$321	
299	Note: Connector addition heat pump ducted split systems - 2 ton	0.00		\$0.00	0.0%	0.0%	\$0.00	\$0	
300	Heat pump, air to air single package, 2 ton cooling, 6.5 MBH heat @ ODeg.F, excludes interconnecting tubing, curbs,	1.00	Ea.	\$5,444.32	21.3%	23.8%	\$8,173.15	\$10,955	
201	pads and ductwork Split purton accessories for all split ductless systems, for tube / wiring kit, FO' kit	1.00	Ea.	\$487.80	21.3%	23.8%	\$732.30	\$982	
	Split system, accessories for all split ductless systems, for tube / wiring kit, 50' kit Curbs/pads prefabricated, pad, condenser, fiberglass reinforced concrete with polystyrene foam core, 2" thick, 36" x	1.00	Ea.	\$487.80	21.3%	23.8%	\$433.45	\$982 \$581	
302	36"	1.00	Lu.	ÿ200.73	21.570	25.070	Ş433.43	\$501	
303	REFRIGERANT PIPING	10,073	GSF	\$8,970	21.3%	23.8%	\$13,465	\$18,049	\$1.79
	NOTE: Refrigerant piping to split systems (3 Ea.)	0.00		\$0.00	0.0%	0.0%	\$0.00	\$0	
	Refrigerant line sets, insulated copper supply and return tubes, 3/8" and 3/4" tubes, 1/2" insulation, 50' long	3.00	Ea.	\$2,015.02	21.3%	23.8%	\$3,025.01 \$4,966.99	\$4,055	\$1,351.57
	Pipe hanger / support, hangers, trapeze channel support, steel, 12" wide, steel Refrigerant specialties, site glass, filter dryer	25.00 3.00	Ea. Ea.	\$3,308.62 \$1,308.62	21.3% 21.3%	23.8%	\$1,966.99	\$6,658 \$2,633	\$266.31 \$877.75
	Refrigeration specialties, refrigerant, R-410A, 25 lb. cylinder	15.00	Lb.	\$2,337.29	21.3%	23.8%	\$3,508.80	\$4,703	\$313.55
309	CONDENSATE DRAIN PIPING	10,073	GSF	\$4,004		23.8%	\$6,011	\$8,056	\$0.80
	NOTE: Condensate drain piping to split system (3 Ea.)	0.00		\$0.00	0.0%	0.0%	\$0.00	\$0	
	Pipe, copper, tubing, solder, 3/4" diameter, type L, includes coupling & clevis hanger assembly 10' OC	120.00	L.F.	\$1,650.56	21.3%	23.8%	\$2,477.87	\$3,321	\$27.68
	Elbow, 90 Deg., copper, wrought, copper x copper, 3/4" Insulation, pipe covering (price copper tube one size less than I.P.S.), fiberglass with all service jacket, 1/2" wall, 1/2"	40.00 120.00	Ea. L.F.	\$1,559.09 \$794.07	21.3% 21.3%	23.8%	\$2,340.55 \$1,192.08	\$3,137 \$1,598	\$78.43 \$13.32
313	iron pipe size	120.00	L.II.	\$754.07	21.570	25.070	\$1,152.00	\$1,550	Ģ13.32
314	MISC HVAC	10,073	GSF	\$40,284	21.3%	23.8%	\$60,475	\$81,061	\$8.05
	Test and balancing, air	10,071.00	S.F.	\$40,284.00	21.3%	23.8%	\$60,475.35	\$81,061	\$8.05
	NOTE: Startup - Included	0.00		\$0.00	0.0%	0.0%	\$0.00	\$0	
	NOTE: Commissioning assistance - Included NOTE: Pipe, duct & equipment identification - Included	0.00		\$0.00 \$0.00	0.0%	0.0%	\$0.00 \$0.00	\$0 \$0	
	NOTE: Sleeves, penetrations & firestopping - Included	0.00		\$0.00	0.0%	0.0%	\$0.00	\$0	
320	INSTRUMENTATION AND CONTROL FOR HVAC	10,073	GSF	\$65,000	21.3%	23.8%	\$97,580	\$130,796	\$12.98
	Note: Stand alone controls	0.00		\$0.00	0.0%	0.0%	\$0.00	\$0	
322 323	RTU VAV	1.00 20.00	Ea. Ea.	\$3,000.00 \$30,000.00	21.3% 21.3%	23.8% 23.8%	\$4,503.68 \$45,036.76	\$6,037 \$60,367	\$3,018.36
	VAV Room Temp Sensors	20.00	Ea.	\$20,000.00	21.3%	23.8%	\$30,024.50	\$40,245	\$2,012.24
	Exhaust fan	1.00	Ea.	\$1,500.00	21.3%	23.8%	\$2,251.84	\$3,018	
	Electric unit heater	1.00	Ea.	\$1,500.00	21.3%	23.8%	\$2,251.84	\$3,018	
	Split systems - MDF & Electrical	2.00	Ea.	\$4,000.00 \$3,000.00	21.3% 21.3%	23.8%	\$6,004.90 \$4,503.68	\$8,049 \$6,037	\$4,024.49
	Split systems - Corridor Addition CO2 Sensors for DCV	1.00 2.00	Ea. Ea.	\$2,000.00	21.3%	23.8%	\$3,002.45	\$4,024	\$2,012.24
330	FIRE SUPPRESSION - LIBRARY	1	LS	\$120,876	21.3%	23.8%	\$181,462	\$243,232	T-/
	New Fire Suppression System	10,073.00	S.F.	\$120,876.00	21.3%	23.8%	\$181,462.09	\$243,232	\$24.15
332	FIRE SUPPRESSION - CITY HALL	1	LS	\$124,905		23.8%	\$187,511	\$251,339	
	Note: Ceiling Replacement Costs are Covered Under Section C20 - Interior Finishes	0.00 8,327.00	C F	\$0.00 \$124,905.00	0.0%	0.0%	\$0.00 \$187,510.53	\$0 \$251,339	\$30.18
334	New Fire Suppression System - Includes Additional Logistical Cost ELECTRICAL	0,327.00	S.F.	\$124,905.00 \$201,311	21.3% 21.3 %	23.8% 23.8%	\$187,510.53 \$302,214	\$405,087	\$30.18
	Selective demolition and temporary lighting fixture thru space	0.15	S.F.	\$1.15	21.3%	23.8%	\$1.73	\$403,087	\$15.15
337	Demolition of existing service	1.00	LS	\$2,874.08	21.3%	23.8%	\$4,314.65	\$5,783	
	Main service 100kVA (400AMP) Switchboard	1.00	LS	\$4,900.00	21.3%	23.8%	\$7,356.00	\$9,860	, .
	Rigid galvanized steel conduit, 4" diameter, to 10' high, includes 11 couplings per 100' Wire, copper, stranded, 600 volt, 500 kcmil, type THWN-THHN, normal installation conditions in wireway, conduit,	50.00 18.00	L.F. C.L.F.	\$2,745.49 \$26,430.94	21.3% 21.3%	23.8%	\$4,121.59 \$39,678.79	\$5,525 \$53,185	\$110.49 \$2,954.75
340	wire, copper, stranded, 600 volt, 500 kcmii, type i HWN-i HHN, normai installation conditions in Wireway, conduit, cable tray	16.00	C.L.F.	920,430.94	41.3%	43.0%	73.010,19	\$33,185	44.75رکړ
	Wire, copper, stranded, 600 volt, 4/0, type THWN-THHN, normal installation conditions in wireway, conduit, cable tray	6.00	C.L.F.	\$5,050.31	21.3%	23.8%	\$7,581.65	\$10,162	\$1,693.74
	Circuit breakers, bolt-on, 10 k A I.C., 3 pole, 240 volt, 80-100 amp	4.00	Ea.	\$1,522.20	21.3%	23.8%	\$2,285.16	\$3,063	\$765.76
	Wire, copper, stranded, 600 volt, #8, type THW, normal installation conditions in wireway, conduit, cable tray Wire, copper, stranded, 600 volt, #2, type THW, normal installation conditions in wireway, conduit, cable tray	40.00 120.00	C.L.F.	\$4,105.38 \$38,667.55	21.3% 21.3%	23.8% 23.8%	\$6,163.10 \$58,048.70	\$8,261 \$77,809	\$206.53 \$648.40
	Wire, copper, stranded, 600 voit, #2, type 1 HW, normal installation conditions in wireway, conduit, cable tray Electric metallic tubing, 2" diameter, to 10' high, includes 11 couplings per 100'	400.00	L.F.	\$38,667.55 \$4,183.07	21.3%	23.8%	\$58,048.70	\$77,809 \$8,417	\$648.40
	Centralized battery inverter 10kW	1.00	LS.	\$16,124.45	21.3%	23.8%	\$24,206.43	\$32,446	721.04
347	2'x4' lay-in fixtures for back-of-house areas	125.00	Ea.	\$25,000.00	21.3%	23.8%	\$37,530.63	\$50,306	\$402.45
	Egress lighting connected to the battery inverter	25.00	Ea.	\$8,750.00	21.3%	23.8%	\$13,135.72	\$17,607	\$704.29
	Repair Grounding and Bonding Electric metallic tubing, 3/4" diameter, to 10' high, includes 11 couplings per 100'	1.00 3,500.00	LS L.F.	\$3,000.00 \$11,190.98	21.3% 21.3%	23.8%	\$4,503.68 \$16,800.18	\$6,037 \$22,519	\$6.43
	Wire, copper, solid, 600 volt, #12, type THWN-THHN, normal installation conditions in wireway, conduit, cable tray	140.00	C.L.F.	\$7,878.60	21.3%	23.8%	\$11,827.55	\$15,854	\$113.24
352	Lighting control relay panel, 4 relay, with timeclock	2.00	Ea.	\$3,113.66	21.3%	23.8%	\$4,674.30	\$6,265	\$3,132.72
353	Lighting devices, occupancy sensors, passive infrared, ceiling mounted	20.00	Ea.	\$2,433.51	21.3%	23.8%	\$3,653.25	\$4,897	\$244.84







Delivery Method: CMAR Estimate Type: AACEi Class 4 WBS: Component/Uniformat

	Saginaw Keeter Bldg Reno Concept								
						Prime	Total	ECC	ECC Unit
Line #	Description	Qty.	UoM	Subtotal	Sub %	%	Direct Cost	w/Escalation	Cost
	Lighting devices, daylighting sensor, manual control, ceiling mounted	5.00	Ea.	\$1,052.66	21.3%	23.8%	\$1,580.28	\$2,118	\$423.64
	Lighting devices, remote power pack Lighting devices, automatic wall switches	30.00 15.00	Ea. Ea.	\$2,442.50 \$1,426.19	21.3% 21.3%	23.8%	\$3,666.74 \$2,141.03	\$4,915 \$2,870	\$163.83 \$191.32
	Outlet boxes, pressed steel, 4" octagon	200.00	Ea.	\$4,214.17	21.3%	23.8%	\$6,326.42	\$8,480	\$42.40
	Receptacle devices, residential, decorator style, with #12/2, type NM cable, 20 amp, incl box & cover plate	75.00	Ea.	\$5,134.87	21.3%	23.8%	\$7,708.59	\$10,333	\$137.77
	Electric metallic tubing, 3/4" diameter, to 10' high, includes 11 couplings per 100' Wire, copper, solid, 600 volt, #12, type THWN-THHN, normal installation conditions in wireway, conduit, cable tray	3,500.00 140.00	L.F. C.L.F.	\$11,190.98 \$7,878.60	21.3% 21.3%	23.8% 23.8%	\$16,800.18 \$11,827.55	\$22,519 \$15,854	\$6.43 \$113.24
361	COMMUNICATIONS COMMUNICATIONS	140.00	LS	\$7,878.60 \$28,504	21.3%	23.8%	\$11,827.55	\$15,854 \$57,356	\$113.24
	Equipment Room Setup	1.00	LS	\$23,748.17	21.3%	23.8%	\$35,651.34	\$47,787	
	Voice/data wall plate, plastic, 1 gang, 1-port, excl voice/data devices	3.00	Ea.	\$26.68	21.3%	23.8%	\$40.05	\$54	\$17.90
	Unshielded twisted pair (UTP) jack, RJ45, category 6 Voice/data wall plate, plastic, 1 gang, 1-port, excl voice/data devices	6.00 3.00	Ea.	\$113.26 \$26.68	21.3% 21.3%	23.8%	\$170.03 \$40.05	\$228 \$54	\$37.99 \$17.90
	Unshielded twisted pair (UTP) jack, RJ45, category 6	6.00	Ea.	\$113.26	21.3%	23.8%	\$40.03	\$228	\$17.90
	Electric metallic tubing (EMT), 1" diameter, to 10' high, incl 2 terminations, 2 elbows, 11 beam clamps, and 11	330.00	L.F.	\$3,408.64	21.3%	23.8%	\$5,117.14	\$6,859	\$20.78
	couplings per 100 LF						4	44	44
368 369	Cable support, J-hook, single tier, single sided, 1" diameter ELECTRONIC SAFETY AND SECURITY	100.00	Ea.	\$1,067.06 \$58,891	21.3% 21.3%	23.8% 23.8%	\$1,601.90 \$88,409	\$2,147 \$118,503	\$21.47
	DEMOLITION FIRE ALARM SYSTEM	1.00	LS	\$0.01	21.3%	23.8%	\$0.02	\$118,503	
	Fire alarm horn and strobe light, electrical demolition, remove	40.00	Ea.	\$1,218.15	21.3%	23.8%	\$1,828.72	\$2,451	\$61.28
	Fire alarm annunciation panel, 12 to 16 zone, electrical demolition, remove	1.00	Ea.	\$162.44	21.3%	23.8%	\$243.86	\$327	
	FIRE ALARM NEW DEVICES Detection system, smoke detector, duct type, addressable, excl. wires & conduit	1.00 5.00	LS Ea.	\$0.01 \$1,869.99	21.3% 21.3%	23.8%	\$0.02 \$2,807.28	\$0 \$3,763	\$752.58
	Detection system, remote fire alarm indicator light	5.00	Ea.	\$631.07	21.3%	23.8%	\$947.37	\$1,270	\$253.97
376	Photoelectric smoke detector	5.00	Ea.	\$1,520.57	21.3%	23.8%	\$2,282.72	\$3,060	\$611.95
	Detection system, fire alarm control panel, 12 zone, excluding wires & conduits	1.00	Ea.	\$4,617.96	21.3%	23.8%	\$6,932.59	\$9,292	A=2= = :
	Sound system, intercom remote station 15 FIRE ALARM CABLING (ABOVE 8' FREE AIR)	20.00 1.00	Ea. LS	\$5,218.15 \$0.01	21.3% 21.3%	23.8%	\$7,833.62 \$0.02	\$10,500 \$0	\$525.01
	Cable support, J-hook, single tier, single sided, 1" diameter	50.00	Ea.	\$533.53	21.3%	23.8%	\$800.95	\$1,074	\$21.47
381	Electric metallic tubing, 3/4" diameter, to 10' high, includes 11 couplings per 100'	300.00	L.F.	\$1,094.16	21.3%	23.8%	\$1,642.58	\$2,202	\$7.34
	Fire alarm cable, FEP teflon, 150 V, to 200 Deg.C, #18, 2 pair Fire alarm cable, FEP teflon, 150 V, to 200 Deg.C, #22, 2 pair	10.00	C.L.F.	\$4,550.88	21.3%	23.8%	\$6,831.89	\$9,157	\$915.75
	Programing and testing	5.00 1.00	LS	\$2,624.69 \$937.04	21.3% 21.3%	23.8%	\$3,940.26 \$1,406.71	\$5,282 \$1,886	\$1,056.30
	Outlet boxes, cast, 1 gang, FS, 3/4" hub, 2" deep	10.00	Ea.	\$1,036.62	21.3%	23.8%	\$1,556.20	\$2,086	\$208.59
	Unshielded twisted pair (UTP) jack, RJ45, category 6	20.00	Ea.	\$377.54	21.3%	23.8%	\$566.78	\$760	\$37.99
	Closed circuit television system (CCTV), industrial quality, for weatherproof camera station, add Cat-6 cable	10.00 1,500.00	Ea. L.F.	\$13,748.26 \$18,750.00	21.3% 21.3%	23.8% 23.8%	\$20,639.23 \$28,147.97	\$27,665 \$37,730	\$2,766.48 \$25.15
389	INTEGRATION AUTOMATION	1,500.00	L.F.	\$18,750.00	21.3%	23.8%	\$147,848	\$198,176	\$25.15
	Cat-6 cable	6,000.00	L.F.	\$75,000.00	21.3%	23.8%	\$112,591.89	\$150,918	\$25.15
	Outlet boxes, cast, 1 gang, FS, 3/4" hub, 2" deep	60.00	Ea.	\$6,219.71	21.3%	23.8%	\$9,337.19	\$12,516	\$208.59
	Unshielded twisted pair (UTP) jack, RJ45, category 6	120.00	Ea.	\$2,265.26	21.3%	23.8%	\$3,400.67	\$4,558	\$37.99
202	BMC panel and aguinment for HVAC	1.00	10	¢1E 000 00	21 20/	22.00/	¢22 E10 20	¢20.104	
393 394	BMS panel and equipment for HVAC EQUIPMENT AND FURNISHINGS	1.00 1	LS LS	\$15,000.00 \$232.272	21.3% 21.3%	23.8% 23.8%	\$22,518.38 \$348.692	\$30,184 \$467.387	
	EQUIPMENT AND FURNISHINGS	1.00 1	LS LS	\$232,272	21.3%	23.8%	\$348,692	\$467,387	
394		1.00 1 1 1	LS						
394 395 396 397	EQUIPMENT AND FURNISHINGS FURNISHINGS CASEWORK Private Breakroom casework and countertop	1 1 1 17.00	LS LS LS L.F.	\$232,272 \$207,272 \$27,635 \$5,938.57	21.3% 21.3% 21.3% 21.3%	23.8% 23.8% 23.8%	\$348,692 \$311,161 \$41,486 \$8,915.12	\$467,387 \$417,081 \$55,607 \$11,950	\$702.93
394 395 396 397 398	EQUIPMENT AND FURNISHINGS FURNISHINGS CASEWORK Private Breakroom casework and countertop Shared Space casework and countertop	1 1 17.00 32.00	LS LS LS L.F.	\$232,272 \$207,272 \$27,635 \$5,938.57 \$10,698.48	21.3% 21.3% 21.3% 21.3% 21.3%	23.8% 23.8% 23.8% 23.8% 23.8%	\$348,692 \$311,161 \$41,486 \$8,915.12 \$16,060.82	\$467,387 \$417,081 \$55,607 \$11,950 \$21,528	\$702.93 \$672.75
394 395 396 397 398 399	EQUIPMENT AND FURNISHINGS FURNISHINGS CASEWORK Private Breakroom casework and countertop Shared Space casework and countertop Shared Space island casework and countertop	1 1 1 17.00	LS LS LS L.F. L.F.	\$232,272 \$207,272 \$27,635 \$5,938.57 \$10,698.48 \$10,997.46	21.3% 21.3% 21.3% 21.3% 21.3% 21.3%	23.8% 23.8% 23.8% 23.8% 23.8% 23.8%	\$348,692 \$311,161 \$41,486 \$8,915.12 \$16,060.82 \$16,509.66	\$467,387 \$417,081 \$55,607 \$11,950 \$21,528 \$22,130	
394 395 396 397 398 399 400	EQUIPMENT AND FURNISHINGS FURNISHINGS CASEWORK Private Breakroom casework and countertop Shared Space casework and countertop	1 1 17.00 32.00	LS LS LS L.F.	\$232,272 \$207,272 \$27,635 \$5,938.57 \$10,698.48	21.3% 21.3% 21.3% 21.3% 21.3%	23.8% 23.8% 23.8% 23.8% 23.8%	\$348,692 \$311,161 \$41,486 \$8,915.12 \$16,060.82	\$467,387 \$417,081 \$55,607 \$11,950 \$21,528	
394 395 396 397 398 399 400 401 402	EQUIPMENT AND FURNISHINGS FURNISHINGS CASEWORK Private Breakroom casework and countertop Shared Space casework and countertop Shared Space island casework and countertop FURNITURE Corner Decks Cardenza	1 17.00 32.00 1.00 1 6.00 6.00	LS LS L.F. L.F. LS Ea. Ea.	\$232,272 \$207,272 \$27,635 \$5,938.57 \$10,698.48 \$10,997.46 \$179,637 \$22,884.66 \$12,192.33	21.3% 21.3% 21.3% 21.3% 21.3% 21.3% 21.3% 21.3%	23.8% 23.8% 23.8% 23.8% 23.8% 23.8% 23.8% 23.8%	\$348,692 \$311,161 \$41,486 \$8,915.12 \$16,060.82 \$16,509.66 \$269,676 \$34,355.03 \$18,303.44	\$467,387 \$417,081 \$55,607 \$11,950 \$21,528 \$22,130 \$361,473 \$46,050 \$24,534	\$672.75 \$7,674.92 \$4,088.99
394 395 396 397 398 399 400 401 402 403	EQUIPMENT AND FURNISHINGS FURNISHINGS CASEWORK Private Breakroom casework and countertop Shared Space casework and countertop Shared Space island casework and countertop FURNITURE Corner Decks Cardenza Small Conference Tables	1 1 17.00 32.00 1.00 1.00 6.00 6.00 30.00	LS LS L.F. L.F. LS Ea. Ea. Ea.	\$232,272 \$207,272 \$27,635 \$5,938.57 \$10,698.48 \$10,997.46 \$179,637 \$22,884.66 \$12,192.33 \$25,980.83	21.3% 21.3% 21.3% 21.3% 21.3% 21.3% 21.3% 21.3% 21.3%	23.8% 23.8% 23.8% 23.8% 23.8% 23.8% 23.8% 23.8% 23.8%	\$348,692 \$311,161 \$41,486 \$8,915.12 \$16,060.82 \$16,509.66 \$269,676 \$34,355.03 \$18,303.44 \$39,003.08	\$467,387 \$417,081 \$55,607 \$11,950 \$21,528 \$22,130 \$361,473 \$46,050 \$24,534 \$52,280	\$672.75 \$7,674.92 \$4,088.99 \$1,742.66
394 395 396 397 398 399 400 401 402 403 404	EQUIPMENT AND FURNISHINGS FURNISHINGS CASEWORK Private Breakroom casework and countertop Shared Space casework and countertop Shared Space island casework and countertop FURNITURE Corner Decks Cardenza Small Conference Tables Large Conference Tables	1 1 17.00 32.00 1.00 6.00 6.00 30.00 2.00	LS LS LF. LF. LS Ea. Ea. Ea. Ea.	\$232,272 \$207,272 \$27,635 \$5,938.5 \$10,698.48 \$10,997.46 \$179,637 \$22,884.66 \$12,192.33 \$25,980.83 \$6,032.06	21.3% 21.3% 21.3% 21.3% 21.3% 21.3% 21.3% 21.3% 21.3% 21.3%	23.8% 23.8% 23.8% 23.8% 23.8% 23.8% 23.8% 23.8% 23.8% 23.8%	\$348,692 \$311,161 \$41,486 \$8,915.12 \$16,060.82 \$16,509.66 \$269,676 \$18,303.44 \$39,003.08 \$9,055.47	\$467,387 \$417,081 \$55,607 \$11,950 \$21,528 \$22,130 \$361,473 \$46,050 \$24,534 \$52,280 \$12,138	\$672.75 \$7,674.92 \$4,088.99 \$1,742.66 \$6,068.98
394 395 396 397 398 399 400 401 402 403 404 405	EQUIPMENT AND FURNISHINGS FURNISHINGS CASEWORK Private Breakroom casework and countertop Shared Space casework and countertop Shared Space island casework and countertop FURNITURE Corner Decks Cardenza Small Conference Tables	1 1 17.00 32.00 1.00 1.00 6.00 6.00 30.00	LS LS L.F. L.F. LS Ea. Ea. Ea.	\$232,272 \$207,272 \$27,635 \$5,938.57 \$10,698.48 \$10,997.46 \$179,637 \$22,884.66 \$12,192.33 \$25,980.83	21.3% 21.3% 21.3% 21.3% 21.3% 21.3% 21.3% 21.3% 21.3%	23.8% 23.8% 23.8% 23.8% 23.8% 23.8% 23.8% 23.8% 23.8%	\$348,692 \$311,161 \$41,486 \$8,915.12 \$16,060.82 \$16,509.66 \$269,676 \$34,355.03 \$18,303.44 \$39,003.08	\$467,387 \$417,081 \$55,607 \$11,950 \$21,528 \$22,130 \$361,473 \$46,050 \$24,534 \$52,280	\$672.75 \$7,674.92 \$4,088.99 \$1,742.66
394 395 396 397 398 399 400 401 402 403 404 405 406	EQUIPMENT AND FURNISHINGS FURNISHINGS CASEWORK Private Breakroom casework and countertop Shared Space casework and countertop Shared Space island casework and countertop FURNITURE Corner Decks Cardenza Small Conference Tables Large Conference Tables Uffice Desk Tall Storage Cabinet Breakroom Tables Breakroom Tables	1 17.00 32.00 1.00 6.00 30.00 2.00 13.00 33.00 4.00	LS LS LS LF. LF. LS Ea. Ea. Ea. Ea. Ea. Ea. Ea.	\$232,272 \$207,272 \$27,635 \$5,938.57 \$10,698.48 \$10,997.46 \$179,637 \$22,884.66 \$12,192.33 \$25,980.83 \$6,032.06 \$10,375.08 \$60,986.74 \$2,064.11	21.3% 21.3% 21.3% 21.3% 21.3% 21.3% 21.3% 21.3% 21.3% 21.3% 21.3% 21.3% 21.3%	23.8% 23.8% 23.8% 23.8% 23.8% 23.8% 23.8% 23.8% 23.8% 23.8% 23.8% 23.8% 23.8% 23.8%	\$348,692 \$311,161 \$41,486 \$8,915.12 \$16,606.82 \$16,509.66 \$269,676 \$34,355.03 \$18,303.44 \$39,003.08 \$9,055.47 \$15,575.33 \$91,554.83 \$3,098.70	\$467,387 \$417,081 \$55,607 \$11,950 \$21,528 \$22,130 \$46,050 \$24,534 \$52,280 \$12,138 \$20,877 \$122,720 \$41,53	\$672.75 \$7,674.92 \$4,088.99 \$1,742.66 \$6,068.98 \$1,605.94 \$3,718.79 \$1,038.37
394 395 396 397 398 399 400 401 402 403 404 405 406 407 408	EQUIPMENT AND FURNISHINGS FURNISHINGS CASEWORK Private Breakroom casework and countertop Shared Space casework and countertop Shared Space island casework and countertop FURNITURE Corner Decks Cardenza Small Conference Tables Large Conference Tables Large Conference Tables Breakroom Tables Breakroom Tables Breakroom Tables Breakroom Tables	1 17.00 32.00 1.00 1.00 6.00 30.00 2.00 13.00 4.00 8.00	LS LS L.F. L.F. LS Ea.	\$232,272 \$207,272 \$27,635 \$5,938.57 \$10,698.48 \$10,997.46 \$179,637 \$22,884.66 \$12,192.33 \$5,980.83 \$6,032.06 \$10,375.08 \$60,986.74 \$2,064.11 \$1,608.22	21.3% 21.3% 21.3% 21.3% 21.3% 21.3% 21.3% 21.3% 21.3% 21.3% 21.3% 21.3% 21.3%	23.8% 23.8% 23.8% 23.8% 23.8% 23.8% 23.8% 23.8% 23.8% 23.8% 23.8% 23.8% 23.8% 23.8% 23.8%	\$348,692 \$311,161 \$41,486 \$8,915.12 \$16,060.82 \$16,509.66 \$269,676 \$34,355.03 \$18,303.44 \$39,003.08 \$9,055.47 \$15,575.33 \$91,554.83 \$3,098.70 \$2,414.30	\$467,387 \$417,081 \$55,607 \$11,950 \$21,528 \$22,130 \$361,473 \$46,050 \$24,534 \$52,280 \$12,138 \$20,877 \$122,720 \$4,153 \$3,236	\$672.75 \$7,674.92 \$4,088.99 \$1,742.66 \$6,068.98 \$1,605.94 \$3,718.79 \$1,038.37 \$404.52
394 395 396 397 398 399 400 401 402 403 404 405 406 407 408	EQUIPMENT AND FURNISHINGS FURNISHINGS CASEWORK Private Breakroom casework and countertop Shared Space casework and countertop Shared Space island casework and countertop FURNITURE Corner Decks Cardenza Small Conference Tables Large Conference Tables Uffice Desk Tall Storage Cabinet Breakroom Tables Breakroom Tables	1 17.00 32.00 1.00 6.00 30.00 2.00 13.00 33.00 4.00	LS LS LS LF. LF. LS Ea. Ea. Ea. Ea. Ea. Ea. Ea.	\$232,272 \$207,272 \$27,635 \$5,938.57 \$10,698.48 \$10,997.46 \$12,192.33 \$25,980.83 \$6,032.06 \$10,375.08 \$60,986.74 \$2,064.11 \$1,608.22 \$37,513.05	21.3% 21.3% 21.3% 21.3% 21.3% 21.3% 21.3% 21.3% 21.3% 21.3% 21.3% 21.3% 21.3%	23.8% 23.8% 23.8% 23.8% 23.8% 23.8% 23.8% 23.8% 23.8% 23.8% 23.8% 23.8% 23.8% 23.8%	\$348,692 \$311,161 \$41,486 \$8,915.12 \$16,606.82 \$16,509.66 \$269,676 \$34,355.03 \$18,303.44 \$39,003.08 \$9,055.47 \$15,575.33 \$91,554.83 \$3,098.70	\$467,387 \$417,081 \$55,607 \$11,950 \$21,528 \$22,130 \$46,050 \$24,534 \$52,280 \$12,138 \$20,877 \$122,720 \$41,53	\$672.75 \$7,674.92 \$4,088.99 \$1,742.66 \$6,068.98 \$1,605.94 \$3,718.79 \$1,038.37
394 395 396 397 398 399 400 401 402 403 404 405 406 407 408 409	EQUIPMENT AND FURNISHINGS FURNISHINGS CASEWORK Private Breakroom casework and countertop Shared Space casework and countertop Shared Space island casework and countertop FURNITURE Corner Decks Cardenza Small Conference Tables Large Conference Tables Large Conference Tables Tall Storage Cabinet Breakroom Tables Breakroom Tables Breakroom Tables Breakroom Tables Breakroom Chair Task Chair	1 17.00 32.00 1.00 1.00 6.00 30.00 2.00 13.00 4.00 8.00	LS LS L.F. L.F. LS Ea.	\$232,272 \$207,272 \$27,635 \$5,938.57 \$10,698.48 \$10,997.46 \$179,637 \$22,884.66 \$12,192.33 \$5,098.73 \$6,032.06 \$10,375.08 \$60,986.74 \$1,608.22 \$37,513.05 \$2,064.11 \$1,608.22 \$37,513.05	21.3% 21.3% 21.3% 21.3% 21.3% 21.3% 21.3% 21.3% 21.3% 21.3% 21.3% 21.3% 21.3% 21.3% 21.3%	23.8% 23.8% 23.8% 23.8% 23.8% 23.8% 23.8% 23.8% 23.8% 23.8% 23.8% 23.8% 23.8% 23.8% 23.8% 23.8% 23.8%	\$348,692 \$311,161 \$41,486 \$8,915.12 \$16,060.82 \$16,509.66 \$246,355.03 \$18,303.44 \$39,003.08 \$9,055.47 \$15,575.33 \$91,554.83 \$3,098.70 \$2,414.35 \$2,414.35 \$3,098.70	\$467,387 \$417,081 \$55,607 \$11,950 \$21,528 \$22,130 \$361,473 \$46,050 \$24,534 \$52,280 \$12,138 \$20,877 \$122,720 \$4,153 \$3,326 \$75,485	\$672.75 \$7,674.92 \$4,088.99 \$1,742.66 \$6,068.98 \$1,605.94 \$3,718.79 \$1,038.37 \$404.52
394 395 396 397 398 399 400 401 402 403 404 405 406 407 408 409 410 411	EQUIPMENT AND FURNISHINGS FURNISHINGS CASEWORK Private Breakroom casework and countertop Shared Space casework and countertop Shared Space island casework and countertop FURNITURE Corner Decks Cardenza Small Conference Tables Large Conference Tables Large Conference Tables Breakroom Tables	1 1 1 1 1 1 1 1 1 1 1 1 1 1 1 1 1 1 1	LS LS LF. LF. LF. Ea. Ea. Ea. Ea. Ea. Ea. Ea. Ea. Ea. Ea	\$232,272 \$207,272 \$27,635 \$5,938.57 \$10,698.48 \$10,997.46 \$12,192.33 \$25,980.83 \$6,032.06 \$10,375.08 \$60,320.66 \$10,375.08 \$20,064.11 \$1,608.22 \$37,513.05 \$25,000.00	21.3% 21.3% 21.3% 21.3% 21.3% 21.3% 21.3% 21.3% 21.3% 21.3% 21.3% 21.3% 21.3% 21.3% 21.3% 21.3% 21.3% 21.3%	23.8% 23.8% 23.8% 23.8% 23.8% 23.8% 23.8% 23.8% 23.8% 23.8% 23.8% 23.8% 23.8% 23.8% 23.8% 23.8% 23.8%	\$348,692 \$311,161 \$41,486 \$8,915.12 \$16,060.82 \$16,509.66 \$269,676 \$34,355.03 \$18,303.44 \$39,055.47 \$15,575.33 \$91,554.83 \$3,098.70 \$2,414.30 \$56,315.53 \$37,531 \$14,261.64 \$3,002.45	\$467,387 \$417,081 \$55,607 \$11,950 \$21,528 \$22,130 \$361,473 \$46,050 \$24,534 \$52,280 \$12,138 \$20,877 \$122,720 \$4,153 \$3,236 \$75,485 \$50,810 \$19,116	\$672.75 \$7,674.92 \$4,088.99 \$1,742.66 \$6,068.98 \$1,605.94 \$3,718.79 \$1,038.37 \$404.52 \$686.23
394 395 396 397 398 399 400 401 402 403 404 405 406 407 407 410 411 412 413	EQUIPMENT AND FURNISHINGS FURNISHINGS CASEWORK Private Breakroom casework and countertop Shared Space casework and countertop Shared Space island casework and countertop FURNITURE Corner Decks Cardenza Small Conference Tables Large Conference Tables Office Desk Tall Storage Cabinet Breakroom Tables Breakroom Tables Breakroom Chair Task Chair EQUIPMENT Copy Machine Refrigerator Dish Washer	1 1 1 1 1 1 1 1 1 1 1 1 1 1 1 1 1 1 1	LS LS LF. LF. LF. LS Ea.	\$232,272 \$207,272 \$27,635 \$5,938.57 \$10,698.48 \$10,997.46 \$12,192.33 \$6,032.06 \$10,375.08 \$60,986.74 \$2,064.11 \$1,608.22 \$37,513.05 \$25,980.00 \$10,200.00 \$10,000.00 \$10,000.00 \$10,000.00 \$10,000.00 \$10,000.00 \$10,000.00	21.3% 21.3% 21.3% 21.3% 21.3% 21.3% 21.3% 21.3% 21.3% 21.3% 21.3% 21.3% 21.3% 21.3% 21.3% 21.3% 21.3% 21.3% 21.3% 21.3%	23.8% 23.8% 23.8% 23.8% 23.8% 23.8% 23.8% 23.8% 23.8% 23.8% 23.8% 23.8% 23.8% 23.8% 23.8% 23.8% 23.8% 23.8% 23.8%	\$348,692 \$311,161 \$41,486 \$8,915.12 \$16,060.82 \$16,509.66 \$269,676 \$34,355.03 \$18,303.44 \$39,003.08 \$9,055.47 \$15,575.33 \$1,554.83 \$3,098.70 \$2,414.30 \$56,315.55 \$37,531 \$14,261.64 \$3,002.45 \$2,251.84	\$467,387 \$417,081 \$55,607 \$11,950 \$21,528 \$22,130 \$46,050 \$24,534 \$52,280 \$12,138 \$20,877 \$122,720 \$4,153 \$3,236 \$75,485 \$50,306 \$19,116 \$4,024	\$672.75 \$7,674.92 \$4,088.99 \$1,742.66 \$6,068.98 \$1,605.94 \$3,718.79 \$1,038.37 \$404.52 \$686.23
394 395 396 397 398 399 400 401 402 403 404 405 406 407 407 410 411 412 413	EQUIPMENT AND FURNISHINGS FURNISHINGS CASEWORK Private Breakroom casework and countertop Shared Space casework and countertop Shared Space island casework and countertop FURNITURE Corner Decks Cardenza Small Conference Tables Large Conference Tables Large Conference Tables Breakroom Tables	1 1 1 1 1 1 1 1 1 1 1 1 1 1 1 1 1 1 1	LS LS LF. LF. LF. LS Ea.	\$232,272 \$207,272 \$27,635 \$5,938.57 \$10,698.48 \$10,997.46 \$12,192.33 \$25,980.83 \$6,032.06 \$10,375.08 \$60,320.66 \$10,375.08 \$20,064.11 \$1,608.22 \$37,513.05 \$25,000.00	21.3% 21.3%	23.8% 23.8%	\$348,692 \$311,161 \$41,486 \$8,915.12 \$16,060.82 \$16,509.66 \$269,676 \$34,355.03 \$18,303.44 \$39,003.08 \$9,055.47 \$15,575.33 \$91,554.83 \$3,098.70 \$2,414.30 \$56,315.53 \$37,531 \$14,261.64 \$3,002.45 \$2,251.84 \$18,014.70	\$467,387 \$417,081 \$55,607 \$11,950 \$21,528 \$22,130 \$361,473 \$46,050 \$24,534 \$52,280 \$12,138 \$20,877 \$122,720 \$4,153 \$3,236 \$75,485 \$50,810 \$19,116	\$672.75 \$7,674.92 \$4,088.99 \$1,742.66 \$6,068.98 \$1,605.94 \$3,718.79 \$1,038.37 \$404.52 \$686.23
394 395 396 397 398 399 400 401 402 403 404 405 406 407 408 409 411 411 411 413 414	EQUIPMENT AND FURNISHINGS FURNISHINGS CASEWORK Private Breakroom casework and countertop Shared Space casework and countertop Shared Space island casework and countertop FURNITURE Corner Decks Cardenza Small Conference Tables Large Conference Tables Office Desk Tall Storage Cabinet Breakroom Tables Breakroom Tables Breakroom Tables Breakroom Ablic Tables Breakroom Tables Breakroom Storage Cabinet Breakroom Tables Breakroom Chair Task Chair EQUIPMENT Copy Machine Refrigerator Dish Washer Secured Storage - Allowance SPECIAL CONSTRUCTION AND DEMOLITION	1 1 1 1 1 1 1 1 1 1 1 1 1 1 1 1 1 1 1	LS LS LF. LF. LS Ea.	\$232,272 \$207,272 \$27,635 \$5,938.57 \$10,698.48 \$10,997.46 \$179,637 \$22,884.66 \$12,192.33 \$5,032.06 \$10,375.08 \$6,032.06 \$10,375.08 \$6,0986.74 \$2,064.11 \$1,608.22 \$37,513.05 \$25,000.00 \$2,000.00 \$1,500.00 \$12,000.00	21.3% 21.3% 21.3% 21.3% 21.3% 21.3% 21.3% 21.3% 21.3% 21.3% 21.3% 21.3% 21.3% 21.3% 21.3% 21.3% 21.3% 21.3% 21.3% 21.3%	23.8% 23.8% 23.8% 23.8% 23.8% 23.8% 23.8% 23.8% 23.8% 23.8% 23.8% 23.8% 23.8% 23.8% 23.8% 23.8% 23.8% 23.8% 23.8%	\$348,692 \$311,161 \$41,486 \$8,915.12 \$16,060.82 \$16,509.66 \$269,676 \$34,355.03 \$18,303.44 \$39,003.08 \$9,055.47 \$15,575.33 \$1,554.83 \$3,098.70 \$2,414.30 \$56,315.55 \$37,531 \$14,261.64 \$3,002.45 \$2,251.84	\$467,387 \$417,081 \$55,607 \$11,950 \$21,528 \$22,130 \$361,473 \$46,050 \$24,534 \$52,280 \$12,138 \$20,877 \$122,720 \$4,153 \$3,236 \$75,485 \$50,306 \$19,116 \$4,024 \$3,018	\$672.75 \$7,674.92 \$4,088.99 \$1,742.66 \$6,068.98 \$1,605.94 \$3,718.79 \$1,038.37 \$404.52 \$686.23
394 395 396 397 398 399 400 401 402 403 404 405 406 407 408 409 410 411 411 411 413 414 415	EQUIPMENT AND FURNISHINGS FURNISHINGS CASEWORK Private Breakroom casework and countertop Shared Space casework and countertop Shared Space island casework and countertop FURNITURE Corner Decks Cardenza Small Conference Tables Large Conference Tables Urge Conference Tables Urge Conference Tables Breakroom Tables Breakroom Tables Breakroom Chair Task Chair EQUIPMENT Copy Machine Refrigerator Dish Washer Secured Storage - Allowance SPECIAL CONSTRUCTION AND DEMOLITION SPECIAL CONSTRUCTION AND DEMOLITION	1 1 1 1 1 1 1 1 1 1 1 1 1 1 1 1 1 1 1	LS LS L.F. L.F. L.F. Ea. Ea. Ea. Ea. Ea. Ea. Ea. Ea. Ea. Ea	\$232,272 \$207,272 \$27,635 \$5,938.57 \$10,698.48 \$10,997.46 \$179,637 \$22,884.66 \$12,192.33 \$6,032.06 \$10,375.08 \$60,986.74 \$2,064.11 \$1,608.22 \$37,513.05 \$25,000 \$9,500.00 \$1,500.00 \$12,000.00 \$12,000.00 \$12,000.00 \$12,000.00 \$12,000.00 \$12,000.00 \$12,000.00 \$12,000.00 \$12,000.00 \$12,000.00 \$12,000.00 \$12,000.00	21.3% 21.3%	23.8% 23.8%	\$348,692 \$311,161 \$41,486 \$8,915.12 \$16,060.82 \$16,509.66 \$34,355.03 \$18,303.44 \$39,005.47 \$15,575.33 \$91,554.83 \$30,98.70 \$2,414.30 \$56,315.53 \$14,261.64 \$3,002.45 \$2,255.84 \$18,014.70 \$18,014.70 \$18,014.70 \$19,2,668	\$467,387 \$417,081 \$55,607 \$11,950 \$21,528 \$22,130 \$361,473 \$46,050 \$24,534 \$52,280 \$122,720 \$41,153 \$3,236 \$75,485 \$50,306 \$19,116 \$4,024 \$3,018 \$23,4147	\$7,674.92 \$4,088.99 \$1,742.66 \$6,068.98 \$1,605.94 \$3,718.79 \$1,038.37 \$404.52 \$686.23
394 395 396 397 398 400 401 402 403 404 405 406 407 411 412 413 414 415 416 417 418	EQUIPMENT AND FURNISHINGS FURNISHINGS CASEWORK Private Breakroom casework and countertop Shared Space casework and countertop Shared Space island casework and countertop Shared Space island casework and countertop FURNITURE Corner Decks Cardenza Small Conference Tables Large Conference Tables Large Conference Tables Large Conference Tables Breakroom Tables Breakroom Tables Breakroom Tables Breakroom Chair Task Chair EQUIPMENT Copy Machine Refrigerator Dish Washer Secured Storage - Allowance SPECIAL CONSTRUCTION AND DEMOLITION SIDEWALK CANOPY Sidewalk canopy allowance	1 1 1 1 1 1 1 1 1 1 1 1 1 1 1 1 1 1 1	LS LS LS L.F. L.F. L.F. LS Ea.	\$232,272 \$207,272 \$207,272 \$27,635 \$5,938.57 \$10,698.48 \$10,997.46 \$12,982.33 \$5,032.06 \$12,192.33 \$5,032.06 \$10,375.08 \$60,986.74 \$1,608.22 \$37,513.05 \$9,500.00 \$2,000.00 \$1,500.00 \$1,500.00 \$1,500.00 \$1,200.00 \$1,200.00 \$1,200.00 \$1,5	21.3% 21.3%	23.8% 23.8%	\$348,692 \$311,161 \$41,486 \$8,915.12 \$16,060.82 \$16,509.66 \$269,676 \$34,355.03 \$18,303.44 \$39,003.08 \$9,055.47 \$15,575.33 \$91,554.83 \$3,098.70 \$2,414.30 \$56,315.53 \$14,261.64 \$3,002.45 \$2,251.84 \$18,014.70 \$192,268 \$92,955.86	\$467,387 \$417,081 \$55,607 \$11,950 \$21,528 \$22,130 \$46,050 \$24,534 \$52,280 \$12,138 \$20,877 \$122,720 \$4,153 \$3,236 \$75,485 \$50,306 \$19,116 \$4,024 \$3,018 \$24,147 \$257,716 \$124,598	\$672.75 \$7,674.92 \$4,088.99 \$1,742.66 \$6,068.98 \$1,605.94 \$3,718.79 \$1,038.37 \$404.52 \$686.23
394 395 396 397 398 399 400 401 402 403 404 405 407 408 409 410 411 412 413 414 415 416 417 418	EQUIPMENT AND FURNISHINGS FURNISHINGS CASEWORK Private Breakroom casework and countertop Shared Space casework and countertop Shared Space casework and countertop FURNITURE Corner Decks Cardenza Small Conference Tables Large Conference Tables Large Conference Tables Harge Conference Tables Tall Storage Cabinet Breakroom Tables Breakroom Table	1 1 1 1 1 1 1 1 1 1 1 1 1 1 1 1 1 1 1	LS LS LF. LF. LF. LS LS LS LS Ea. Ea. Ea. Ea. Ea. Ea. Ea. Ea. Ea. LS Ea.	\$232,272 \$207,272 \$207,272 \$27,635 \$5,938.57 \$10,698.48 \$10,997.46 \$179,637 \$22,884.66 \$12,192.33 \$52,980.83 \$6,032.06 \$10,375.08 \$60,932.06 \$10,375.08 \$50,986.74 \$2,064.11 \$1,608.22 \$37,513.05 \$25,000.00 \$12,	21.3% 21.3%	23.8% 23.8%	\$348,692 \$311,161 \$41,486 \$8,915.12 \$16,060.82 \$16,509.66 \$269,676 \$34,355.03 \$18,303.44 \$39,003.08 \$9,055.47 \$15,575.33 \$91,554.83 \$3,098.70 \$2,414.30 \$56,315.53 \$3,002.45 \$2,251.84 \$18,014.70 \$192,268 \$92,956 \$92,955.86 \$92,955.86 \$92,955.86	\$467,387 \$417,081 \$55,607 \$11,950 \$21,528 \$22,130 \$46,050 \$24,534 \$52,280 \$12,138 \$20,877 \$122,720 \$4,153 \$3,236 \$75,885 \$50,306 \$19,116 \$4,024 \$3,018 \$24,147 \$257,716 \$124,598 \$124,598 \$124,598 \$124,598	\$7,674.92 \$4,088.99 \$1,742.66 \$6,068.98 \$1,605.94 \$3,718.79 \$1,038.37 \$404.52 \$686.23
394 395 396 397 398 398 400 401 402 403 404 405 406 407 407 408 410 411 412 413 414 415 416 417 418 419 419 419 419 419 419 419 419 419 419	EQUIPMENT AND FURNISHINGS FURNISHINGS CASEWORK Private Breakroom casework and countertop Shared Space casework and countertop Shared Space casework and countertop FURNITURE Corner Decks Cardenza Small Conference Tables Large Conference Tables Office Desk Tall Storage Cablinet Breakroom Tables Breakroom Tables Breakroom Chair Task Chair EQUIPMENT Copy Machine Refrigerator Dish Washer Secured Storage - Allowance SPECIAL CONSTRUCTION AND DEMOLITION SPECIAL CONSTRUCTION AND DEMOLITION SIDEWALK CANOPY Sidewalk canopy allowance DEMOLITICAL DEMOLITICAL ARCHITECTURAL	1 1 1 1 1 1 1 1 1 1 1 1 1 1 1 1 1 1 1	LS LS LS L.F. L.F. L.F. LS Ea.	\$232,272 \$207,272 \$207,272 \$27,635 \$5,938.57 \$10,698.48 \$10,997.46 \$179,637 \$22,884.66 \$12,192.33 \$5,032.06 \$10,375.08 \$50,986.74 \$2,064.11 \$1,608.22 \$37,513.05 \$25,000.00 \$1,5	21.3% 21.3%	23.8% 23.8%	\$348,692 \$311,161 \$41,486 \$8,915.12 \$16,060.82 \$16,509.66 \$34,355.03 \$18,303.44 \$39,003.08 \$9,055.47 \$15,575.33 \$31,554.83 \$3,098.70 \$2,414.30 \$56,315.57 \$33,098.70 \$2,414.30 \$56,315.25 \$4,261.64 \$3,002.45 \$12,251.84 \$18,014.70 \$192,268 \$92,955.86 \$92,955.86	\$467,387 \$417,081 \$55,607 \$11,950 \$21,528 \$22,130 \$46,050 \$24,534 \$52,280 \$12,138 \$20,877 \$122,720 \$4,153 \$3,236 \$19,116 \$4,024 \$3,018 \$24,147 \$257,716 \$124,598 \$124,598 \$124,598 \$124,598 \$124,598 \$124,598	\$7,674.92 \$4,088.99 \$1,742.66 \$6,068.98 \$1,605.94 \$3,718.79 \$1,038.37 \$404.52 \$686.23
394 395 396 397 398 399 400 401 402 403 404 405 406 407 411 412 413 414 415 416 417 418 419 420 421	EQUIPMENT AND FURNISHINGS FURNISHINGS CASEWORK Private Breakroom casework and countertop Shared Space casework and countertop Shared Space casework and countertop FURNITURE Corner Decks Cardenza Small Conference Tables Large Conference Tables Large Conference Tables Harge Conference Tables Tall Storage Cabinet Breakroom Tables Breakroom Table	1 1 1 1 1 1 1 1 1 1 1 1 1 1 1 1 1 1 1	LS LS LF. LF. LF. LS LS LS LS Ea. Ea. Ea. Ea. Ea. Ea. Ea. Ea. Ea. LS Ea.	\$232,272 \$207,272 \$207,272 \$27,635 \$5,938.57 \$10,698.48 \$10,997.46 \$179,637 \$22,884.66 \$12,192.33 \$52,980.83 \$6,032.06 \$10,375.08 \$60,932.06 \$10,375.08 \$50,986.74 \$2,064.11 \$1,608.22 \$37,513.05 \$25,000.00 \$12,	21.3% 21.3%	23.8% 23.8%	\$348,692 \$311,161 \$41,486 \$8,915.12 \$16,060.82 \$16,509.66 \$269,676 \$34,355.03 \$18,303.44 \$39,003.08 \$9,055.47 \$15,575.33 \$91,554.83 \$3,098.70 \$2,414.30 \$56,315.53 \$3,002.45 \$2,251.84 \$18,014.70 \$192,268 \$92,956 \$92,955.86 \$92,955.86 \$92,955.86	\$467,387 \$417,081 \$55,607 \$11,950 \$21,528 \$22,130 \$46,050 \$24,534 \$52,280 \$12,138 \$20,877 \$122,720 \$4,153 \$3,236 \$75,885 \$50,306 \$19,116 \$4,024 \$3,018 \$24,147 \$257,716 \$124,598 \$124,598 \$124,598 \$124,598	\$7,674.92 \$4,088.99 \$1,742.66 \$6,068.98 \$1,605.94 \$3,718.79 \$1,038.37 \$404.52 \$686.23
394 395 396 397 398 399 400 401 402 405 406 407 410 411 412 413 414 415 416 417 417 418 419 420 421 421 422 423	EQUIPMENT AND FURNISHINGS FURNISHINGS CASEWORK Private Breakroom casework and countertop Shared Space casework and countertop Shared Space island casework and countertop FURNITURE Corner Decks Cardenza Small Conference Tables Large Conference Tables Unference T	1 1 1 1 1 1 1 1 1 1 1 1 1 1 1 1 1 1 1	LS LS LS LF. L.F. LS Ea. Ea. Ea. Ea. Ea. Ea. LS Ea. Ea. Ea. Es. Es. Es. Es. Es. Es. Es. Es. Es. Es	\$232,272 \$207,272 \$207,272 \$27,635 \$5,938.57 \$10,698.48 \$10,997.46 \$12,192.33 \$6,032.06 \$12,192.33 \$6,032.06 \$10,375.08 \$20,986.74 \$2,064.11 \$1,608.22 \$37,513.00 \$1,500.00 \$1,5	21.3% 21.3%	23.8% 23.8%	\$348,692 \$311,161 \$41,486 \$8,915.12 \$16,060.82 \$16,509.66 \$34,355.03 \$18,303.44 \$39,003.08 \$9,055.47 \$15,575.33 \$31,554.83 \$30,08.70 \$2,414.30 \$56,315.57 \$37,531 \$14,261.64 \$30,002.41 \$192,268 \$92,956 \$92,955.86 \$92,955.86 \$92,955.86 \$92,955.86 \$93,000 \$18,910.05 \$18,910.05 \$366.69	\$467,387 \$417,081 \$55,607 \$11,950 \$21,528 \$22,130 \$46,050 \$24,534 \$52,280 \$12,138 \$20,877 \$122,720 \$4,153 \$3,236 \$15,4153 \$3,236 \$19,116 \$4,024 \$3,018 \$24,147 \$124,598 \$124,598 \$124,598 \$124,598 \$124,598 \$124,598 \$133,118 \$78,332 \$0,577,716	\$7,674.92 \$4,088.99 \$1,742.66 \$6,068.98 \$1,605.94 \$3,718.79 \$1,038.37 \$404.52 \$686.23 \$9,558.15
394 395 396 397 397 398 399 400 401 402 403 404 405 406 407 411 411 412 413 414 415 416 417 418 419 420 421 422 422 423 424	EQUIPMENT AND FURNISHINGS FURNISHINGS CASEWORK Private Breakroom casework and countertop Shared Space casework and countertop Shared Space island casework and countertop FURNITURE Corner Decks Cardenza Small Conference Tables Large Conference Tables Jarge Conference Tables Office Desk Tall Storage Cabinet Breakroom Tables Breakroom Tables Breakroom Chair Task Chair EQUIPMENT Copy Machine Refrigerator Dish Washer Secured Storage - Allowance SPECIAL CONSTRUCTION AND DEMOLITION SIDEWALK CANOPY Sidewalk canopy allowance DEMOLITION ARCHITECTURAL Note: 1 - Remove Flooring Flooring demolition, remove flooring Flooring demolition, remove flooring Flooring demolition, remove flooring Flooring demolition, tie, ceramic, thin set Note: 2 - Remove Ceilings	1 1 1 1 1 1 1 1 1 1 1 1 1 1 1 1 1 1 1	LS LS LS LF. LF. LF. LS Ea.	\$232,272 \$207,272 \$27,635 \$5,938.57 \$10,698.48 \$10,997.46 \$179,637 \$22,884.66 \$12,192.33 \$5,938.57 \$22,884.66 \$12,192.33 \$5,032.06 \$10,375.08 \$6,032.06 \$10,375.08 \$6,032.06 \$1,500.00 \$2,000.00 \$1,500.00 \$1,500.00 \$12,000.00 \$22,000.00 \$12,000.00 \$12,000.00 \$12,000.00 \$12,000.00 \$12,000.00 \$12,000.00	21.3% 21.3%	23.8% 23.8%	\$348,692 \$311,161 \$41,486 \$8,915.12 \$16,060.82 \$16,509.66 \$269,676 \$34,355.03 \$18,303.44 \$39,005.47 \$15,575.33 \$19,554.83 \$3,098.70 \$2,414.30 \$56,315.53 \$3,002.45 \$12,251.84 \$18,014.70 \$192,268 \$92,955.86 \$92,955.86 \$92,955.86 \$92,955.86 \$93,002.45 \$18,014.70 \$18,	\$467,387 \$417,081 \$55,607 \$11,950 \$21,528 \$22,130 \$46,050 \$24,534 \$52,280 \$12,138 \$20,877 \$122,720 \$4,153 \$3,236 \$75,485 \$50,306 \$19,116 \$4,021 \$24,147 \$257,716 \$124,598 \$124,598 \$124,598 \$124,598 \$124,598 \$25,347 \$78,332	\$7,674.92 \$4,088.99 \$1,742.66 \$6,068.98 \$1,605.94 \$3,718.79 \$1,038.37 \$404.52 \$686.23 \$9,558.15
394 395 396 397 398 399 400 401 405 406 407 408 409 410 411 412 413 414 415 416 417 418 419 420 421 421 422 423 424 425	EQUIPMENT AND FURNISHINGS FURNISHINGS CASEWORK Private Breakroom casework and countertop Shared Space casework and countertop Shared Space casework and countertop FURNITURE Corner Decks Cardenza Small Conference Tables Large Conference Tables Urge Conference Tables Grige Desk Tail Storage Cabinet Breakroom Tables Breakroom Tab	1 1 1 1 1 1 1 1 1 1 1 1 1 1 1 1 1 1 1	LS LS LS LF. LF. LF. LS Ea.	\$232,272 \$207,272 \$207,272 \$27,635 \$5,938.57 \$10,698.48 \$10,997.46 \$179,637 \$22,884.66 \$12,192.33 \$5,980.83 \$6,032.06 \$10,375.08 \$50,986.74 \$2,064.11 \$1,608.22 \$37,513.05 \$25,000 \$9,500.00 \$12,000.0	21.3% 21.3%	23.8% 23.8%	\$348,692 \$311,161 \$41,486 \$8,915.12 \$16,060.82 \$16,509.66 \$269,676 \$34,355.03 \$18,303.44 \$39,003.08 \$9,055.47 \$15,575.33 \$91,554.83 \$3,098.70 \$2,414.30 \$56,315.53 \$33,002.45 \$2,251.84 \$18,014.70 \$192,268 \$92,956 \$92,955.86 \$92,955.86 \$92,955.86 \$93,312 \$366.69 \$0.00 \$18,910.05 \$366.69 \$0.00 \$68,896.36	\$467,387 \$417,081 \$55,607 \$11,950 \$21,528 \$22,130 \$46,050 \$24,534 \$52,280 \$12,138 \$20,877 \$122,720 \$4,153 \$3,236 \$75,485 \$50,306 \$19,116 \$4,024 \$3,018 \$24,147 \$257,716 \$124,598 \$124,598 \$124,598 \$124,598 \$124,598 \$124,598 \$123,118 \$78,332 \$0,600 \$124,598	\$672.75 \$7,674.92 \$4,088.99 \$1,742.66 \$6,068.98 \$1,605.94 \$3,718.79 \$1,038.37 \$404.52 \$686.23 \$9,558.15 \$120.73
394 395 396 397 398 399 400 401 402 403 404 405 406 407 411 412 413 414 415 416 417 418 419 420 421 422 423 424 425 426 427	EQUIPMENT AND FURNISHINGS FURNISHINGS CASEWORK Private Breakroom casework and countertop Shared Space casework and countertop Shared Space island casework and countertop FURNITURE Corner Decks Cardenza Small Conference Tables Large Conference Tables Jarge Conference Tables Office Desk Tall Storage Cabinet Breakroom Tables Breakroom Tables Breakroom Chair Task Chair EQUIPMENT Copy Machine Refrigerator Dish Washer Secured Storage - Allowance SPECIAL CONSTRUCTION AND DEMOLITION SIDEWALK CANOPY Sidewalk canopy allowance DEMOLITION ARCHITECTURAL Note: 1 - Remove Flooring Flooring demolition, temove flooring Flooring demolition, temove flooring Flooring demolition, temove floeling, mineral fiber, on suspension system, remove Ceiling demolition, drywall, on metal frame, 2 layers, 5/8" gypsum board, remove Note: 3 - Demo Partitions	1 1 1 1 1 1 1 1 1 1 1 1 1 1 1 1 1 1 1	LS LS LS LF. LF. LF. LS Ea.	\$232,272 \$207,272 \$207,272 \$27,635 \$5,938.57 \$10,698.48 \$10,997.46 \$12,192.33 \$6,032.06 \$12,192.33 \$6,032.06 \$10,375.08 \$6,032.06 \$10,375.08 \$6,032.06 \$10,375.08 \$6,032.06 \$1,500.00 \$1,500.00 \$1,500.00 \$1,500.00 \$1,500.00 \$1,200.00 \$12,000.00 \$12,000.00 \$12,000.00 \$12,000.00 \$12,000.00 \$12,000.00 \$12,000.00 \$12,596.41 \$38,928 \$30.00 \$12,596.41 \$244.26 \$0.00 \$4,593.82 \$177.55 \$0.00	21.3% 21.3%	23.8% 23.8%	\$348,692 \$311,161 \$41,486 \$8,915.12 \$16,060.82 \$16,509.66 \$269,676 \$34,355.03 \$18,303.44 \$39,005.47 \$15,575.33 \$91,554.83 \$3,002.45 \$3,002.45 \$2,251.84 \$18,014.70 \$192,268 \$92,955.86 \$92,955.86 \$92,955.86 \$92,955.86 \$92,955.86 \$93,002.45 \$93,002.45 \$93,002.45 \$94,000 \$94,000 \$95,000 \$9	\$467,387 \$417,081 \$55,607 \$11,950 \$21,528 \$22,130 \$46,050 \$24,534 \$52,4534 \$52,280 \$12,138 \$20,877 \$122,720 \$4,153 \$3,236 \$75,485 \$50,306 \$19,116 \$4,024 \$3,018 \$24,147 \$257,716 \$124,598	\$7,674.92 \$4,088.99 \$1,742.66 \$6,068.98 \$1,605.94 \$3,718.79 \$1,038.37 \$404.52 \$686.23 \$9,558.15 \$120.73 \$1,20.73
394 395 396 397 398 399 400 401 402 405 406 407 410 411 412 414 415 416 417 418 419 420 421 421 422 423 424 424 425 426 426 427 427 428 428 429 429 429 429 429 429 429 429 429 429	EQUIPMENT AND FURNISHINGS FURNISHINGS CASEWORK Private Breakroom casework and countertop Shared Space casework and countertop Shared Space casework and countertop FURNITURE Corner Decks Cardenza Small Conference Tables Large Conference Tables Large Conference Tables Half Storage Cablinet Breakroom Tables Breakroom Tables Breakroom Tables Breakroom Tables Breakroom Tables Breakroom Chair Task Chair EQUIPMENT Copy Machine Refrigerator Dish Washer Secured Storage - Allowance SPECIAL CONSTRUCTION AND DEMOLITION SPECIAL CONSTRUCTION AND DEMOLITION SPECIAL CONSTRUCTION SIDEWALK CANOPY Sidewalk canopy allowance DEMOLITION ARCHITECTURAL Note: 1 - Remove Flooring Flooring demolition, remove flooring Flooring demolition, suspended ceiling, mineral fiber, on suspension system, remove Ceiling demolition, suspended ceiling, mineral fiber, on suspension system, remove Ceiling demolition, suspended ceiling, mineral fiber, on suspension system, remove Ceiling demolition, suspended ceiling, mineral fiber, on suspension system, remove Ceiling demolition, suspended ceiling, mineral fiber, on suspension system, remove Ceiling demolition, drywall, on metal frame, 2 layers, 5/8" gypsum board, remove Note: 3 - Demo Partitions Walls and partitions demolition, drywall, two layers, nailed or screwed	1 1 1 1 1 1 1 1 1 1 1 1 1 1 1 1 1 1 1	LS LS LS LF. LF. LF. LS Ea.	\$232,272 \$207,272 \$207,272 \$27,635 \$5,938.57 \$10,698.48 \$10,997.46 \$179,637 \$22,884.66 \$12,192.33 \$5,938.03 \$6,032.06 \$10,375.08 \$6,032.06 \$10,375.08 \$50,986.74 \$2,064.11 \$1,668.22 \$37,513.05 \$25,000.00 \$12,00	21.3% 21.3%	23.8% 23.8%	\$348,692 \$311,161 \$41,486 \$8,915.12 \$16,606.82 \$16,509.66 \$34,355.03 \$18,303.44 \$39,003.08 \$9,055.47 \$15,575.33 \$3,098.70 \$3,098.70 \$3,098.70 \$3,098.70 \$3,098.70 \$15,251.84 \$3,002.45 \$2,251.84 \$3,002.45 \$2,251.84 \$92,956 \$92,956 \$92,955.86 \$92,956.86 \$92,966.86 \$92,966.86 \$92,966.86 \$92,966.86 \$92,966.86 \$92,966.86 \$92,966.86 \$92,966.86 \$92,966.86 \$92,966.86 \$92,966.86 \$92,966.86 \$9	\$467,387 \$417,081 \$55,607 \$11,950 \$21,528 \$22,130 \$46,050 \$24,534 \$52,280 \$12,138 \$20,877 \$122,720 \$4,153 \$3,236 \$75,485 \$5,306 \$19,116 \$4,024 \$3,018 \$24,147 \$257,716 \$124,598 \$124,59	\$7,674.92 \$4,088.99 \$1,742.66 \$6,068.98 \$1,605.94 \$3,718.79 \$1,038.37 \$404.52 \$686.23 \$9,558.15 \$120.73 \$1,20.73
394 395 396 397 398 399 400 401 402 403 404 405 407 410 411 412 413 414 415 416 417 421 421 422 423 424 424 425 426 427 428 429 429 429 429 429 421 421 422 423 424 424 425 426 427 427 428 428 429 429 429 429 429 429 429 429 429 429	EQUIPMENT AND FURNISHINGS FURNISHINGS CASEWORK Private Breakroom casework and countertop Shared Space casework and countertop Shared Space casework and countertop FURNITURE Corner Decks Cardenza Small Conference Tables Office Desk Tall Storage Cablente Breakroom Tables Breakroom Tables Breakroom Tables Breakroom Tables Breakroom Tables Breakroom Chair Task Chair EQUIPMENT Copy Machine Refrigerator Dish Washer Secured Storage - Allowance SPECIAL CONSTRUCTION AND DEMOLITION SPECIAL CONSTRUCTION AND DEMOLITION SIDEWALK CANOPY Sidewalk canopy allowance DEMOLITION ARCHITECTURAL Note: 1 - Remove Flooring Flooring demolition, tie, ceramic, thin set Note: 2 - Remove Ceilings Ceiling demolition, suspended ceiling, mineral fiber, on suspension system, remove Ceiling demolition, drywall, on metal frame, 2 layers, 5/8" gypsum board, remove Note: 3 - Demo Partitions Walls and partitions demolition, drywall, two layers, nailed or screwed Note: 4 - Demo Doors, Windows & Frames	1 1 1 1 1 1 1 1 1 1 1 1 1 1 1 1 1 1 1	LS LS LF. LF. LF. LF. LS Ea.	\$232,272 \$207,272 \$207,272 \$27,635 \$5,938.57 \$10,698.48 \$10,997.46 \$179,637 \$22,884.66 \$12,192.33 \$6,032.06 \$10,375.08 \$60,986.74 \$2,064.11 \$1,608.22 \$37,513.00 \$1,500.00 \$1,500.00 \$1,500.00 \$1,500.00 \$1,500.00 \$1,20	21.3% 21.3%	23.8% 23.8%	\$348,692 \$311,161 \$41,486 \$8,915.12 \$16,060.82 \$16,599.66 \$34,355.03 \$18,303.44 \$39,003.08 \$9,055.47 \$15,575.33 \$3,098.70 \$2,414.30 \$56,315.57 \$37,531 \$14,261.64 \$3,002.45 \$2,251.84 \$18,014.70 \$192,268 \$92,956 \$92,955.86 \$92,955.86 \$92,955.86 \$93,000 \$18,910.05 \$366.69 \$0.00 \$6,896.36 \$26,230.64 \$0.00 \$6,230.64 \$0.00 \$6,230.64 \$0.00	\$467,387 \$417,081 \$55,607 \$11,950 \$21,528 \$22,130 \$46,050 \$24,534 \$52,280 \$12,138 \$20,877 \$122,720 \$4,153 \$3,236 \$75,485 \$50,306 \$19,116 \$4,024 \$3,018 \$24,147 \$124,598 \$124,5	\$7,674.92 \$4,088.99 \$1,742.66 \$6,068.98 \$1,605.94 \$3,718.75 \$404.52 \$686.23 \$9,558.15 \$120.73 \$1,20.73
394 395 396 397 398 399 400 401 402 403 404 405 406 407 411 412 413 414 414 415 416 417 418 420 421 422 423 424 425 426 427 428 430	EQUIPMENT AND FURNISHINGS FURNISHINGS CASEWORK Private Breakroom casework and countertop Shared Space casework and countertop Shared Space casework and countertop FURNITURE Corner Decks Cardenza Small Conference Tables Large Conference Tables Large Conference Tables Half Storage Cablinet Breakroom Tables Breakroom Tables Breakroom Tables Breakroom Tables Breakroom Tables Breakroom Chair Task Chair EQUIPMENT Copy Machine Refrigerator Dish Washer Secured Storage - Allowance SPECIAL CONSTRUCTION AND DEMOLITION SPECIAL CONSTRUCTION AND DEMOLITION SPECIAL CONSTRUCTION SIDEWALK CANOPY Sidewalk canopy allowance DEMOLITION ARCHITECTURAL Note: 1 - Remove Flooring Flooring demolition, remove flooring Flooring demolition, suspended ceiling, mineral fiber, on suspension system, remove Ceiling demolition, suspended ceiling, mineral fiber, on suspension system, remove Ceiling demolition, suspended ceiling, mineral fiber, on suspension system, remove Ceiling demolition, suspended ceiling, mineral fiber, on suspension system, remove Ceiling demolition, suspended ceiling, mineral fiber, on suspension system, remove Ceiling demolition, drywall, on metal frame, 2 layers, 5/8" gypsum board, remove Note: 3 - Demo Partitions Walls and partitions demolition, drywall, two layers, nailed or screwed	1 1 1 1 1 1 1 1 1 1 1 1 1 1 1 1 1 1 1	LS LS LS LF. LF. LF. LS Ea.	\$232,272 \$207,272 \$207,272 \$27,635 \$5,938.57 \$10,698.48 \$10,997.46 \$179,637 \$22,884.66 \$12,192.33 \$5,938.03 \$6,032.06 \$10,375.08 \$6,032.06 \$10,375.08 \$50,986.74 \$2,064.11 \$1,668.22 \$37,513.05 \$25,000.00 \$12,00	21.3% 21.3%	23.8% 23.8%	\$348,692 \$311,161 \$41,486 \$8,915.12 \$16,606.82 \$16,509.66 \$34,355.03 \$18,303.44 \$39,003.08 \$9,055.47 \$15,575.33 \$3,098.70 \$3,098.70 \$3,098.70 \$3,098.70 \$3,098.70 \$15,251.84 \$3,002.45 \$2,251.84 \$3,002.45 \$2,251.84 \$92,956 \$92,956 \$92,955.86 \$92,956.86 \$92,966.86 \$92,966.86 \$92,966.86 \$92,966.86 \$92,966.86 \$92,966.86 \$92,966.86 \$92,966.86 \$92,966.86 \$92,966.86 \$92,966.86 \$92,966.86 \$9	\$467,387 \$417,081 \$55,607 \$11,950 \$21,528 \$22,130 \$46,050 \$24,534 \$52,280 \$12,138 \$20,877 \$122,720 \$4,153 \$3,236 \$75,485 \$5,306 \$19,116 \$4,024 \$3,018 \$24,147 \$257,716 \$124,598 \$124,59	\$7,674.92 \$4,088.99 \$1,742.66 \$6,068.98 \$1,605.94 \$3,718.79 \$1,038.37 \$404.52 \$686.23 \$9,558.15
394 395 396 397 398 399 400 401 402 403 404 405 406 407 410 411 412 413 414 415 416 417 422 421 422 423 424 425 426 427 428 429 430 431 432 433 434 435 436 437 437 438 438 438 438 438 438 438 438 438 438	EQUIPMENT AND FURNISHINGS FURNISHINGS CASEWORK Private Breakroom casework and countertop Shared Space casework and countertop Shared Space casework and countertop FURNITURE Corner Decks Cardenza Small Conference Tables Office Desk Tall Storage Cablinet Breakroom Tables Breakroom Tables Breakroom Tables Breakroom Tables Breakroom Chair Task Chair EQUIPMENT Copy Machine Refrigerator Dish Washer Secured Storage - Allowance SPECIAL CONSTRUCTION AND DEMOLITION SPECIAL CONSTRUCTION AND DEMOLITION SIDEWALK CANOPY Sidewalk canopy allowance DEMOLITION ARCHITECTURAL Note: 1 - Remove Flooring Flooring demolition, tie, ceramic, thin set Note: 2 - Remove Ceilings Ceiling demolition, drywall, on metal frame, 2 layers, 5/8" gypsum board, remove Note: 3 - Demo Partitions Walls and partitions down, single, 3' x 7' high, 1-3/8" thick, remove Door demolition, interior door, single, 3' x 7' high, 1-3/8" thick, remove Door demolition, interior door, single, 3' x 7' high, 1-3/8" thick, remove Door demolition, interior door, single, 3' x 7' high, 1-3/8" thick, remove Door demolition, interior door, single, 3' x 7' high, 1-3/8" thick, remove Door demolition, interior door, single, 3' x 7' high, 1-3/8" thick, remove	1 1 1 1 1 1 1 1 1 1 1 1 1 1 1 1 1 1 1	LS LS LF. LF. LF. LF. LS Ea.	\$232,272 \$207,272 \$207,272 \$27,635 \$5,938.57 \$10,698.48 \$10,997.46 \$179,637 \$22,884.66 \$12,192.33 \$6,032.06 \$10,375.08 \$60,986.74 \$2,064.11 \$1,608.22 \$37,513.00 \$1,500.00 \$1,500.00 \$1,500.00 \$1,500.00 \$1,500.00 \$1,20	21.3% 21.3%	23.8% 23.8%	\$348,692 \$311,161 \$41,486 \$8,915.12 \$16,060.82 \$16,599.66 \$34,355.03 \$18,303.44 \$39,003.08 \$9,055.47 \$15,575.33 \$3,098.70 \$2,414.30 \$56,315.57 \$37,531 \$14,261.64 \$3,002.45 \$2,251.84 \$18,014.70 \$192,268 \$92,956 \$92,955.86 \$92,955.86 \$92,955.86 \$93,000 \$18,910.05 \$366.69 \$266.54 \$266.54 \$266.54 \$266.54 \$266.54 \$260.00	\$467,387 \$417,081 \$55,607 \$11,950 \$21,528 \$22,130 \$361,473 \$46,050 \$24,534 \$52,4534 \$52,280 \$12,138 \$20,877 \$122,720 \$4,153 \$3,236 \$19,116 \$4,024 \$3,018 \$24,147 \$257,716 \$124,598 \$124,598 \$124,598 \$124,598 \$124,598 \$124,598 \$124,598 \$124,598 \$124,598 \$124,598 \$124,598 \$124,598 \$124,598 \$124,598 \$124,598 \$133,118 \$78,332 \$0 \$25,347 \$492 \$0 \$0 \$9,244 \$3557 \$0 \$8,352 \$0 \$8,352 \$20 \$323 \$340 \$881	\$7,674.92 \$4,088.99 \$1,742.66 \$6,068.98 \$1,605.94 \$3,718.75 \$404.52 \$686.23 \$9,558.15 \$120.73 \$1.03 \$1.03 \$1.03 \$1.03 \$1.03 \$1.03 \$1.04 \$1.05 \$1
394 395 396 397 398 399 400 401 402 403 404 405 406 407 410 411 411 412 413 414 415 416 417 418 420 421 422 423 424 425 426 427 428 429 431 431 431 431 431 431 431 431 431 431	EQUIPMENT AND FURNISHINGS FURNISHINGS CASEWORK Private Breakroom casework and countertop Shared Space casework and countertop Shared Space island casework and countertop FURNITURE Corner Decks Cardenza Small Conference Tables Large Conference Tables Large Conference Tables Harge Conference Tables Special Conference Tables Freakroom Tables Breakroom Tables Breakroom Tables Breakroom Tables Breakroom Chair Task Chair EQUIPMENT Copy Machine Refrigerator Dish Washer Secured Storage - Allowance SPECIAL CONSTRUCTION AND DEMOLITION SPECIAL CONSTRUCTION AND DEMOLITION SPECIAL CONSTRUCTION SIDEWALK CANOPY Sidewalk canopy allowance DEMOLITION ARCHITECTURAL Note: 1 - Remove Flooring Flooring demolition, remove flooring Flooring demolition, tile, ceramic, thin set Note: 2 - Remove Cellings Celling demolition, suspended celling, mineral fiber, on suspension system, remove Celling demolition, suspended celling, mineral fiber, on suspension system, remove Celling demolition, suspended celling, mineral fiber, on suspension system, remove Celling demolition, suspended celling, mineral fiber, on suspension system, remove Celling demolition, suspended celling, mineral fiber, on suspension system, remove Celling demolition, suspended celling, mineral fiber, on suspension system, remove Note: 3 - Demo Partitions Walls and partitions demolition, drywall, two layers, nailed or screwed Note: 4 - Demo Doors, Windows & Frames Door demolition, interior door, single, 3' x 7' high, 1-3/8" thick, remove	1 1 1 1 1 1 1 1 1 1 1 1 1 1 1 1 1 1 1	LS LS LF. LF. LF. LS Ea.	\$232,272 \$207,272 \$207,272 \$27,635 \$5,938.57 \$10,698.48 \$10,997.46 \$179,637 \$22,884.66 \$12,192.33 \$5,032.06 \$10,375.08 \$60,986.74 \$2,064.11 \$2,064.11 \$2,064.11 \$2,064.11 \$2,000.00 \$1,500.00 \$1,500.00 \$1,500.00 \$12,000.00 \$12,000.00 \$12,000.00 \$12,000.00 \$12,000.00 \$12,000.00 \$12,000.00 \$12,000.00 \$12,000.00 \$12,000.00 \$12,000.00 \$12,000.00 \$12,000.00 \$12,500.00 \$12,500.00 \$12,500.00 \$12,500.00 \$12,500.00 \$12,500.00 \$12,500.00 \$16,000	21.3% 21.3%	23.8% 23.8%	\$348,692 \$311,161 \$41,486 \$8,915.12 \$16,606.82 \$16,509.66 \$34,355.03 \$18,303.44 \$39,003.08 \$9,055.47 \$15,575.33 \$3,098.70 \$2,414.30 \$3,002.45 \$2,251.84 \$18,014.70 \$192,268 \$92,956 \$92,956 \$92,955.65 \$92,955.65 \$92,955.65 \$92,955.65 \$93,955.65	\$467,387 \$417,081 \$55,607 \$11,950 \$21,528 \$22,1528 \$22,1538 \$46,050 \$24,534 \$52,280 \$12,138 \$20,877 \$122,720 \$4,153 \$75,485 \$50,306 \$19,116 \$4,024 \$3,018 \$24,174 \$257,716 \$124,598 \$12	\$672.75 \$7,674.92 \$4,088.99 \$1,742.66 \$6,068.98 \$1,605.94 \$3,718.79 \$1,038.37 \$404.52 \$686.23 \$9,558.15 \$120.73 \$120.73 \$1,038.37 \$1,038.37 \$1,038.37 \$1,038.37 \$1,038.37 \$1,038.37 \$1,038.37 \$1,038.37 \$1,048.52 \$1,048.52 \$1,048.52 \$1,048.52 \$1,048.52 \$1,048.52 \$1,048.52 \$1,058.53 \$1,058







Delivery Method: CMAR Estimate Type: AACEi Class 4 WBS: Component/Uniformat

						Prime	Total	ECC	ECC Unit
Line #	Description	Qty.	UoM	Subtotal	Sub %	%	Direct Cost	w/Escalation	Cost
436	Note: 6 - Demo Book Drop	0.00		\$0.00	0.0%	0.0%	\$0.00	\$0	
437	Demo Book Drop	1.00	Ea.	\$40.07	21.3%	23.8%	\$60.15	\$81	
438	Note: 7 - Demo Signage and Repair Wall	0.00		\$0.00	0.0%	0.0%	\$0.00	\$0	
439	Demo exterior signage and repair wall	1.00	Ea.	\$125.17	21.3%	23.8%	\$187.91	\$252	
	Note: 8 - Demo Canopy	0.00		\$0.00	0.0%	0.0%	\$0.00	\$0	
441	Entrance canopy, selective demolition, including frame	211.00	S.F.	\$7,926.23	21.3%	23.8%	\$11,899.05	\$15,950	\$75.59
442	Note: 10 - Demo Finishes of Interior Gyp Walls	0.00		\$0.00	0.0%	0.0%	\$0.00	\$0	
443	Demo finishes of interior gyp	5,347.00	S.F.	\$2,571.00	21.3%	23.8%	\$3,859.65	\$5,173	\$0.97
444	Walls and partitions demolition, tile, ceramic, on walls, thin set	1,226.00	S.F.	\$1,326.37	21.3%	23.8%	\$1,991.18	\$2,669	\$2.18
445	Note: 11 - Demo Exterior Wall	0.00		\$0.00	0.0%	0.0%	\$0.00	\$0	
446	Selective demolition, masonry, concrete block walls, reinforced alternate courses, 12" thick	25.00	S.F.	\$18.03	21.3%	23.8%	\$27.07	\$36	\$1.45
447	Selective demolition, masonry, veneers, stone, 4" thick	25.00	S.F.	\$44.08	21.3%	23.8%	\$66.17	\$89	\$3.55
448	Note: Restroom Accessories	0.00		\$0.00	0.0%	0.0%	\$0.00	\$0	
449	Specialties demolition, demolition, mirror, wall mounted	2.00	Ea.	\$21.40	21.3%	23.8%	\$32.12	\$43	\$21.53
450	Specialties demolition, toilet cubicles, remove	3.00	Ea.	\$240.42	21.3%	23.8%	\$360.92	\$484	\$161.26
451	Urinal screen, remove	1.00	Ea.	\$26.73	21.3%	23.8%	\$40.12	\$54	
452	Restroom accessories, remove	12.00	Ea.	\$120.21	21.3%	23.8%	\$180.46	\$242	\$20.16
453	Note: Ceiling Demolition in City Hall	0.00		\$0.00	0.0%	0.0%	\$0.00	\$0	
454	Allowance - ceiling demolition, suspended ceiling, mineral fiber, on suspension system, remove	8,327.00	GSF	\$3,470.03	21.3%	23.8%	\$5,209.30	\$6,983	\$0.84
455	HVAC OPTION #1	10,073	GSF	\$27,226	21.3%	23.8%	\$40,872	\$54,785	\$5.44
456	PLUMBING	10,073	GSF	\$2,462	21.3%	23.8%	\$3,696	\$4,954	\$0.49
457	Fixture, plumbing, selective demolition	6.00	Ea.	\$389.44	21.3%	23.8%	\$584.64	\$784	\$130.61
458	Pipe, metal pipe, 4" diam., selective demolition	500.00	L.F.	\$1,504.85	21.3%	23.8%	\$2,259.12	\$3,028	\$6.06
459	Pipe hanger / support, selective demolition	100.00	Ea.	\$567.87	21.3%	23.8%	\$852.50	\$1,143	\$11.43
460	HVAC	10,073	GSF	\$24,764	21.3%	23.8%	\$37,176	\$49,831	\$4.95
461	Ductwork, metal; steel and stainless steel, fabricated, selective demolition	25,182.50	Lb.	\$21,952.85	21.3%	23.8%	\$32,956.17	\$44,174	\$1.75
462	Air conditioner, split unit air conditioner, 5 ton, selective demolition	6.00	Ea.	\$2,453.19	21.3%	23.8%	\$3,682.80	\$4,936	\$822.74
463	Air conditioner, split unit air conditioner, 4 ton, selective demolition	1.00	Ea.	\$357.76	21.3%	23.8%	\$537.07	\$720	







Delivery Method: CMAR Estimate Type: AACEi Class 4 WBS: Component/Uniformat

	Saginaw Keeter Bldg Reno Concept								
						Prime	Total	ECC	ECC Unit
Line #	Description	Qty.	UoM	Subtotal	Sub %	%	Direct Cost	w/Escalation	Cost
464	ALTERNATES	1	LS	-\$21,142	21.3%	23.8%	-\$31,738		
465	HVAC OPTION #2	1	LS	-\$21,142	21.3%	23.8%	-\$31,738	-\$40,516	
466	PLUMBING	1	LS	\$3,293	21.3%	23.8%	\$4,943	\$6,311	
467	OPTION #1 DEDUCT	1 00	LS	-\$207,780	21.3% 21.3%	23.8%	-\$311,924	-\$398,194	
468 469	Option #1 deduct DOMESTIC WATER PIPING	1.00 10,071	S.F.	-\$207,779.78 \$99,422	21.3%	23.8% 23.8%	-\$311,924.24 \$149,254	-\$398,194 \$190,534	\$18.92
	Domestic distribution piping, type L copper, solder joints	10,071.00	S.F.	\$85,603.50	21.3%	23.8%	\$128,510.13	\$164,052	\$16.29
471	Domestic water piping insulation, fiberglass with all service jacket. 1" thick	10,071.00	S.F.	\$12,588.75	21.3%	23.8%	\$18,898.55	\$24,125	\$2.40
472	Pump, domestic recirculating	1.00	Ea.	\$1,229.49	21.3%	23.8%	\$1,845.74	\$2,356	
473	COMMERCIAL PLUMBING FIXTURES	1	LS	\$50,846 \$20,942,95	21.3%	23.8%	\$76,332	\$97,443	ÅF.046.04
	Water closet, wall mount, IR sensor flush valve, carrier Urinal, wall mount, IR sensor flush valve, carrier	8.00 2.00	Ea. Ea.	\$20,942.95	21.3% 21.3%	23.8%	\$31,440.08 \$6,833.28	\$40,136 \$8,723	\$5,016.94 \$4,361.59
	Lavatory, wall mount, IR sensor faucet, carrier	8.00	Ea.	\$13,407.21	21.3%	23.8%	\$20,127.25	\$25,694	\$3,211.73
	Breakroom sink, ss double comp, manual faucet	1.00	Ea.	\$1,775.90	21.3%	23.8%	\$2,666.03	\$3,403	
	Mop sink, floor mount, manual faucet	1.00	Ea.	\$2,567.87	21.3%	23.8%	\$3,854.95	\$4,921	
	Floor drain, mech room Floor drain, bathroom	1.00 4.00	Ea. Ea.	\$727.46 \$2,509.84	21.3% 21.3%	23.8%	\$1,092.08 \$3,767.83	\$1,394 \$4,810	\$1,202.48
	Water cooler, electric, bi-level, with bottle filler	1.00	Ea.	\$3,885.74	21.3%	23.8%	\$5,833.37	\$4,810	\$1,202.40
	Coffee maker connection with backflow preventer	1.00	Ea.	\$477.46	21.3%	23.8%	\$716.77	\$915	
483	SANITARY WASTE & VENT PIPING	1	LS	\$28,482	21.3%	23.8%	\$42,758	\$54,583	
	Note: Sawcutting, removal and pour back	350.00	S.F.	\$0.00	0.0%	0.0%	\$0.00	\$0	\$0.00
	Concrete sawing, concrete slabs, rod reinforced, up to 3" deep, includes blade cost, layout and set up time	255.00	L.F.	\$700.37	21.3%	23.8%	\$1,051.41	\$1,342	\$5.26
486	Concrete sawing, concrete, existing slab, rod reinforced, for each additional inch of depth over 3", includes blade cost, layout and set up time	765.00	L.F.	\$736.12	21.3%	23.8%	\$1,105.08	\$1,411	\$1.84
487	Selective concrete demolition, reinforcing more than 2% cross-sectional area, break up into small pieces, excludes	6.48	C.Y.	\$1,672.81	21.3%	23.8%	\$2,511.26	\$3,206	\$494.72
	shoring, bracing, saw or torch cutting, loading, hauling, dumping								
	1-1/2 C.Y. bucket, loading and/or spreading, shovel	6.48	B.C.Y.	\$16.18	21.3%	23.8%	\$24.30	\$31	\$4.79
489	Cycle hauling (wait, load, travel, unload or dump & return) time per cycle, excavated or borrow, loose cubic yards, 25	6.48	L.C.Y.	\$82.08	21.3%	23.8%	\$123.22	\$157	\$24.28
490	min wait/load/unload, 8 C.Y. truck, cycle 4 miles, 15 MPH, excludes loading equipment Structural concrete, in place, slab on grade (3500 psi), 6" thick, includes forms(4 uses), Grade 60 rebar, concrete	6.48	C.Y.	\$1,687.97	21.3%	23.8%	\$2,534.03	\$3,235	\$499.21
	(Portland cement Type I), and placing	0.40	J. 1.	\$2,007.37	21.576	25.676	Ş2,33 4 .03	73,233	Ç - 777.21
491	Note: Excavation & backfill	0.00		\$0.00	0.0%	0.0%	\$0.00	\$0	
	Excavating, trench or continuous footing, common earth, 3/4 C.Y. excavator, to 14' deep	51.11	B.C.Y.	\$1,038.50	21.3%	23.8%	\$1,559.02	\$1,990	\$38.94
	Backfill, haul from existing stockpile, excludes compaction	66.44	L.C.Y.	\$790.39	21.3%	23.8%	\$1,186.55	\$1,515	\$22.80
	Compaction, vibrating plate Fill, gravel embed in pipe trench, compacted, to 9" deep	66.44 345.00	E.C.Y. S.F.	\$165.06 \$601.68	21.3% 21.3%	23.8% 23.8%	\$247.79 \$903.26	\$316 \$1,153	\$4.76 \$3.34
496	Note: New sanitary waste & vent piping	0.00	5.1 .	\$0.00	0.0%	0.0%	\$0.00	\$0	Ş3.5 4
497	Sanitary waste piping, below grade, Sch 40 PVC	400.00	L.F.	\$6,000.00	21.3%	23.8%	\$9,007.35	\$11,499	\$28.75
498	Sanitary vent piping, above grade, no hub cast iron	320.00	L.F.	\$11,200.00	21.3%	23.8%	\$16,813.72	\$21,464	\$67.07
	Drain, floor, medium duty, cast iron, deep flange, with polished bronze top, 7" diameter top	4.00	Ea.	\$2,102.73	21.3%	23.8%	\$3,156.67	\$4,030	\$1,007.43
	Note: Concrete pour back Structural concrete, in place, slab on grade (3500 psi), 6" thick, includes forms(4 uses), Grade 60 rebar, concrete	0.00 6.48	C.Y.	\$0.00 \$1,687.97	0.0% 21.3%	0.0% 23.8%	\$0.00 \$2,534.03	\$0 \$3,235	\$499.21
501	(Portland cement Type I), and placing	0.40	C.11.	\$1,007.57	21.570	25.070	\$2,554.05	\$3,233	Ç433.21
502	NATURAL GAS PIPING	1	LS	\$18,693	21.3%	23.8%	\$28,063	\$35,824	
	Note: Natural gas piping	0.00		\$0.00	0.0%	0.0%	\$0.00	\$0	
504	Pipe, steel, black, threaded, 1" diameter, schedule 40, A-106, grade A/B seamless, includes coupling and clevis hanger	400.00	L.F.	\$12,366.53	21.3%	23.8%	\$18,564.94	\$23,699	\$59.25
505	assembly sized for covering, 10' OC Elbow, 90 Deg., steel, malleable iron, black, straight, threaded, 150 lb., 1"	75.00	Ea.	\$4,658.30	21.3%	23.8%	\$6,993.16	\$8,927	\$119.03
	Tee, steel, malleable iron, black, straight, threaded, 150 lb., 1	12.00	Ea.	\$1,200.34	21.3%	23.8%	\$1,801.98	\$2,300	\$113.03
	Pressure regulator, gas appliance, main burner and pilot applications, rubber seat poppet type, threaded, 3/4" pipe	7.00	Ea.	\$467.92	21.3%	23.8%	\$702.46	\$897	\$128.11
	size								
508	COMMERCIAL GAS DOMESTIC WATER HEATER	1	LS	\$13,630	21.3%	23.8%	\$20,461	\$26,121	
	Note: New domestic water heater -100 Gallon	0.00 1.00	F-	\$0.00 \$7,080.03	0.0% 21.3%	0.0% 23.8%	\$0.00 \$10.628.72	\$0 \$13,568	
	Water heater, gas fired, 120 MBH input, includes standard controls, excludes vent Domestic water piping connection, specialties & accessories	1.00	Ea. Ea.	\$4,799.87	21.3%	23.8%	\$10,628.72	\$13,568	
	Water heater flue/vent	1.00	Ea.	\$633.31	21.3%	23.8%	\$950.74	\$1,214	
	Natural gas piping connection	1.00	Ea.	\$1,116.62	21.3%	23.8%	\$1,676.30	\$2,140	
514	HVAC	10,073	GSF	-\$24,435	21.3%	23.8%	-\$36,682	-\$46,827	-\$4.65
515	OPTION #1 DEDUCT	1	LS	-\$334,478	21.3%	23.8%	-\$502,127	-\$641,001	
	Option #1 deduct	-1.00	LS	-\$334,478.14		23.8%	-\$502,127.00		
517	DEMOLITION PLUMBING	10,073	GSF	\$18,445	21.3%	23.8%	\$27,690	\$35,348	\$3.51
518	PLUMBING Fixture, plumbing, selective demolition	10,073 6.00	GSF Ea.	\$2,462 \$389.44	21.3% 21.3%	23.8%	\$3,696 \$584.64	\$4,719 \$746	\$0.47 \$124.39
	Pipe, metal pipe, 4" diam., selective demolition	500.00	L.F.	\$1,504.85	21.3%	23.8%	\$2,259.12	\$2,884	\$124.39
	Pipe hanger / support, selective demolition	100.00	Ea.	\$567.87	21.3%	23.8%	\$852.50	\$1,088	\$10.88
522	HVAC	10,073	GSF	\$15,983	21.3%	23.8%	\$23,994	\$30,630	\$3.04
	Misc. sheetmetal & GRD selective demolition	15,109.50	Lb.	\$13,171.71	21.3%	23.8%	\$19,773.70	\$25,243	\$1.67
	Air conditioner, split unit air conditioner, 5 ton, selective demolition	6.00	Ea.	\$2,453.19	21.3%	23.8%	\$3,682.80	\$4,701	\$783.56
525 526	Air conditioner, split unit air conditioner, 4 ton, selective demolition HVAC DUCTWORK	1.00 10,073	Ea. GSF	\$357.76 \$39,883	21.3% 21.3%	23.8% 23.8%	\$537.07 \$59,873	\$686 \$76,432	\$7.59
	Note: Minor duct modifications for (6) existing ducted split systems	0.00	uar	\$0.00	0.0%	0.0%	\$0.00	\$76,432	۶۲،59
	Supply ductwork, low pressure, galv.	5,036.50	Lb.	\$20,146.00	21.3%	23.8%	\$30,243.68	\$38,608	\$7.67
529	Duct Insulation	2,518.25	S.F.	\$10,073.00	21.3%	23.8%	\$15,121.84	\$19,304	\$7.67
	Note: Bathroom exhaust ductwork	0.00		\$0.00	0.0%	0.0%	\$0.00	\$0	4
	Exhaust ductwork, galv.	800.00	Lb.	\$6,400.00	21.3%	23.8%	\$9,607.84	\$12,265	\$15.33
	Note: Connector corridor split system ductwork Split system air conditioner, subassembly for assembly systems, duct work per ton single unit	0.00 2.00	Ton	\$0.00 \$3,263.59	0.0% 21.3%	0.0% 23.8%	\$0.00 \$4,899.39	\$0 \$6,254	\$3,127.21
	AIR INLETS AND OUTLETS	10,073	GSF	\$13,666	21.3%	23.8%	\$20,516		\$2.60
534			Ea.	\$11,250.00	21.3%	23.8%	\$16,888.78	\$21,560	\$143.73
	Diffusers, grilles, transfers - misc. relocation, cleaning, & reinstall	150.00	La.						
535	Repair/replace existing ductwork flexible coated fiberglass fabric on corrosion resistant metal helix, insulated, P.E.	250.00	L.F.	\$2,416.41	21.3%	23.8%	\$3,627.58	\$4,631	\$18.52
535					21.3% 21.3%	23.8% 23.8%	\$3,627.58 \$3,897	\$4,631 \$4,975	\$18.52 \$0.49







Delivery Method: CMAR Estimate Type: AACEi Class 4 WBS: Component/Uniformat

	Saginaw Keeter Bldg Reno Concept								
						Prime	Total	ECC	ECC Unit
Line #	Description	Qty.	UoM	Subtotal	Sub %	%	Direct Cost	w/Escalation	Cost
539	DECENTRALIZED UNITARY HVAC EQUIPMENT	10.073	GSF	\$120,978		23.8%	\$181,615	\$231,844	\$23.02
	Note: Existing split system replacement - 5 ton	0.00	GSF	\$120,978	0.0%	0.0%	\$181,613	\$231,844	\$23.02
	Carrier infinity, 5 ton cooling, gas furnace, outdoor condensing unit & indoor ducted fan coil, excludes interconnecting	6.00	Ea.	\$89,461.28	21.3%	23.8%	\$134,301.52	\$171,446	\$28,574.26
341	tubing, curbs, pads and ductwork	0.00	Lu.	Ç05,401.20	21.570	23.070	Ç134,301.32	Ş171, 44 0	\$20,574.20
542	Split system, accessories for all split ductless systems, for tube / wiring kit, 50' kit	6.00	Ea.	\$2,926.80	21.3%	23.8%	\$4,393.79	\$5,609	\$934.83
	Curbs/pads prefabricated, pad, condenser, fiberglass reinforced concrete with polystyrene foam core, 2" thick, 36" x	6.00	Ea.	\$1,732.40	21.3%	23.8%	\$2,600.72	\$3,320	\$553.33
	36"								•
544	Note: Existing split system replacement - 4 ton	0.00		\$0.00	0.0%	0.0%	\$0.00	\$0	
545	Carrier infinity, 4 ton cooling, gas furnace, outdoor condensing unit & indoor ducted fan coil, excluded interconnecting	1.00	Ea.	\$14,748.97	21.3%	23.8%	\$22,141.52	\$28,265	
	tubing, curbs, pad and ductwork								
546	Split system, accessories for all split ductless systems, for tube / wiring kit, 50' kit	1.00	Ea.	\$487.80	21.3%	23.8%	\$732.30	\$935	
547	Curbs/pads prefabricated, pad, condenser, fiberglass reinforced concrete with polystyrene foam core, 2" thick, 36" x	1.00	Ea.	\$288.73	21.3%	23.8%	\$433.45	\$553	
5/10	Note: Electrical & MDF room cooling only split systems - 1 ton	0.00		\$0.00	0.0%	0.0%	\$0.00	ŚO	
	Split ductless system, cooling only, single zone, wall mount, 1 ton cooling	2.00	Ea.	\$3,975.55	21.3%	23.8%	\$5,968.20	\$7,619	\$3,809.42
	Split ductless system, accessories for all split ductless systems, for tube / wiring kit, 50' kit	2.00	Ea.	\$975.60	21.3%	23.8%	\$1,464.60	\$1,870	\$934.83
	Curbs/pads prefabricated, pad, condenser, fiberglass reinforced concrete with polystyrene foam core, 2" thick, 24" x	1.00	Ea.	\$159.66	21.3%	23.8%	\$239.69	\$306	700
	36"			, , , , , , , , , , , , , , , , , , , ,			7	,,,,,	
552	Note: Connector addition heat pump ducted split systems - 2 ton	0.00		\$0.00	0.0%	0.0%	\$0.00	\$0	
553	Heat pump, air to air single package, 2 ton cooling, 6.5 MBH heat @ ODeg.F, excludes interconnecting tubing, curbs,	1.00	Ea.	\$5,444.32	21.3%	23.8%	\$8,173.15	\$10,434	
	pads and ductwork								
	Split system, accessories for all split ductless systems, for tube / wiring kit, 50' kit	1.00	Ea.	\$487.80	21.3%	23.8%	\$732.30	\$935	
555	Curbs/pads prefabricated, pad, condenser, fiberglass reinforced concrete with polystyrene foam core, 2" thick, 36" x	1.00	Ea.	\$288.73	21.3%	23.8%	\$433.45	\$553	
	36"								
556	REFRIGERANT PIPING	10,073	GSF	\$42,252	21.3%	23.8%	\$63,430	\$80,973	\$8.04
	NOTE: Refrigerant piping to split systems (3 Ea.)	0.00		\$0.00	0.0%	0.0%	\$0.00	\$0	
	Refrigerant line sets, insulated copper supply and return tubes, 3/8" and 3/4" tubes, 1/2" insulation, 50' long	3.00	Ea.	\$2,015.02	21.3%	23.8%	\$3,025.01	\$3,862	\$1,287.21
	Pipe hanger / support, hangers, trapeze channel support, steel, 12" wide, steel Refrigerant specialties, site glass, filter dryer	25.00 3.00	Ea.	\$3,308.62 \$1,308.62	21.3% 21.3%	23.8%	\$4,966.99 \$1,964.53	\$6,341 \$2,508	\$253.63 \$835.95
	Refrigeration specialties, refrigerant, R-410A, 25 lb. cylinder	15.00	Lb.	\$2,337.29	21.3%	23.8%	\$3,508.80	\$4,479	\$298.62
	Note: Refrigerant piping to ducted split systems 4 & 5 ton units	0.00	LU.	\$0.00	0.0%	0.0%	\$0.00	\$0	3236.02
	Pipe, copper, hard temper, cleaned and capped, 3/8", type L, ACR tubing, excludes couplings and hangers	300.00	L.F.	\$1,474.89		23.8%	\$2,214.14	\$2,827	\$9.42
	Pipe, copper, hard temper, cleaned and capped, 5/8", type L, ACR tubing, excludes couplings and hangers	300.00	L.F.	\$1,742.24	21.3%	23.8%	\$2,615.49	\$3,339	\$11.13
	Elbow, 90 Deg., copper, solder, 3/8", ACR, OD SIZE	75.00	Ea.	\$3,922.10	21.3%	23.8%	\$5,887.95	\$7,516	\$100.22
566	Elbow, 90 Deg., copper, solder, 5/8", ACR, OD SIZE	75.00	Ea.	\$3,922.10	21.3%	23.8%	\$5,887.95	\$7,516	\$100.22
567	Refrigerant specialties, site glass, filter dryer	6.00	Ea.	\$2,617.24	21.3%	23.8%	\$3,929.06	\$5,016	\$835.95
	Pipe hanger / support, hangers, trapeze channel support, steel, 12" wide, steel	50.00	Ea.	\$6,617.25	21.3%	23.8%	\$9,933.98	\$12,681	\$253.63
	Insulation, pipe covering, rubber tubing flexible closed cell foam, 1" wall, 3/8" copper tube size	300.00	L.F.	\$3,418.75	21.3%	23.8%	\$5,132.31	\$6,552	\$21.84
	Insulation, pipe covering, rubber tubing flexible closed cell foam, 1" wall, 5/8" copper tube size	300.00	L.F.	\$3,729.51	21.3%	23.8%	\$5,598.83	\$7,147	\$23.82
	Refrigeration specialties, refrigerant, R-410A, 25 lb. disposable cylinder	34.00	Lb.	\$5,838.47	21.3%	23.8%	\$8,764.86	\$11,189	\$329.09
572	CONDENSATE DRAIN PIPING	10,073	GSF	\$12,011	21.3%	23.8%	\$18,032	\$23,019	\$2.29
	NOTE: Condensate drain piping to split system (3 Ea.) Pipe, copper, tubing, solder, 3/4" diameter, type L, includes coupling & clevis hanger assembly 10' OC	0.00 360.00	L.F.	\$0.00 \$4,951.69	0.0% 21.3%	0.0% 23.8%	\$0.00 \$7,433.60	\$0 \$9,490	\$26.36
	Pipe, copper, tubing, soider, 3/4" diameter, type L, includes coupling & clevis hanger assembly 10" OC Elbow, 90 Deg., copper, wrought, copper x copper, 3/4"	120.00	Ea.	\$4,951.69	21.3%	23.8%	\$7,433.60	\$9,490 \$8,964	\$26.36
	Insulation, pipe covering (price copper tube one size less than I.P.S.), fiberglass with all service jacket, 1/2" wall, 1/2"	360.00	L.F.	\$2,382.22	21.3%	23.8%	\$3,576.25	\$4,565	\$12.68
370	iron pipe size	300.00	L.I.	\$2,382.22	21.370	23.070	\$3,370.23	54,505	312.08
577	MISC HVAC	10,073	GSF	\$30,213	21.3%	23.8%	\$45,357	\$57,901	\$5.75
	Test and balancing, air	10,071.00	S.F.	\$30,213.00	21.3%	23.8%	\$45,356.52	\$57,901	\$5.75
	NOTE: Startup - Included	0.00	5	\$0.00	0.0%	0.0%	\$0.00	\$0	\$5.75
	NOTE: Commissioning assistance - Included	0.00		\$0.00	0.0%	0.0%	\$0.00	\$0	
	NOTE: Pipe, duct & equipment identification - Included	0.00		\$0.00	0.0%	0.0%	\$0.00	\$0	
	NOTE: Sleeves, penetrations & firestopping - Included	0.00		\$0.00	0.0%	0.0%	\$0.00	\$0	•
583	INSTRUMENTATION AND CONTROL FOR HVAC	10,073	GSF	\$30,000	21.3%	23.8%	\$45,037	\$57,493	\$5.71
	Note: Stand alone controls	0.00		\$0.00	0.0%	0.0%	\$0.00	\$0	
	Split systems - Existing unit replacement	7.00	Ea.	\$21,000.00		23.8%	\$31,525.73	\$40,245	\$5,749.27
	Split systems - MDF & electrical rooms	2.00	Ea.	\$4,000.00	21.3%	23.8%	\$6,004.90	\$7,666	\$3,832.84
	Split systems - Corridor addition	1.00	Ea.	\$3,000.00	21.3%	23.8%	\$4,503.68	\$5,749	
	Exhaust fan	1.00	Ea.	\$1,000.00	21.3%	23.8%	\$1,501.23	\$1,916	
589	Electric unit heater	1.00	Ea.	\$1,000.00	21.3%	23.8%	\$1,501.23	\$1,916	



CITY HALL ANNEX EXTERIOR ENHANCEMENT OPTIONS

AND

INTERIOR PERSPECTIVES












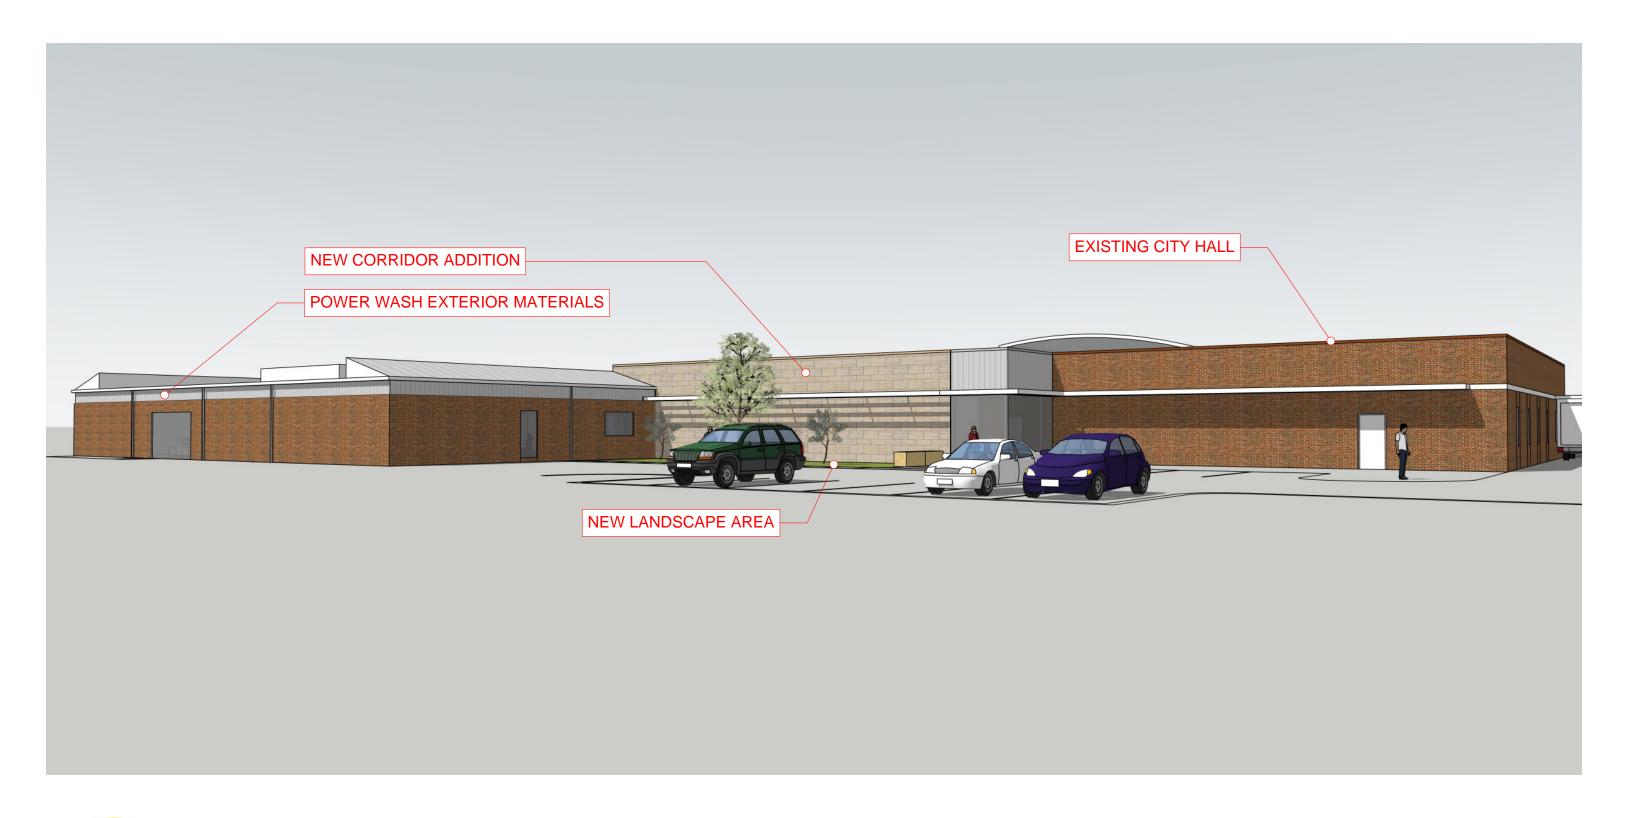



























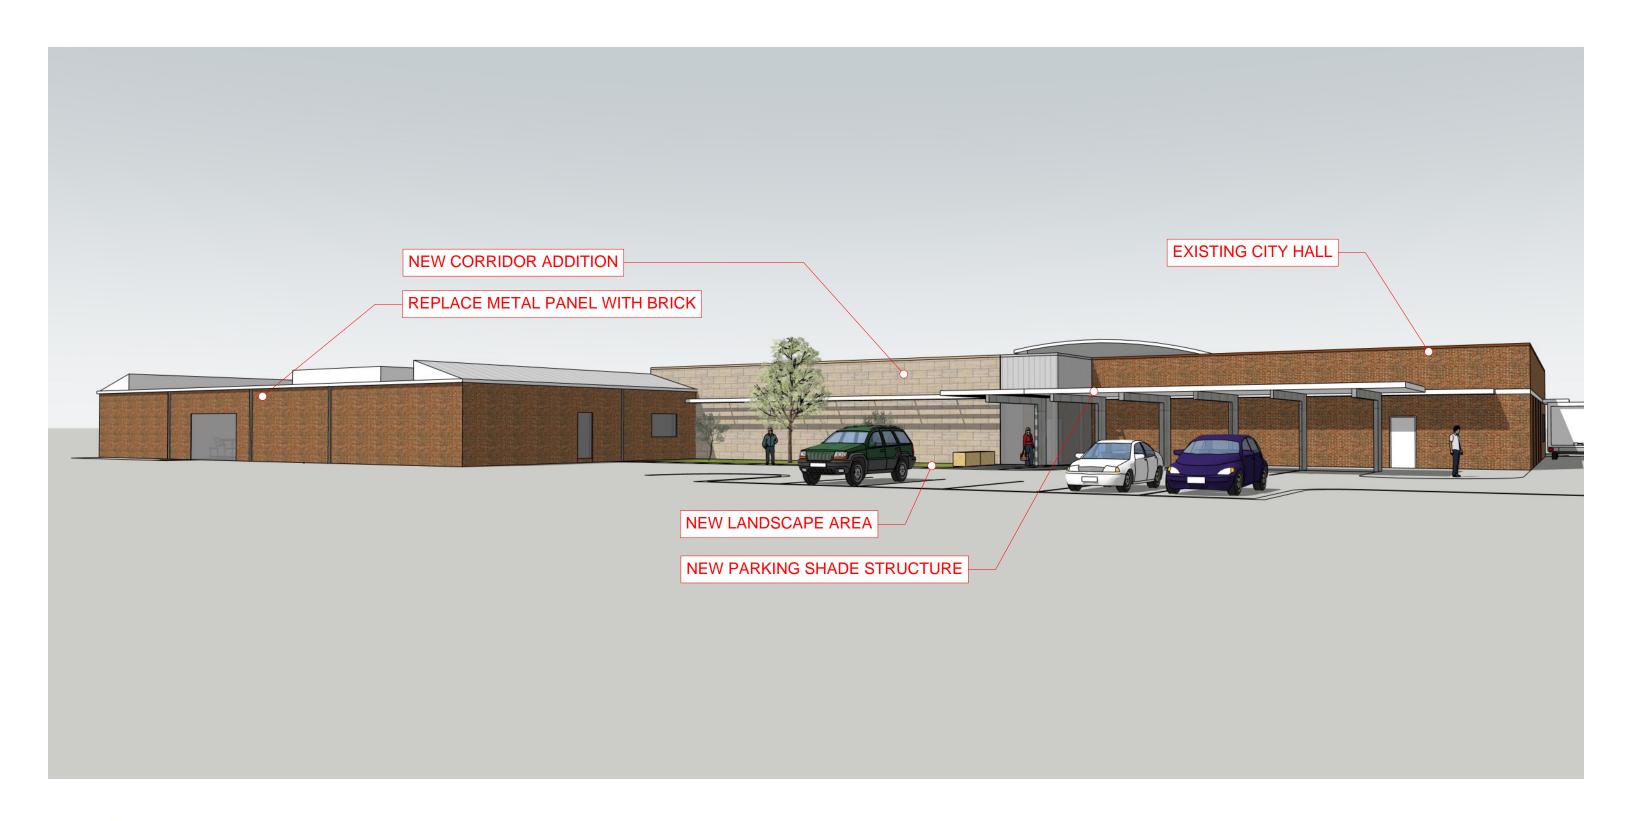



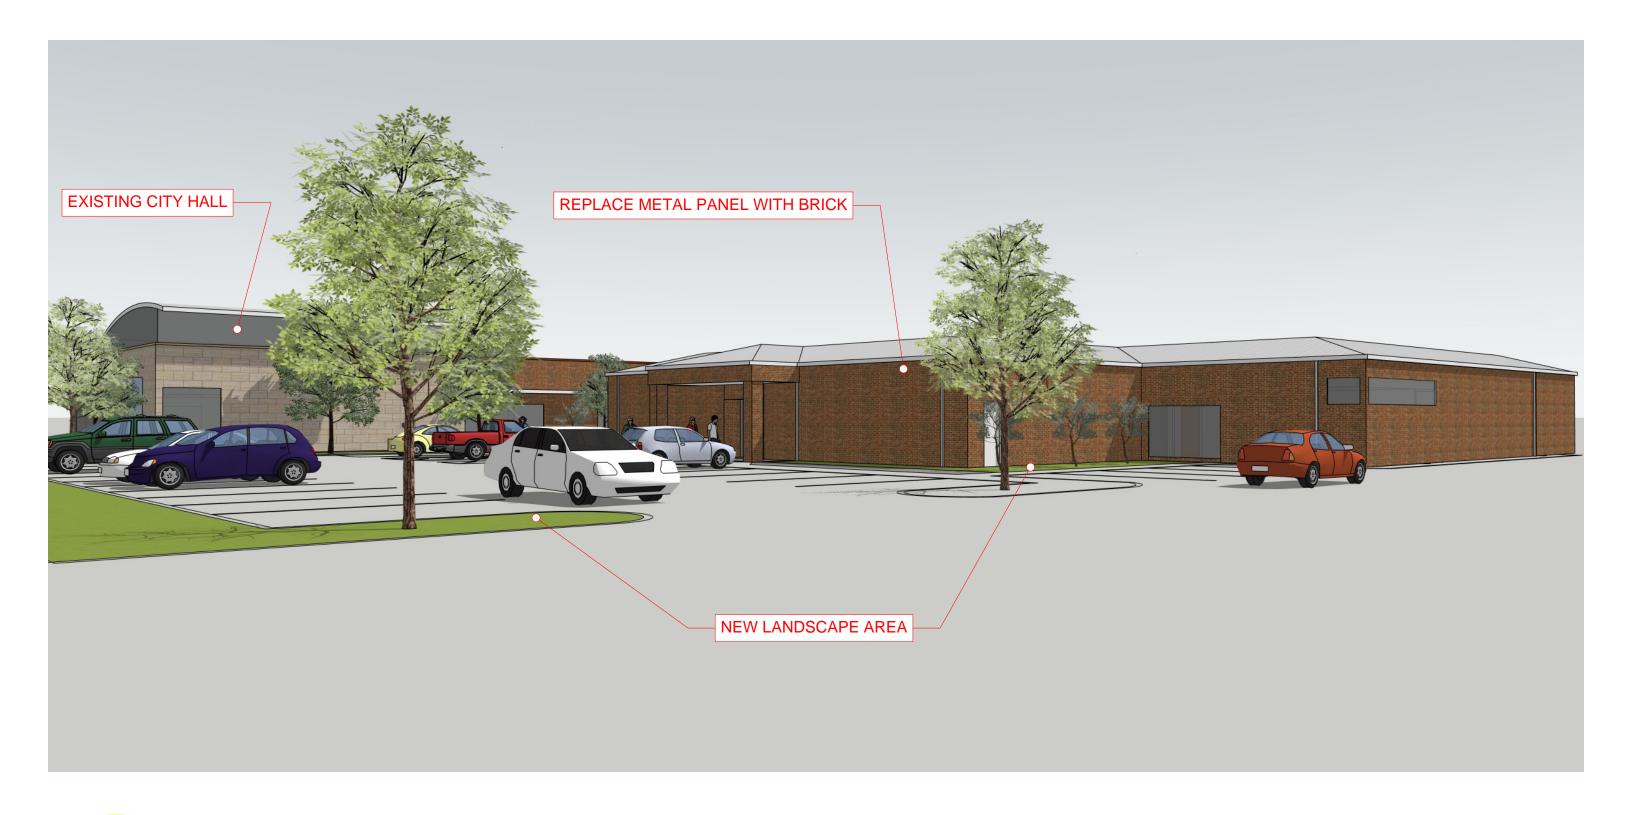






















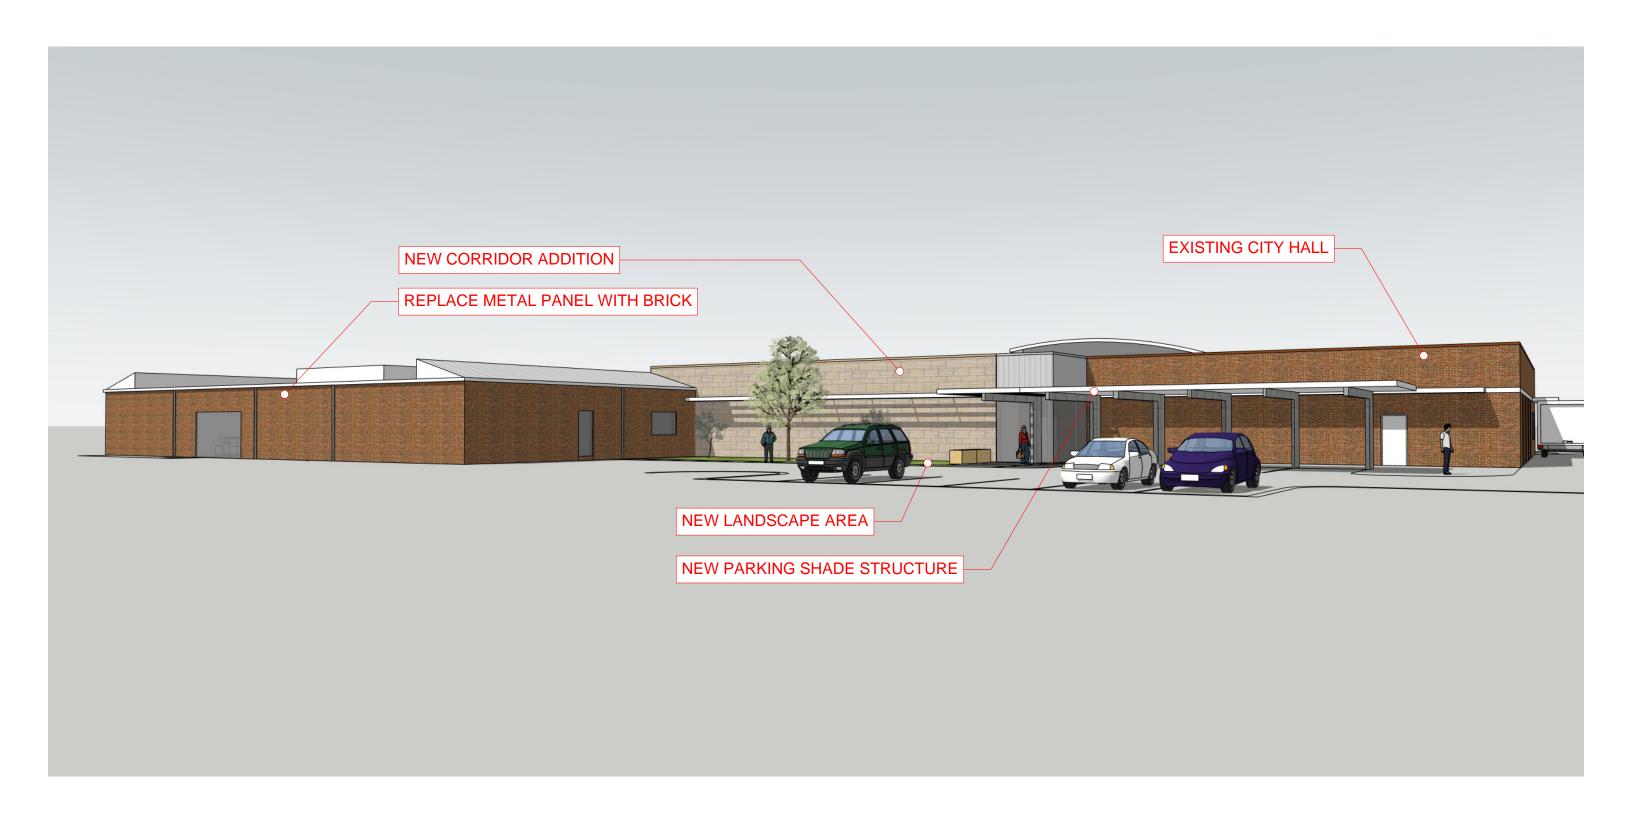

































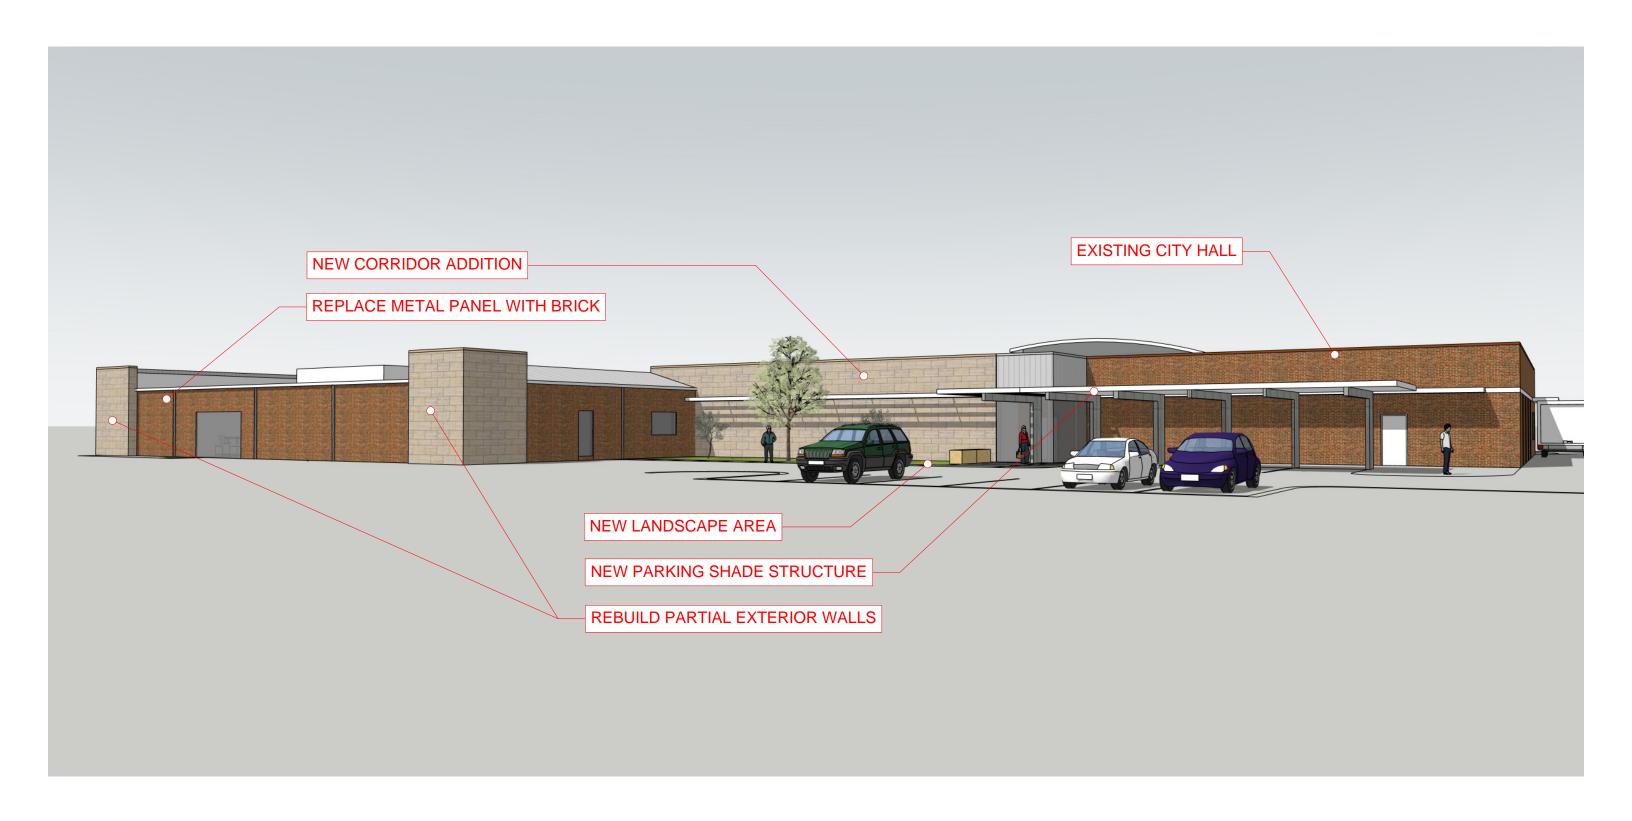





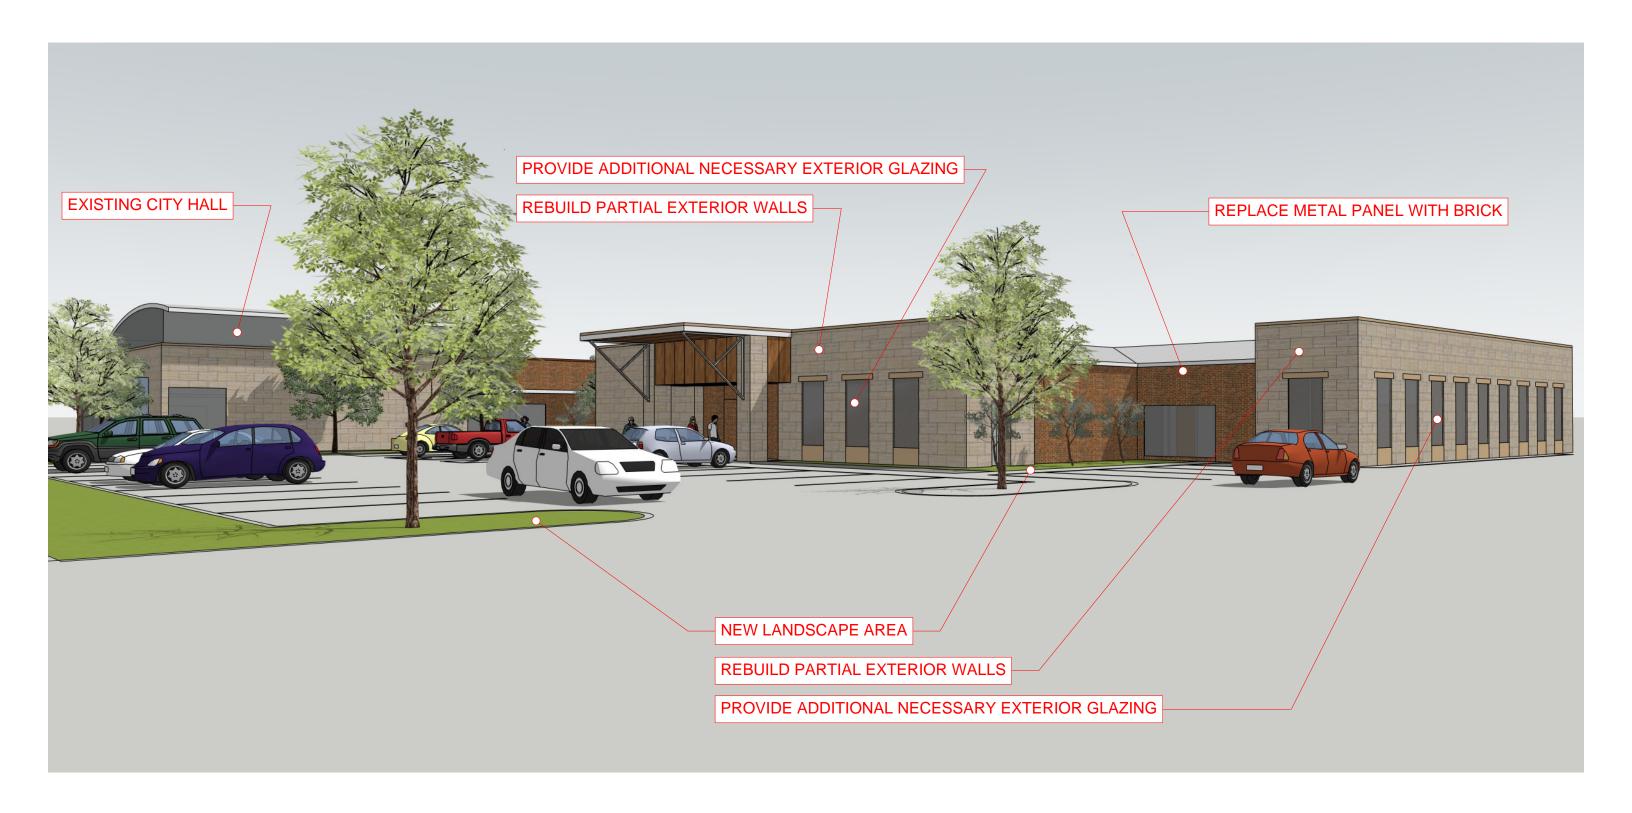












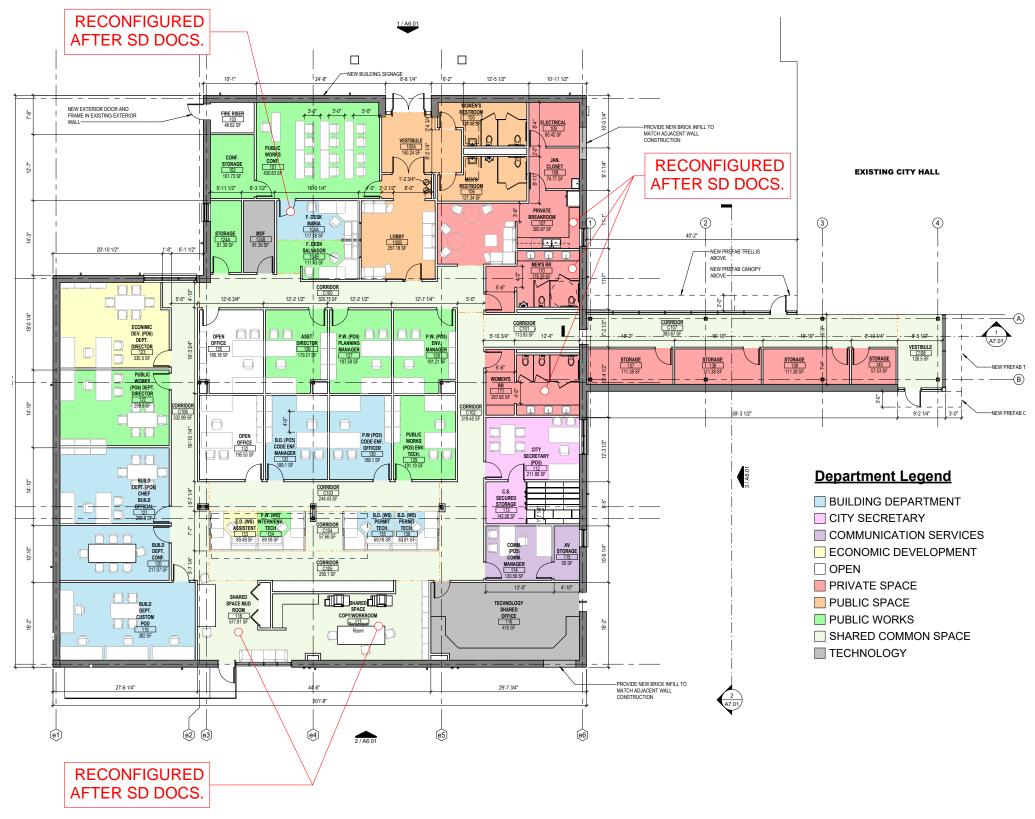




















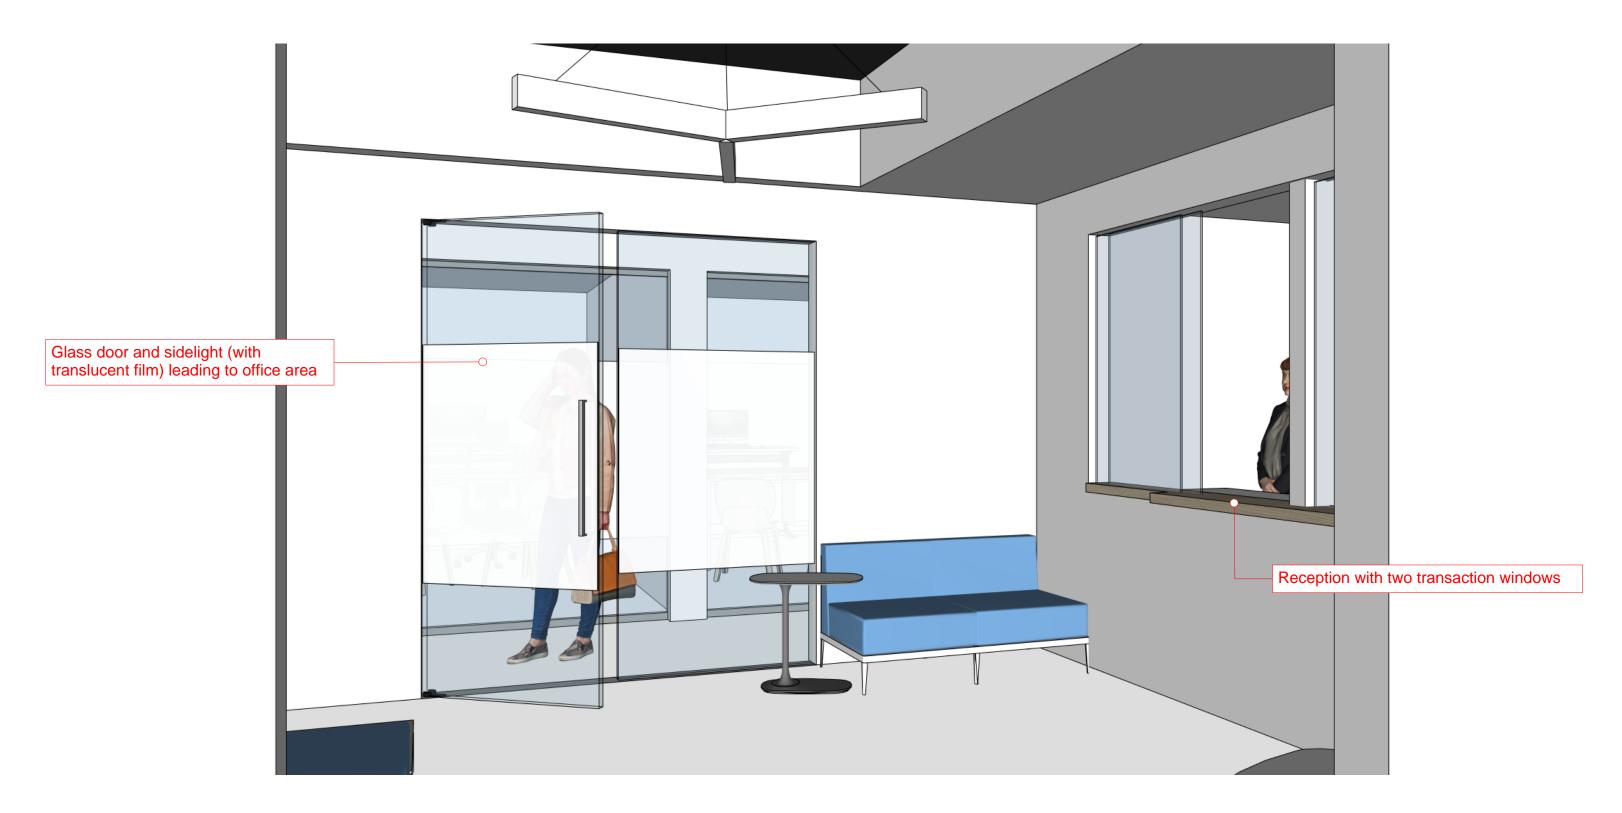



LOBBY | WAITING AREA





MUD ROOM





WORK ROOM









OPEN OFFICE | ASSISTANTS










CORRIDOR C102



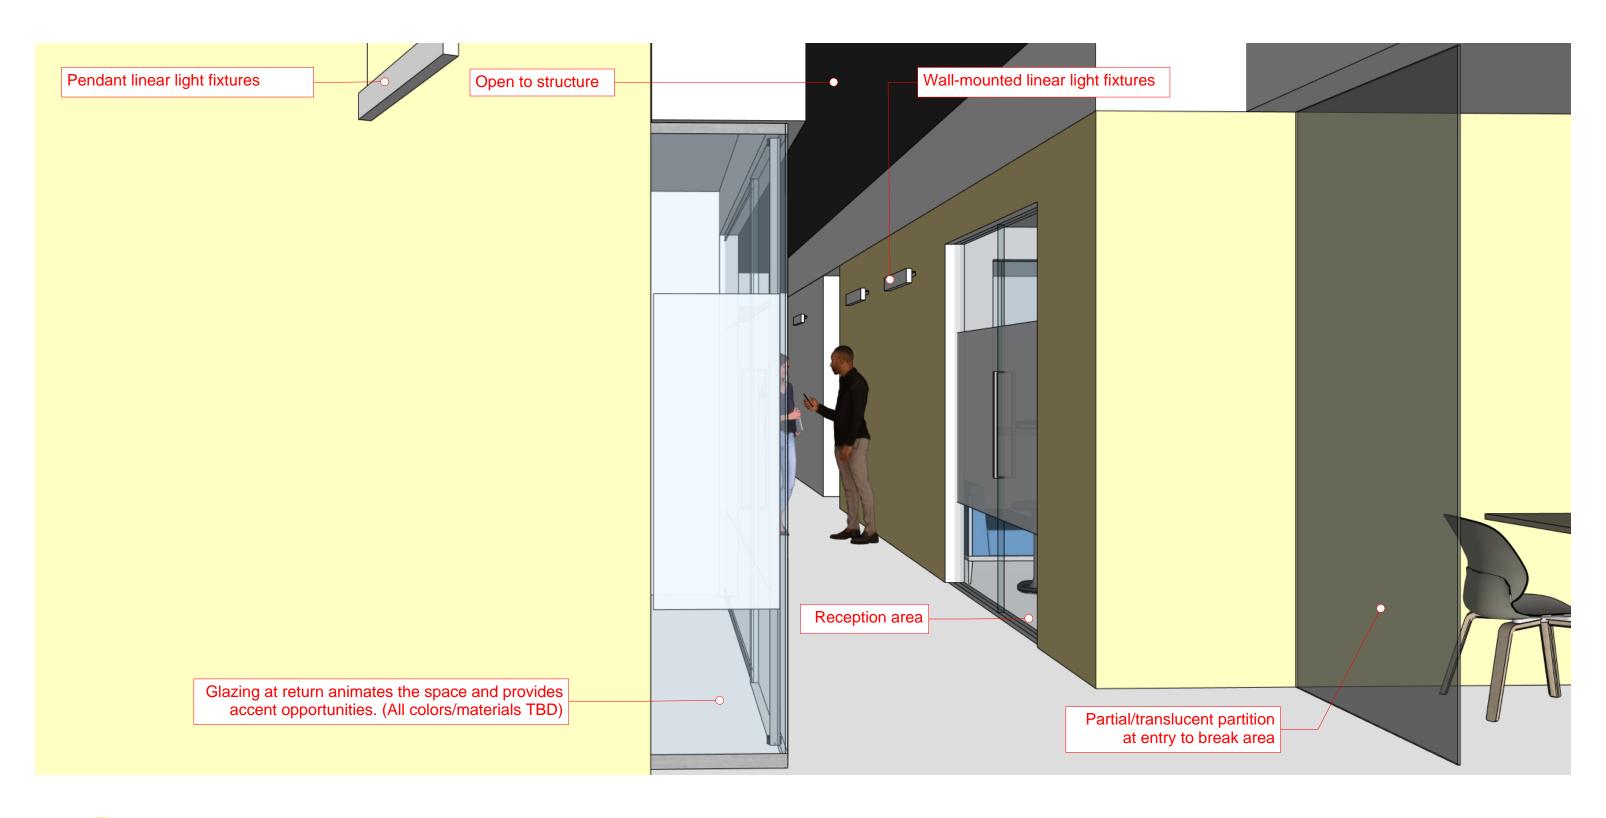



CORRIDOR C100



City Council Memorandum

Prepared By: Janice England

A. Consideration and Action regarding City Council Meeting scheduled for November 5, 2024, Election Day-Janice England, City Secretary

Meeting	Agenda Group							
Tuesday, October 15, 2024, 6:00 PM	Business Item: 4A.							
Reference File								
Community Goals								

BACKGROUND/DISCUSSION:

The next scheduled City Council meeting is November 5, 2024. This is also Election Day and the Library will be a polling location. A high turnout of voters is expected since this is a Presidential Election. The purpose of this item is to give the Council the opportunity to consider the following options: hold the meeting as scheduled, move the meeting to another location, re-schedule the meeting, or cancel the meeting.

FINANCIAL IMPACT:

N/A

RECOMMENDATION:

N/A